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MECHANICAL, ELECTRICAL, PLUMBING: DB ENGINEERING 8509 154TH AVE, SUITE 210 REDMOND, WA 98052 PHONE: 206-934-9508 CONTACT: MATT NIELSEM

LANDSCAPE: **BRUMBAUGH & ASSOCIATES** 600 NORTH 85TH ST., SUITE 102 SEATTLE, WA 98103 PHONE: 206.297.4430 CONTACT: KRISTEN LINDQUIST

iVista@Alderwood

18799 ALDERWOOD MALL PARKWAY LYNNWOOD, WA 98037

PDR SUBMITTAL


MARCH 31 2023

BUILDING ENVELOPE: BUILDING ENVELOPE ENGINEERS (BEE) 170 W. DAYTON ST., SUITE 206 REDMONDS, WA 98020 PHONE: 425.672.3900 CONTACT: PATRICK McMAHON EMAIL: PATRICK@BEE-ENGINEERS.COM

TRAFFIC: TENW - TRANSPORTATION ENGINEERS NORTHWEST 11400 SE 8TH ST., SUITE 200 BELLEVUE, WA 98004 PHONE: 425.466.7072 CONTACT: AMY WASSERMAN EMAIL: AMY@TENW.COM

GEOTECHNICAL: EARTH SOLUTIONS NW, LLC 15365 N.E. 90TH ST., SUITE 100 REDMOND, WA 98052 PHONE: 425.449.4704 CONTACT: RAY COGLAS EMAIL: RAYC@ESNW.COM

<u>ELEVATOR:</u> Fortune Shepler Sailing 3012 154TH ST, SE MILL CREEK, WA 98102 PHONE: 206.618.1725 CONTACT: STEVE MIKKELSEN EMAIL: STEVE.MIKKELSEN@FS2EC.COM

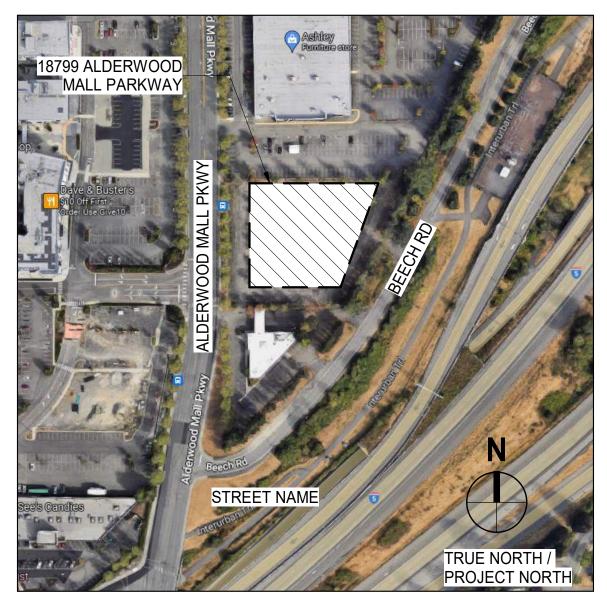

VICINITY MAP




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OWNER NAME

ALDERWOOD **INVESTMENTS LLC**

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SURVEY	
01	SURVEY
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CIVIL

C300 CIVIL SITE PLAN C400 CONCEPTUAL DRAINAGE , GRADING AND UTILITY PLAN

ARCHITECTURE

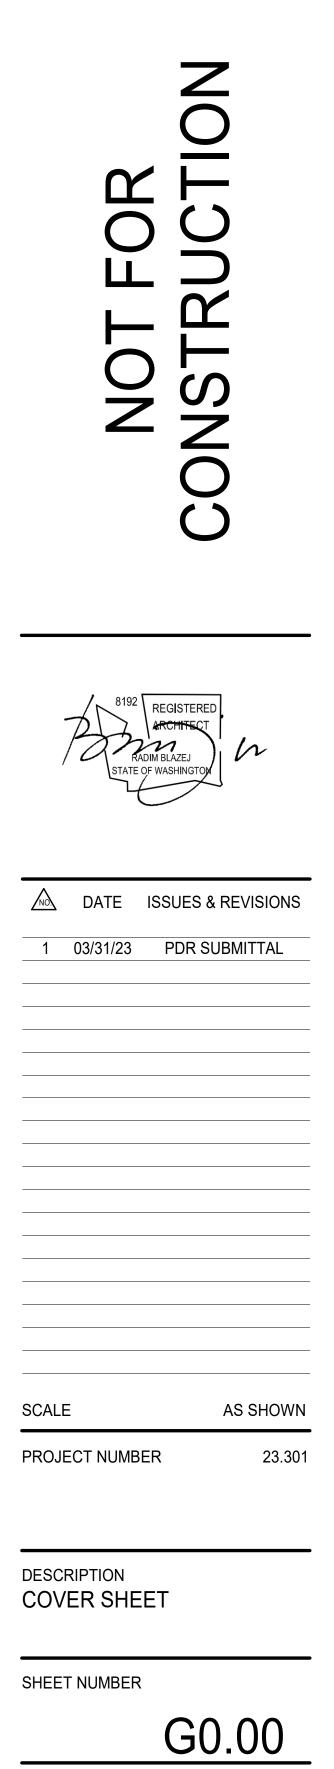A1.01	SITE PLAN
A2.00	BASEMENT PLAN
A2.01	FIRST FLOOR PLAN
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A2.04	FOURTH FLOOR PLAN
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A4.03	BUILDING ELEVATIONS
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A5.03	BUILDING SECTIONS
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LANDSCAPE

TREE PRESERVATION PLAN
MATERIALS PLAN- SITE LEVEL
MATERIALS PLAN- LEVEL3-4
PLANTING PLAN- SITE LEVEL
PLANTING PLAN- LEVEL 3-4
IRRIGATION PLAN - SITE LEVEL
IRRIGATION PLAN - LEVEL 3-4

ELECTRICAL

PH1.0	SITE PLAN
PH1.1	LIGHTING CUTSHEETS
PH1.2	ELEVATION PLANS
PH1.3	ELEVATION PLANS
TOTAL SHEE	T COUNT: 53




PROJECT NAME

iVista@Alderwood

18799 ALDERWOOD MALL PARKWAY LYNNWOOD, WA 98037

OWNER NAME

ALDERWOOD INVESTMENTS LLC

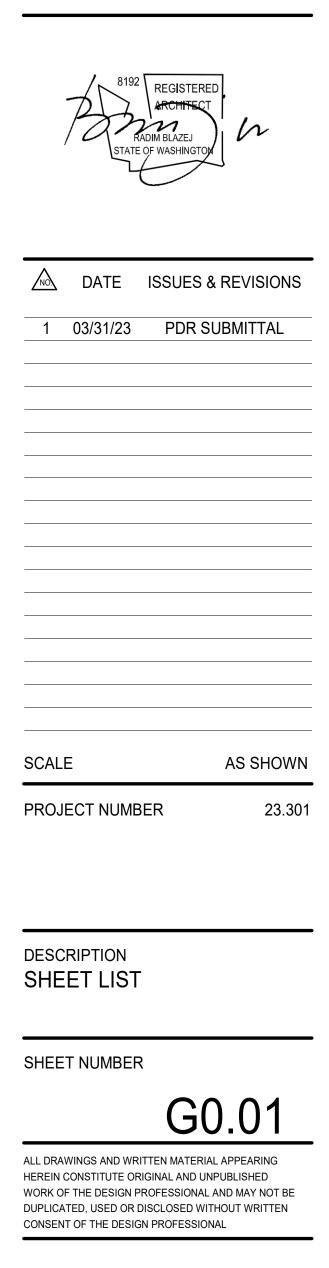

FIRE SEPARATION REQUIREMENTS

	OCCUPAN	ICY SEPARA	ΓΙΟΝ		TABLE 705.8 - FIRE SEPAR	RATION DISTANCE (FSD) AND OPENING PROTECTION
OCCUPANCY	Α	R	S-2, U	B, M, S-1	FIRE SEPARATION DISTANCE	% UNPROTECTED OPENINGS ALLOWED IN SPRINKLERED BUILDING PER CBC TABLE 705.8
Α	-	1	-	1		
R	1	-	1	1	5' ≤ FSD < 10'	25%
S-2, U	-	1	-	1	10' ≤ FSD < 15'	45%
B, M, S-1	1	1	1	-	15' ≤ FSD < 20'	75%
SEPARATION R					20' ≤ FSD	NO LIMIT

TABLE 601 - FIRE-RESISTANCE RATING REQUIREMENTS FOR BUILDING ELEMENTS (HOURS) TYPE I TYPE III **BUILDING ELEMENT** PRIMARY STRUCTURAL FRAME (SEE SECTION 202) BEARING WALLS - EXTERIOR **BEARING WALLS - INTERIOR** NONBEARING WALLS AND PARTITIONS - EXTERIOR SEE TABLE 602 SEE TABLE 602 NONBEARING WALLS AND PARTITIONS - INTERIOR 0 FLOOR CONSTRUCTION AND ASSOCIATED SECONDARY MEMBERS (SEE SECTION 202) ROOF CONSTRUCTION AND ASSOCIATED SECONDARY MEMBERS (SEE SECTION 202)

FIRE-RESISTANCE RATING (HOURS	FSD
1	X < 5
1	5 ≤ X < 10
1	10 ≤ X < 30
0	X ≥ 30

PROJECT SUMMARY

APARTMENT UNIT MATRIX		
NAME	COUNT	
1-BR	16	
1-BR W DEN	5	
2-BR	17	
3-BR	3	
LEVEL 3	41	
1-BR	16	
1-BR W DEN	5	
2-BR	19	
3-BR	3	
LEVEL 4	43	
1-BR	16	
1-BR W DEN	5	
2-BR	19	
3-BR	3	
LEVEL 5	43	
1-BR	16	
1-BR W DEN	5	
2-BR	19	
3-BR	3	
LEVEL 6	43	
1-BR	16	
1-BR W DEN	5	
2-BR	19	
3-BR	3	
LEVEL 7	43	
1-BR	16	
1-BR W DEN	5	
2-BR	19	
3-BR	3	
LEVEL 8	43	
TOTAL	256	

APAR	TMENT UNIT CO	UNT
NAME	COUNT	PERCENTAGE
1-BR	96	38%
1-BR W DEN	30	12%
2-BR	112	44%
3-BR	18	7%
TOTAL	256	100%

ROOM SCHEDULE -UNITS AVARAGE SF			
NAME	AV.		
1-BR			
1-BR	574 SF- 740 SF		
1-BR: 96			
1-BR W DEN			
1-BR W DEN	656 SF - 944 SF		
1-BR W DEN: 30			
2-BR			
2-BR	730 SF -1056 SF		
2-BR: 112	·		
3-BR			
3-BR	1,066 SF - 1,278 SF		
3-BR: 18			


PARKING CALCULATIONS

REQUIRED VEHICLE PARKING

RESIDENTIAL = 256 RESIDENTIAL UNITS REQUESTED PARKING PARKING SPACE PER DWELLING UNIT	
COMMERCIAL= PARKING PER 300 SF - 2400 SF OF RETAIL AREA	

TOTAL PARKING PROVIDED

PARKING COUNT - BY TYPE				
TYPE	COUNT	PERCENTAGE		
ACCESSIBLE				
VEHICLE	4	2%		
	4	2%		
ACCESSIBLE	VAN			
VEHICLE	2	1%		
	2	1%		
COMPACT				
VEHICLE	60	23%		
	60	23%		
EV SPACE				
VEHICLE	10	4%		
	10	4%		
STANDARD				
VEHICLE	188	71%		
	188	71%		
TOTAL	264	100%		

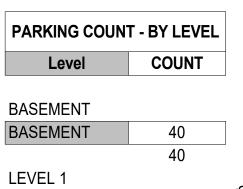

EVEL 1	103 <	∕SITE:31 ∕GARAGE: 7
	103	
EVEL 2		
EVEL 2	121 🧹	
	121	GARAGE: 88
OTAL	264	

1.	STEEL STAIF
2.	GLASS GUAF
3.	EXTERIOR W
Λ	ELEV/ATORS

4.	ELEVATORS
	RESTRAINT
5.	CABLE GUAF

6. GAS SENSOR MONITORING

= 264 SPACES = 264 SPACES

=256 SPACES

= 8 SPACES

11. CAR LIFT

GOVERNING CODES:

OTECTION WED IN BLE 705.8

PARKING REQUIRED-BICYCLE

BICYCLE PARKING

BICYCLE	COUNT
ТҮРЕ	NO. OF STALLS
BICYCLE	
LONG-TERM	110
SHORT TERM	2
TOTAL	112

GROSS BUILDING & OCCUPANCY AREAS

GROSS BUILDING AREA		
LEVEL	LEVEL AREA	
В		
LEVEL 1	2,399 SF	
R-2		
LEVEL 1	6,452 SF	
LEVEL 2	4,307 SF	
LEVEL 3	41,832 SF	
LEVEL 4	41,854 SF	
LEVEL 5	41,854 SF	
LEVEL 6	41,854 SF	
LEVEL 7	40,887 SF	
LEVEL 8	40,238 SF	
S-2		
LEVEL 1	40,372 SF	
LEVEL 2	39,771 SF	
TOTAL:	341,819 SF	

SEPAR
SCALE: 12" = '

2. MECHANICAL WORK 3. ELECTRICAL WORK

- 4. PLUMBING WORK

NUMBER	NAME	Level
-BR		
345	1-BR	LEVEL 3
145	1-BR	LEVEL 4
545	1-BR	LEVEL 5
645	1-BR	LEVEL 6
ļ		
1-BR W DEN		
732	1-BR W DEN	LEVEL 7
332	1-BR W DEN	LEVEL 8
2		
2-BR		
327	2-BR	LEVEL 3
427	2-BR	LEVEL 4
527	2-BR	LEVEL 5
637	2-BR	LEVEL 6
737	2-BR	LEVEL 7
5		·
3-BR		
417	3-BR	LEVEL 4
517	3-BR	LEVEL 5

Grand total: 13

DEFERRED SUBMITTALS

THE FOLLOWING ARE DESIGN/BUILD ENGINEERING SYSTEMS AND WILL BE DEFERRED PERMIT SUBMITTALS TO THE AUTHORITY HAVING JURISDICTION:

IRS, STEEL HANDRAILS, AND GUARDRAILS

RDRAILS & WINDSCREENS WINDOW WALL AND STOREFRONT SYSTEMS

S AND EQUIPMENT ANCHORAGE, VIBRATION ISOLATION, AND SEISMIC

RDRAILS

7. NON-STRUCTURAL METAL STUD FRAMING

8. COLD FORMED METAL STUD FRAMING SYSTEM (EXTERIOR) 9. EXTERIOR, INTERIOR, WAYFINDING & CODE REQUIRED SIGNAGE. (EXCEPT

EMERGENCY EXIT SIGNS) **10. PT STRANDS AND ANCHORAGE**

12. EXTERIOR FINISH SYSTEM ATTACHMENT

13. EMERGENCY GENERATOR ANCHORAGE AND AQMD APPROVAL

CODE REFERENCE

* 2018 WASHINGTON STATE BUILDING CODE

* 2018 WASHINGTON STATE ENERGY CODE

* 2009 ICC/ANSI A117.1 ACCESSIBILITY STANDARDS

*ALL OTHER CURRENT MUNICIPAL AND LOCAL ORDINANCES AND REGULATIONS

RATE PERMITS 1'-0"

1. TEMPORARY SHORING SYSTEMS AND GRADING/EXCAVATION

5. FIRE SPRINKLER SYSTEM (NFPA 13) 6. FIRE ALARM / SMOKE ALARM SYSTEM AND COMPLYING WITH 403.3

7. EMERGENCY VOICE / ALARM COMMUNICATION SYSTEM

8. EMERGENCY RADIO RESPONDER COVERAGE

9. WINDOW WASHING SYSTEMS AND TIE-DOWN ANCHORS (FACADE ACCESS) 10. RETAINING WALLS / BLOCK FENCE WALLS

11. PEDESTRIAN PROTECTION PLAN 12. EMERGENCY GENERATOR AND FUEL TANK

OCCUPANCY AREAS		
OCCUPANCY	AREA	
A-2	6,878 SF	
A-3	12,024 SF	
В	433 SF	
Μ	2,400 SF	
R-2	203,730 SF	
S-2	71,881 SF	
TAL	297,345 SF	

PROJECT SCOPE

PROJECT CONSISTS OF:

THE PROPOSED PROJECT IS AN 8 STORY, 256-UNIT APARTMENT BUILDING WITH 2,400 SF OF RETAIL AT THE GROUND FLOOR. THERE IS A SURFACE PARKING AREA WITH 31 STALLS, AND IN-BUILDING PARKING ON LEVELS 1 & 2 WITH PARTIAL BELOW GRADE BASEMENT PARKING. TOTAL PARKING FOR THE PROJECT 264 STALLS.

RESIDENTIAL DWELLING UNITS WITH 1, 2 AND 3 BEDROOM UNITS. THE AMENITY SPACES WILL CONSIST OF AN 8,000 SF OPEN COURTYARD THAT WILL HAVE OUTDOOR SEATING AREAS, BARBEQUE, AND WILL BE FULLY LANDSCAPED. INSIDE AMENITIES ARE A 3,500-SF FITNESS CENTER, A CLUBROOM WITH A FULL KITCHEN, AND A MOVIE ENTERTAINMENT ROOM.

THE CONSTRUCTION OF THE PROJECT IS ANTICIPATED TO START IN EARLY 2024 AND TO BE COMPLETED IN MID-2026.

PROJECT DATA SUMMARY

PROJECT NAME: iVISTA ALDERWOOD

PROJECT ADDRESS: 18799 ALDERWOOD MALL PARKWAY LYNNWOOD, WA 98037 LOT LEGAL DESCRIPTION:

THE SOUTH 255 FEET OF THE NORTH 530.25 FEET, AS MEASURED ALONG THE WEST LINE, OF THAT PORTION OF LOTS 13 AND 14, BLOCK 4, ALDERWOOD MANOR NO. 3, ACCORDING TO THE PLAT THEREOF RECORDED IN VOLUME 9 OF PLATS, PAGE(S) 74 THROUGH 76, INCLUSIVE, RECORDS OF SNOHOMISH COUNTY, WASHINGTON, LYING NORTHWESTERLY OF P.S.H. NO. 1 (SR 5);

EXCEPT THAT PORTION THERE OF CONVEYED TO THE CITY OF LYNNWOOD FOR ROAD BY DEED RECORDED UNDER AUDITOR'S FILE NO. 2116457, RECORDS OF SNOHOMISH COUNTY, WASHINGTON;

(ALSO KNOWN AS PARCEL C OF SHORT PLAT RECORDED UNDER AUDITOR'S FILE NO. 7811130408).

SITUATE IN THE COUNTY OF SNOHOMISH, STATE OF WASHINGTON.

PARCEL NO.: 00372800401301

SITE AREA: 81,668 SF (1.874 ACRES)

SITE DESCRIPTION:

THE PROJECT SITE IS LOCATED APPROXIMATELY 400' NORTH OF THE INTERSECTION BETWEEN BEECH ROAD AND ALDERWOOD MALL PARKWAY IN LYNNWOOD, WASHINGTON. THE PROPERTY IS TRAPEZOIDAL IN SHAPE AND IS COMPRISED OF ONE TAX PARCEL (SNOHOMISH COUNTY PARCEL NO. 00372800401301) TOTALING APPRXIMATELY 1.88 ACRES.

THE SITE IS SURROUNDED TO THE NORTH BY AN ASHLEY FURNITURE STORE, TO THE EAST BEECH ROAD, TO THE SOUTH BY AN EXISTING VACANT ONE-STORY BUILDING (SOON TO BE A STARBUCKS), AND TO THE WEST BY ALDERWOOD MALL PARKWAY. THE SITE HAD A MEDICAL CENTER BUILDING LOCATED ON IT BUT HAS SENCE BEEN DEMOLISHED. THE SITE TOPOGRAPHY IS RELATIVELY LEVEL WITH LITTLE TO NO DISCERNIBLE ELEVATION CHANGE. THE VEGETATION IS SPARSE AND IS COMPRISED PRIMARILY OF TREES AND SHRUBS AROUND THE PERIMETER.

THE EXISTING PARKING LOT ASPHALT FROM THE PROVIOUS USE IS STILL IN PLACE. COMMUNITY PLAN AREA: ALDERWOOD MALL

ZONING: PRC - PLANNED REGIONAL SHOPPING CENTER

TYPE OF CONSTRUCTION: 5 LEVELS OF TYPE IIIA OVER 3 LEVELS OF TYPE IA

OCCUPANCY GROUP:

BASEMENT	
PARKING	GROUP S-2
<u> 1ST FLOOR</u> = I	MIXED USE OCCUPANCY
RESIDENTI	AL LOBBY, LEASING, AMENITY
ACCESSORY 1	ГО R-2
RETAIL	GROUP M

<u>2ND FLOOR</u> PARKING GROUP S-2 AMENITY ACCESSORY TO R-2

3RD FLOOR OUTDOOR & INDOOR AMENITIES GROUP A-3 APARTMENTS GROUP R-2

4TH - 8TH FLOOR APARTMENTS GROUP R-2

FIRE / LIFE SAFTY REQUIREMENTS

SECONDARY WATER SUPPLY: YES

FIRE DETECTION: ALARM SYSTEM WITH VOICE EVACUATION IN LOW RISE & HIGH RISE **SMOKE DETECTION:** SYSTEM IN LOW RISE AND HIGH RISE FIRE EXTINGUISHING SYSTEM: AUTOMATIC SPRINKLER - INSTALLED PER NFPA 13 -FULLY SPRINKLERED

STANDPIPE SYSTEM: CLASS 1 SMOKE CONTROL: YES

BUILDING HEIGHT / NO. OF STORIES

GRADE PLANE

LOT GRADE MEANS THE AVERAGE OF THE FINISHED GROUND LEVEL AT THE CENTER OF ALL EXPOSED WALLS OF THE BUILDING. IN CASE WALLS ARE PARALLEL TO AND WITHIN FIVE FEET OF THE SIDEWALK, THE ABOVE GROUND LEVEL SHALL BE MEASURED AT THE SIDEWALK. (ORD. 2020 § 2, 1994; ORD. 190 ART. IV § 407, 1964) LOT GRADE CALCULATION:

NORTH (A)= 408.5, EAST (B)= 409.00, SOUTH (C)=409.5, WEST (D)=409.0 408.5+ 409.00+409.5+409=1,636

1636/4= **<u>409.00</u> BUILDING CODE HEIGHT: 85'**

BUILDING HEIGHT PROPOSED (FROM GRADE PLANE): 494.00'

ALLOWABLE HEIGHT: 75' ABOVE Height to highest occupied floor @484.50' (Assumed level of fire department access = L1 Floor Level)

LOWEST GRADE POINT FOR FIRE ACCESS: 409.50'

HIGHEST OCCUPIED FLOOR HEIGHT: 482.83'

NUMBER OF STORIES PROPOSED: 6 OCCUPIED RESIDENTIAL, 2 PARKING AND 1 BASEMENT PARKING

BUILDING SETBACKS

BUILDING SETBACKS:

AREA ANALYSIS

ALLOWABLE FLOOR AREA:

GROUP A-2/A-3, TYPE I-B At = UNLIMITED S.F./FLOOR GROUP B, TYPE I-B At = UNLIMITED S.F./FLOOR GROUP M, TYPE 1-B At = UNLIMITED S.F./FLOOR GROUP R-1, TYPE I-B At = UNLIMITED S.F./FLOOR GROUP S-2, TYPE I-B At = 237,000 S.F./FLOOR




PROJECT NAME

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OWNER NAME

ALDERWOOD **INVESTMENTS LLC**



VIEW OF SOUTH WEST CORNER

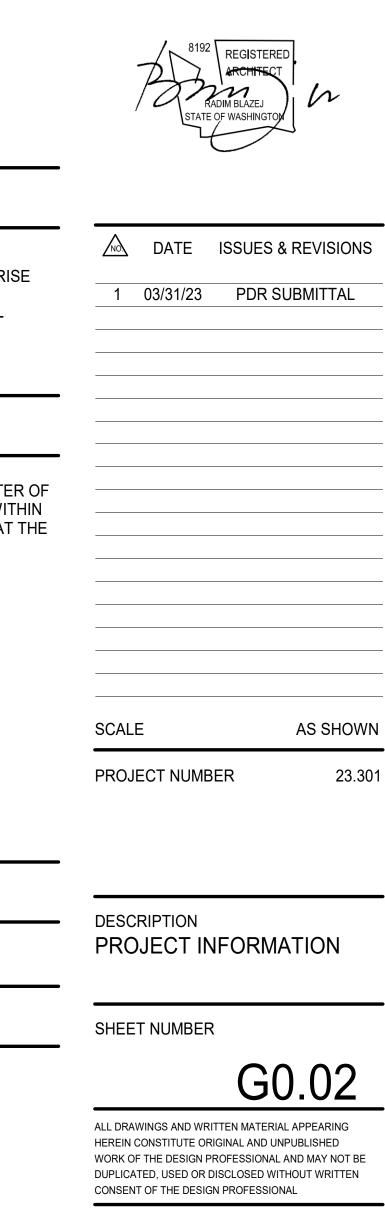

VIEW OF WEST





PROJECT NAME

iVista@Alderwood

18799 ALDERWOOD MALL PARKWAY LYNNWOOD, WA 98037

OWNER NAME

ALDERWOOD INVESTMENTS LLC

8192 REGISTERED ARCHITECT RADIM BLAZEJ STATE OF WASHINGTON
DATE ISSUES & REVISIONS
1 03/31/23 PDR SUBMITTAL
SCALE AS SHOWN
PROJECT NUMBER 23.301
DESCRIPTION RENDERINGS
SHEET NUMBER
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VIEW OF NORTH WEST CORNER



VIEW OF SOUTH EAST CORNER



PROJECT NAME

iVista@Alderwood

18799 ALDERWOOD MALL PARKWAY LYNNWOOD, WA 98037

OWNER NAME

ALDERWOOD INVESTMENTS LLC

REGISTERED ARCHITECT RADIM BLAZEJ STATE OF WASHINGTON
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G0.03B
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VIEW OF NORTH EAST CORNER



PROJECT NAME

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VIEW OF RETAIL ENTRY / PLAZA



VIEW OF NORTH WEST GARAGE ENTRY



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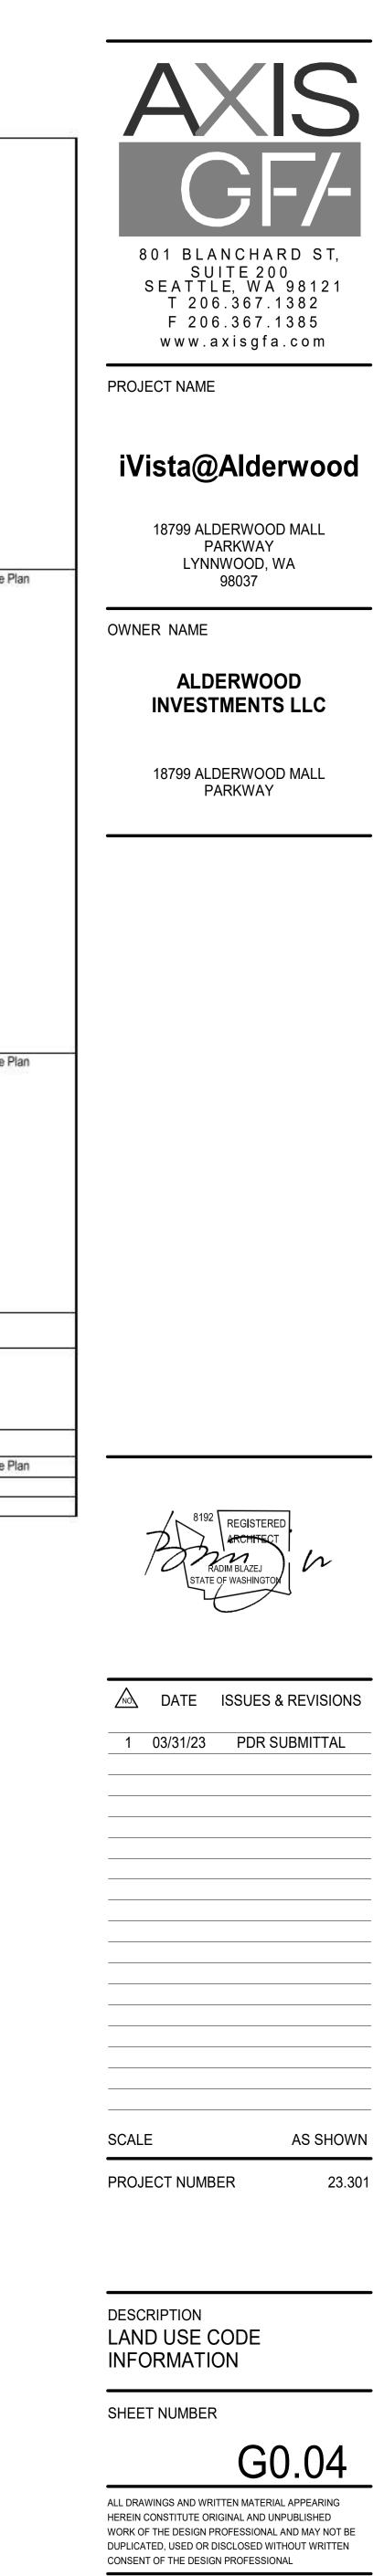
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PROJECT ADDRESS JURISDICTION ZONE	CITY OF LY	NNWOOD	ARKWAY, LYNNWOOD, WA 98037 SHOPPING CENTER					
ZONING ANALYSIS DATED CODE CONTENT SOURCE	3/31/2023							
APPLICABLE SECTION	111223.71411		CODE REQUIREMENT					
GENERAL LANDSCAPE STANDARDS	21.08.300	F	 Pedestrian connections and walkways may traverse landscaped areas. All areas of a landscape bupedestrian sidewalk, path, or vehicular driveway. Pedestrian connections are encouraged across landscaped areas to connect multifamily and single commercial zones, for ease of resident access to grocery, retail, and other commercial businesses. Su 					
PARKING AREA AND LANDSCAPE STANDARDS	21.08.350	A	The parking area landscaping standards in this section explain the zones, location, and amount of land and outdoor display areas.					
PARKING LOT INTERIOR LANDSCAPING		c	 Landscaping within the interior of a surface parking lot area is intended to reduce the visual blight th absorption, and reduce the urban heat island effect. For surface parking lot interior landscaping types, 99 Mixed Use zone (HMU): Interior landscaping areas shall be at least 25 square feet in area and at least three feet wide. No parking stall shall be located more than 45 feet from a landscaped area. All interior landscaping must be located between parking stalls or at the end of striped parking coluid. Interior landscaped islands or peninsulas must be surrounded on at least three sides by parking lot 					
PARKING LOT DEVELOPMENT STANDARDS	21.18.700	c	 C. Compact Car Parking (also see LMC 21.18.820). 1. In sites with 10 or more stalls, up to 20 percent of the number of stalls required by this chapter may contained in this section. 2. Compact stalls shall be restricted to, and signed or marked for, employee, student or resident use of other frequent parking turnover users shall be full-size. Pavement markings, if used, must be maintained. 3. Stalls provided in excess of the minimum number required by this chapter may be compact stalls. 4. Compact stalls shall be clearly designated for compact car use only with signs and/or pavement matches the stall shall not be adjacent to fire lanes unless the stall is parallel (stall angle zero degree). 					
		5	Handicapped Accessible Stalls. Handicapped accessible parking shall be provided in accordance with 50 WAC. Accessible stalls count toward the parking capacity requirements of LMC 21.18.800.					
	01.10.710	E	Pedestrian Access. Paved pedestrian access walkways shall be provided between streets and sidewa entrance(s) in accordance with the standards of the Lynnwood citywide design guidelines.					
PARKING STRUCTURE DEVELOPMENT STANDARDS	21.18.710	A.1.	In the PRC, CG and PCD zones, 50 percent of the square footage of the ground-level floor of the park 100 percent of the square footage of the ground-level floor shall be counted toward lot coverage. Exterior Elevations.					
			 The exterior colors and materials of a parking structure shall match or complement those of the properties of the architectural design of the structure's exterior (including the use of colors and materials), if not complement other buildings in the project. When viewed together, the main building(s) and parking structure buildings into a well-coordinated and visually pleasing streetscape. Regardless of the interior or structural design of the structure, exterior horizontal facade elements a may necessitate placing facades on the exterior walls. Horizontal exterior facades 30 feet or longer shall be treated or designed so long, continuous horizon. The apparent builk of the structure shall be reduced by setting back floors above the third level. Low walls, facades or other improvements (at least three and one-half feet high) shall be installed a not visible from ground level and adjoining buildings. Landscaping may be installed (in planter boxes) exterior appearance of the parking structure. 					
		D	 Ground Floor 1. Vehicle Access. No parking structure entry/exit driveway shall have more than three additional drive lane. In no case shall the number of lanes exceed four. 2. Street Frontage. a. Where a parking structure is directly adjacent to a street parking may be located along the street from street a minimum of 25 feet. b. The 25-foot setback shall be landscaped as required by LMC 21.08.400(A). 3. Pedestrian Connections. The design of pedestrian connections or pathways from a parking structure delineate and separate the pedestrian way from travel areas for vehicles. 					
PARKING CAPACITY REQUIREMENTS	21.48.210	A.2	Residential parking shall have a minimum of one and a maximum of one and one-half spaces per dwe services director based upon data submitted by the applicant.					
OFF-STREET PARKING	21.18.855		 Retail Uses: 1 per 300 SF gross leaseable area. A. Purpose. Bicycle parking is intended to encourage the use of bicycles by providing safe and conveparking based on the demand generated by different uses and the level of security necessary to encours. B. Bicycle Parking Ratio. For developments with 20 or more required automobile parking stalls, the nu 21.18.800 may be reduced by one stall for every five bicycle parking stalls provided that meet the required five percent of all automobile parking stalls required. C. Type of Bicycle Parking Required. Categories of bicycle parking required for each type of use shall 1. A "Class 1 bicycle facility" means a bike locker, or other individually locked enclosure, or a supervise therein from theft, vandalism and weather. 2. A "Class 2 bicycle facility" means an outdoor bike rack or stand constructed and located in accorda D. Design and Location of Bicycle Parking Facilities. 1. Each bicycle parking stalls hall be no less than six feet long by two feet wide and shall have a bike 2. Bike racks and cable locks. Racks shall support the bikes in a stable upright position so that a b primarily by a wheel, such as standard "wire racks," are damaging to wheels, thus not acceptable. 3. Outdoor bicycle parking shall be located in close proximity to the building or facility entrance(s) and cluste b Bicycle parking should be located in close proximity to the building or facility entrance(s) and cluste b. Bicycle parking should be located in highly visible, well-lighted areas to minimize theft and vandalis. c. Bicycle parking should be located in highly visible, well-lighted areas to minimize theft and vandalis. c. Bicycle parking should be located in highly visible, well-lighted areas to minimize theft and vandalis. c. Bicycle parking is side-by-side in rows, there shall be an access aisle at least six feet wide to the e. Bicycle parking is side-by-side in rows, there shall be an access aisle at least s					
ELECTRIC VEHICLE PARKING	21.18.930		 Use. Electric vehicle charging station spaces shall be reserved for parking and charging electric vehicle for that purpose (see subsection (B)(4)(a) of this section for sign provisions) if the charging station has Number. There is no minimum required number of charging station spaces. Size. Where provided, spaces shall be standard (e.g., not compact) size stalls. 					
COMMERCIAL ZONES	21.46		Multiple-Family Housing. Dwellings may be permitted, consistent with the use and development regula					

	NOTES / COMMENTS
pe buffer strip must be landscaped except where occupied by a	Complies - Refer to Landscape Plans
single-family residential zones, to commercial zones, and between es. Such pedestrian connections must be no wider than five feet.	
of landscaping required for parking lots, service yards, parking structures,	Complies - Refer to Landscape Plans
ight that large, unbroken areas of pavement create, increase stormwater	Complies - Refer to Landscape Plans
ypes, the following standards shall apply to all zones except the Highway	
ing lot surface.	
r may be designed for compact cars in accordance with the specifications	Complies - Refer to sheet G0.02, A2.00, A2.01, A2.02, A2.03
t use only. Parking stalls for customers, patients, guests, deliveries and intained in a clear and readable condition. talls. ent markings.	
egrees) to the direction of traffic flow in the fire lane.	
e with the requirements of the International Building Code per Chapter 51-	Complies - Refer to sheet G0.02, A1.01, A2.00
idewalks and building entrances, and between parking lots and building	Complies - Refer to Landscape Plans
e parking structure shall be counted toward lot coverage. In all other zones,	
er De deriver andarische der die der der die der die	Complies - Refer to sheet A4.00, A4.01, A4.02,
he project for which it provides parking to the maximum extent feasible. if not matching the design of adjoining buildings, should visually ng structure(s) should create an overall design character that integrates all	A4.03
ents shall be level and not sloped. Masking or concealing sloping ramps	
horizontal surfaces do not dominate the structure's appearance.	
alled around all sides of all levels of the structure so parked vehicles are exes) on top of such walls to provide additional screening and soften the	
three lanes unless exceptional traffic conditions or congestion require an	Complies - Refer Site Plan sheet A1.01
eet frontage; provided, that the parking structure is set back from the	
tructure to the building(s) for which it provides parking shall clearly	
r dwelling unit or as determined by the development and business	Complies - Refer sheet G0.02
	Complies - Refer sheet G0.02
convenient places to park bicycles. These regulations encourage bicycle	Complies - Refer sheet G0.02, A2.01. A2.02
encourage the use of bicycles for short or long stays. the number of automobile parking stalls otherwise required by LMC e requirements of subsections (C) and (D) of this section up to a maximum	
e shall be in accordance with the following: pervised area within a building providing protection for each bicycle	
cordance with subsection (D) of this section.	
bike rack system. irame and at least one wheel of each bicycle. Racks must be easily usable nat a bike, if bumped, will not fall or roll down. Racks that support a bike	
et to the floor or lot surface so they cannot be easily removed and	
clustered in lots not to exceed 20 stalls each.	
ndalism. parking should be incorporated into building design or street furniture.	
o the front or rear of each stall. as curbs, wheel stops, stanchions, fences, or similar to protect bicycles	
un de servité un disse déserve d'hépondérie des égyétététététététététététététététététété	
ric vehicles only during times the charging space is made available solely	Complies - Refer sheet G0.02, A2.02
ind vehicles only during times the charging space is made available solery in has time limitations for its use.	oomprida - Nordr ander Gu.U2, M2.U2
regulations for multiple-family dwellings in the PCD zone.	Complies

LIMITATION ON USES - RESIDENTIAL UNITS	21.46.116	B
DEVELOPMENT STANDARDS	21.46.200	
OTHER REGULATIONS	21.46.900	
PLANNED REGIONAL SHOPPING CENTER ZONE	21.48	
PROJECT DESIGN REVIEW	21.48.105	
LIMITATIONS ON RESIDENTIAL USES	21.48.116	В
DEVELOPMENT STANDARDS		A B C
	21.48.200	

						Comello
Multiple-Family Housing. 1. For properties zoned NC, dwellings may be permit multiple-family housing shall apply.						Complies
For properties zoned PCD, dwellings may be perm a. General commercial, office, or similar land uses or						
b. Not more than 20 percent of the linear frontage of						
residences. c. Floor area at ground level limited to general comm						
facade, so that the floor area may be occupiable for no d. For development sites where the building is not ac						
dwellings to be located below the second floor of the t						
properties subject to the provisions of this chapter, de dwelling. The on-site recreation area shall consist of a						
a. Individual patio, deck or balcony immediately adjac						
foot square will fit within the perimeter of the patio, de b. Outdoor recreation area accessible to all residents		ned so th	at a 15-fo	ot-by-15-fc	oot square will fit within the perimeter of the outdoor	
recreation area. Common outdoor recreation areas sh structure: and sport court. Outdoor recreation areas m				10 C C M (C C C C C C	seating; lighting; rooftop garden; children's play closed. Landscaping required within parking areas shall	
not be considered outdoor recreation area.	13 0					
c. Indoor recreation space accessible to all residents recreation areas shall include furnishings and fixtures	5월 전 전 17월				ot square will fit within the indoor recreation area. Indoor or games: sports: bobbies and crafts: and video	
entertainment.		unuruuu,	or more of the	picy, moo	a games, opera, noosies and cland, and nade	
						Complies - Refer sheet A1.01, Site Pla
	Table 21,46.14 Development Stan					
		NC	PCD	CG		
Minimum Are	a	none	none	none		
Minimum Fre	nt Yard Setback	15 ft.	15 ft.	15 ft.		
Minimum Sid	e Yard Setback - Street	15 ft.	15 ft.	15 ft.		
Minimum Sid	e Yard Setback - Abutting to	10.ft.	25 ft.	25 ft.		
RS Zone						
RM Zone	e Yard Setback – Abutting to	10 ft.	15 ft.	15 ft		
Minimum Sid other zones	e Yard Setback - Abutting all	none	none	none		
Minimum Re RS Zone	er Yerd Setback - Abutting to	25 ft.	50 ft.	50 ft.		
Minimum <u>Re</u> RM.Zone	ar Yard Setback - Abutting to	25 ft.	25 ft.	25 ft.		
Minimum Re- other zones	er Yard Setback - Abutting all	none	none	none		
Maximum Bu	ilding Height	35 ft.‡	none	none		
Maximum Lo	t Coverage	35%	none	35%		
LMC 21.25.145(B)(3), that may conflict: a. Set back a minimum of 25 feet from a public street 2. Enclosure. All refuse and recycling collection areas design details similar to the primary buildings on the s berm (height measured from bottom inside edge of the enclosure includes a gate made of metal chain link fer alternative design may be approved if it is determined	ble setback requirements of the s shall be enclosed on three si ite and a six-foot-high gate on e collection area). The enclose incing, the fencing shall contain that such alternative would pr nall be located in such a way the	is chapter des by a s one side. ure shall ir n slats whi ovide equinat new or	and any six-foot-hig The heigt clude a g ch screen al or bette existing p	Lynnwood gh sight-ot ht of the er ate which the view or screenin parking sta	Citywide Design Guidelines, as adopted by reference in escuring fence which uses building materials, color, and inclosure may include the height of a surrounding slope or can be secured in an open or closed position. If the of containers and materials inside the collection area. An g, architectural compatibility, and containment. ills will prevent or interfere with the use and servicing of	Complies - Refer sheet A1.01, Site Pla
B. Design Guidelines for Multiple-Family Lises. Const	ruction of any multiple-family	structure	r building	including	duplexes (two-family dwellings) permitted outright or by	
지 않는 것 같은 것 같	g center zone shall comply w	th Lynnwo	od Citywi	de Design	Guidelines for All Districts and Multi-family Districts, as	
 Multiple-Family Housing. Dwellings may be permitted,	consistent with the use and d	evelopme	nt regulati	ions for mi	ultiple-family dwellings in the PCD zone	Complies
 		100	71.		N251 10. 19	
Minimum Setbacks. There shall be a minimum setbac	k for buildings of 15 feet from	any public	street rig	ht-of-way.		Complies - Refer sheet A1.01, Site Pla
 Minimum Setbacks. There shall be a minimum setbac Maximum Building Height. Building height is not restric Maximum Lot Coverage by Buildings. Lot coverage is	cted.	any public	street rig	ht-of-way.		Complies - Refer sheet A1.01, Site Pla Complies



ABBREVIATIONS

and the second	
and the second	
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KITCHEN

LABORATORY

LAMINATE

LENGTH

LOCKER

LOUVER

LOW POINT

MACHINE

MANHOLE

MASONRY

MATERIAL

MAXIMUM

MECHANICAL

MEMBRANE

METAL DECK

MEZZANINE

MILLWORK

MINIMUM

MISCELLANEOUS

NOT APPLICABLE

NOT TO SCALE

NOT IN CONTRACT

MODIFIED CEMENT PLASTER

MIRROR

MOUNTED

MULLION

NOMINAL

NORTH

NUMBER

OBSCURE

ON CENTER

ONE SIDE

OPENING

OPPOSITE

OVER

OVERALL

INSTALLED

INSTALLED

PAINTED

PAIR

PANEL

OPPOSITE HAND

OUTSIDE AIR DAMPER

OUTSIDE DIAMETER

OVERFLOW DRAIN

OVERHEAD COILING

OUTSIDE AIR TEMPERATURE

OVAL HEAD SHEET METAL SCREW

OWNER FURNISHED CONTRACTOR

OWNER FURNISHED OWNER

PAPER TOWEL DISPENSER

PARTIAL-HEIGHT

PARTITION

PLASTER

PLATE

POINT

PLUMBING

PLYWOOD

PRECAST

QAUNTITY

RADIUS

REDWOOD

REFERENCE

REGISTER

REQUIRED

RESILIENT

RISER

ROOM

REINFORCED

RIGHT OF WAY

ROOF DRAIN

ROUGH OPENING

REFRIGERATOR

QUARRY TILE

PREFABRICATED

PROPERTY LINE

PRESSURE TREATED

QUARRY TILE RISER

RAIN WATER LEADER

REFLECTED CEILING PLAN

PERFORATED

PLASTIC LAMINATE

PLYWOOD EDGE NAILING

POWER DRIVEN FASTENERE

PAPER TOWEL RECEPTACLE

PHENOLIC COMPOSITE PANEL

OUTSIDE AIR

OPPOSED BLADE DAMPER

OFFICE

METAL

MANUFACTURER

MASONRY OPENING

MEDICINE CABINET

LONG

LIGHT

LAVATORY

LINE OF SIGHT

KIT.

LAB.

LAM.

LAV.

LT.

L.O.S.

LCKR

LG.

LVR

L.P.

MH.

MFR.

M.O.

MATL

MAX.

M.C.

M.D

MEZZ.

MWK.

MIN

MIR

MISC.

MCP

MTD.

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N.T.S.

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0.S.

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O.B.D.

OPP.

O.H.

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O.H.S.M.S.

O.D.

O/ OVRAL

0.F.D.

O.H.C.

OFCI

OFOI

PTD.

PR.

PNL.

P.T.D.

P.T.R.

PRHT.

PRTN

PERF.

PCP

PLAS.

P.LAM.

PLUMB.

PLYWD

P.E.N.

PNT.

P.D.F.

PREFAB

PC

P.T.

QTY

Q.T.

Q.T.R.

RAD.

R.W.L.

RWD.

REF.

R.C.P.

REFR.

RGTR.

REINF.

REQD.

RESIL.

R.O.W.

R.D.

RM.

R.O.

PROP.

PL.

MECH.

MEMB.

MET. / MTL

MACH.

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1 1	< @	ANGLE	E E	EA. E.	EACH EAST
1	CL	CENTERLINE	E	E.O.S.	EDGE OF SLAB
1	Ø	DIAMETER OR ROUND	Е	E.P.	ELECTRIC PANELBOARD
1	(E)	EXISTING	Е	E.W.C.	ELECTRIC WATER COOLER
1	(N)		E	ELEC. / ELECT.	
1	#	POUND OR NUMBER	E E	EL. ELEV.	ELEVATION ELEVATOR
А	ABV.	ABOVE	E	EMER.	EMERGENCY
A	A.F.F.	ABOVE FINISH FLOOR	E	E.PH.	EMERGENCY PHONE
А	ACC. / ACCS.	ACCESSIBLE	Е	ENCL.	ENCLOSURE
А	A.P.C.	ACOUSTIC PANEL CEILING	Е	EQ.	EQUAL
A	ACOUS.	ACOUSTICAL	E	EQUIP.	EQUIPMENT
A A	A.C.T. ADJ.	ACOUSTICAL CEILING TILE ADJACENT	E E	EXST. EXP.	EXISTING EXPANSION
A	ADJ.	ADJUSTABLE	E	EAF. E.J.	EXPANSION JOINT
A	AGG.	AGGREGATE	E	EXP. / EXPO.	EXPOSED
А	AWB	AIR AND WATER RESISTIVE BARRIER	Е	E.C.	EXPOSED CONSTRUCTION
A	AL. / ALUM.	ALUMINUM	E	EXT.	EXTERIOR
A	ANSI	AMERICAN NATIONAL STANDARDS SOCIETY	F	F.O.C.	FACE OF CONCRETE
А	ASTM	AMERICATION SOCIETY FOR TESTING	F	F.O.F.	FACE OF FINISH
		AND MATERIALS	F	F.O.M.	FACE OF MASONRY
A	A.B.	ANCHOR BOLT	F	F.O.S.	FACE OF STUD
A	ANOD.	ANODIZED	F	F.O.	FACE OF
A A	APPROX. ARCH.	APPROXIMATELY ARCHITECTURAL	F	F.C.U.	FAN COIL UNIT
A	A.E.S.S.	ARCHITECTURALLY EXPOSED	F	FRCP	FIBER REINFORCED CEMENT PANEL
		STRUCTURAL STEEL	F F	F.R.P. FIN.	FIBERGLASS REINFORCED PLASTIC FINISH
A	A.D.	AREA DRAIN	F	F.F.	FINISH FACE
A	AOR	AREA OF REFUGE	F	F.F.	FINISH FLOOR
A A	ASPH. A.C.	ASPHALT ASPHALTIC CONCRETE	F	F.G.	FINISH GRADE
A	ASSEM.	ASSEMBLY	F	F.O.	FINISHED OPENING
			F	F.A.	
В	BM.	BEAM	F F	F.E. F.E.C.	FIRE EXTINGUISHER FIRE EXTINGUISHER CABINET
В	BTW	BETWEEN	F	F.H.C.	FIRE HOSE CABINET
В	BYND	BEYOND	F	F.R.	FIRE RATED
B B	BITUM. BLK.	BITUMINOUS BLOCK	F	F.R.T.	FIRE RETARDENT TREATED
B	BLKG.	BLOCKING	F	F.V.C.	FIRE VALVE CABINET
В	BD.	BOARD	F	FPRF.	FIREPROOF
В	B.S.	BOTH SIDES	F F	FIXT. FLASH.	FIXTURE FLASHING
В	B.O.	BOTTOM OF	F	F.B.	FLAT BAR
В	BLDG.	BUILDING	F	FPD	FLAT PANEL DISPLAY
С	CAB.	CABINET	F	FPM	FLAT PANEL MONITOR
C	CPT.	CARPET	F	FLR.	FLOOR
C	C.I.P.	CAST IN PLACE	F F	F.C.O.	FLOOR CLEANOUT FLOOR DRAIN
С	C.I.	CAST IRON	F	F.D. F.S.	FLOOR SINK
С	C.B.	CATCH BASIN	F	F.L.	FLOW LINE
C	CLKG	CAULKING	F	FLUOR.	FLUORESCENT
C C	CLG. CEM.	CEILING CEMENT	F	FT.	FOOT OR FEET
C	C.P.	CEMENT PLASTER	F	FTG.	FOOTING
С	CTR.	CENTER	F F	FDN. FURR.	FOUNDATION FURRING
С	CTR.	CENTER	F	FUT.	FUTURE
C	CER.	CERAMIC	·		
C C	C.T. CHNL.	CERAMIC TILE CHANNEL	G	GALV.	GALVANIZED
C	CHK'D	CHECKERED	G	G.I.	GALVANIZED IRON
C	C.O.	CLEAN OUT OR CASED OPENING	G	G.S.M.	GALVANIZED SHEET METAL
С	CLR.	CLEAR	G G	GALV.STL. GA.	GALVANIZED STEEL GAUGE
С	CLST.	CLOSET	G	G.C.	GENERAL CONTRACTOR
C	CFA		G	GL.	GLASS
C C	C.W. COL.	COLD WATER COLUMN	G	G.F.R.C.	GLASS FIBER REINFORCED CONCRET
C	CSP.	COMBINATION STANDPIPE	G	G.B.	GRAB BAR
С	CONC.	CONCRETE	G G	GR. GND.	GRADE GROUND
С	CMU	CONCRETE MASONRY UNIT	G	GYP. BD. / GB	
C	C.S.B.	CONCRETE SPLASH BLOCK			
C C	COND. CONN.	CONDITION	Н	HDWR	HARDWARE
C	CONSTR.	CONSTRUCTION	Н	HDWD	HARDWOOD
С	CONT.	CONTINUOUS	H H	HFA HTR.	HEAT FLUID APPLIED HEATER
С	CONTR.	CONTRACTOR	н	HT. / HGT.	HEIGHT
С	CFCI	CONTRACTOR FURNISHED, CONTRACTOR INSTALLED	Н	H.	HIGH
С	C.J.	CONTRACTOR INSTALLED	Н	HPC	HIGH PERFORMANCE COATING
C	C.G.	CORNER GUARD	Н	H.P.	HIGH POINT
С	CORR.	CORRIDOR	Н	HO	HOLD OPEN
С	CNTR.	COUNTER	H H	H.C. H.M.	HOLLOW CORE HOLLOW METAL
С	CTSK.	COUNTERSUNK	н	HMWV	HOLLOW METAL HOLLOW METAL WOOD VENEER
П	DT	DATA/COMMUNICATIONS OUTLET	Н	HORIZ.	HORIZONTAL
D D	DT DEMO.	DATA/COMMUNICATIONS OUTLET DEMOLISH / DEMOLITION	Н	H.B.	HOSE BIBB
D	DEPT.	DEPARTMENT	Н	H.W.	HOT WATER
D	DET.	DETAIL	Н	HR.	HOUR
D	DIA.	DIAMETER	I	IN.	INCHES
D	DIM.		' I	I.D.	INCHES INSIDE DIAMETER
D D	DW. DISP.	DISH WASHER DISPENSER	Ì	INSUL.	INSULATION
D	DISP. DR.	DOOR	Ι	INT.	INTERIOR
D	D.O.	DOOR OPENING			
D	DBL.	DOUBLE	J J	JAN. JT.	JANITOR JOINT
D	DN	DOWN	J	JT. JST.	JOIST
D D	D.S. DWR.	DOWNSPOUT DRAWER	-		·
D	DWR. DWG.	DRAWER			
D	D.F.	DRINKING FOUNTAIN			e e construction de la construction
D	DSP.	DRY STANDPIPE			

WINDOW

WITHOUT

WOOD BASE

WORK POINT

WHERE OCCURS

WEST

WITH

WOOD

SPEC. / SPECS. SPECIFICATION

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S.C.D.

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SECT.

S.C.D.

S.E.D.

S.I.D.D

S.L.D.

S.M.D.

S.P.D.

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S.SK.

SHT.

SIM.

SL

S.D.

S.C.P.

S.C.

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STD.

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STA.

STL.

STOR. STRUCT

SUSP.

SYM.

TEL.

TV.

THK.

THRU.

T.B.D.

T.P.D.

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T. & B.

T.O.C.

T.O.P.

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T.OW.

T.B.

U.L.

UNF.

UR.

VERT.

VEST.

WSCT.

W/D

W.C.

W.H.

WP

WT.

W.

W/

W.O.

WDW.

W/O

WD.

W.B.

WRK. PT.

W.R.B.

W W.R.G.B.

Т Т.

T TYP.

U U.O.N.

V V.I.F.


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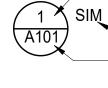
SCHED.

RUBBER BASE	ACOUSTIC CEILING TILE		O RECESSED DOWN LIGHT	S	SPEAKER
RECESSED SPILL KIT					
SANITARY NAPKIN DISPENSER					
SANITARY NAPKIN RECEPTACLE	EXPOSED CONCRETE		INDIRECT LINEAR LIGHT FIXTURE		ACCESS PANEL
SCHEDULE					
SCUPPER			i		
SEAT COVER DISPENSER					
SECTION SECTION	FINISHED CONCRETE				SUPPLY GRILLE
SEE CIVIL DRAWINGS			TRACK LIGHTING		
SEE ELECTRICAL DRAWINGS			хон така така така така така така така так		
SEE INTERIOR DESIGN DRAWINGS					
SEE LANDSCAPE DRAWINGS			EXIT SIGN		
SEE MECHANICAL DRAWINGS	GYPSUM BOARD CEILING		LOW LEVEL EXIT SIGNS)		RETURN GRILLE
SEE PLUMBING DRAWINGS					
SEE STRUCTURAL DRAWINGS	8'-0" A.F.F.		 CEILING MOUNTED EXIT SIGN, SHOW QUANTITY OF FACE(S) AND 		
SERVICE SINK	CLG. TYPE		DIRECTION OF ARROW(S)		
SHEET					EXHAUST GRILLE
SHOWER					
SIMILAR	CEILING STEP		QUANTITY OF FACE(S) AND DIRECTION OF ARROW(S)		
SLOPE SOAP DISPENSER					
SOAP DISPENSER SOLID COMPOSITE PANEL	RECESSED LIGHT FIXTURE		F FIRE ALARM		LINEAR DIFFUSER
SOLID CORE					
SOUTH			SD SMOKE DETECTOR		
S. SPECIFICATION	1 X 4 FLUORESCENT FIXTURE				
SQUARE			-• CEILING MOUNTED SPRINKLER HEAD	\square	SURFACE / PENDANT
STAINLESS STEEL			WALL MOUNTED SPRINKLER HEAD	∇	MTD LIGHT FIXTURE
STANDARD					
STANDPIPE	2 X 2 FLUORESCENT FIXTURE		WAP WIRELESS INTERNET	\bigcirc	WALL SCONCE
STATION					
STEEL			FP FIRE ALARM PULL BOX		
STORAGE STRUCTURAL	-		H CEILING MOUNTED HORN / STROBE CO	MBO	
SUSPENDED					
SYMMETRICAL				30	
	LINEAR RECESSED LIGHT FIXTURE		EMERGENCY LIGHT (BUG EYE)		
TELEPHONE					
TELEVISION			MD MOTION / DAYLIGHT SENSOR		
THICK / THICKNESS					
THROUGH					
TO BE DETERMINED	SYMBOLS - POWER AND COMMU	NICA	ATION		
TOILET PAPER DISPENSER TONGUE AND GROOVE					
TOP AND BOTTOM					
TOP OF CURB	Φ WALL MOUNTED SINGLE OUTLET	Θ	FLOOR MOUNTED SINGLE RECEPTACLE	T WAL	L MOUNTED THERMOSTAT
TOP OF PARAPET	WALL MOUNTED DUPLEX OUTLET	\ominus	FLOOR MOUNTED DUPLEX RECEPTACLE	Фusв WAL	L MOUNTED DUPLEX W/ USB P
TOP OF PAVEMENT		32			
TOP OF STEEL / TOP OF SLAB	⊕ _{GFCI} WALL MOUNTED DUPLEX GROUND FAULT INTERRUPTER OUTLET	\oplus	FLOOR MOUNTED QUADRUPLEX RECEPTACLE	BLAM	NK PLATE
TOP OF WALL				FHC FIRE	
TOWEL BAR	WALL MOUNTED QAUDRUPLEX OUTLET		FLOOR MOUNTED VOICE RECEPTACLE		HOSE CABINET
TREAD	H WALL MOUNTED QUADRUPLEX GROUND	\bigcirc	FLOOR MOUNTED DATA RECEPTACLE	(FE) FIRE	EXTINGUISHER WITHOUT CAB
TYPICAL	FAULT INTERRUPTER OUTLET				
			FLOOR MOUNTED VOICE/DATA		EXTINGUISHER CABINET
UNDERWRITERS LABORATORIES UNFINISHED	Ş WALL MOUNTED SINGLE SWITCH		RECEPTACLE		VALVE WITHOUT CABINET
UNLESS OTHERWISE NOTED	S₂ WALL MOUNTED DOUBLE SWITCH	J	FLOOR MOUNTED ELECTRICAL JUNCTION	(FV) FIRE	
URINAL			BOX		VALVE CABINET
	S₃ WALL MOUNTED TRIPLE SWITCH	W	FLOOR MOUNTED FURNITURE WHIP		ATION OF CONDUIT STUB UP F
VERIFY IN FIELD	S □ WALL MOUNTED DIMMER SWITCH				B FOR POWER & CONNECTED V
VERTICAL		\bigcirc	POWER POLE, POWER/DATA/VOICE FEED	FLE>	(IBLE METAL CONDUIT & WIREI
VESTIBULE	WALL MOUNTED VOICE RECEPTACLE	\bigcirc	WALL MOUNTED ELECTRICAL JUNCTION	DIRE	ECTLY TO OUTLETS
	▷ WALL MOUNTED DATA RECEPTACLE	(\mathbf{j})	BOX	© LOC	ATION OF CONDUIT STUB UP F
MOISTURE RESISTANT GYPSUM				SLAE	3 FOR DATA & CONNECTED WI
BOARD	WALL MOUNTED VOICE/DATA RECEPTACLE	J	CEILING MOUNTED ELECTRICAL JUNCTION BOX		KIBLE METAL CONDUIT & WIREI
				DIRE	CTLY TO DATA OUTLETS
WASHER & DRYER WATER CLOSET			TELEVISION		ATION OF CONDUIT STUB UP F
WATER CLOSET WATER HEATER		CR	CARD READER		B FOR TV CABLE & CONNECTED
WATERPOOF / WATERPROOFING				DIRE	CTLY TO CABLE BOX
WEATHER RESISTIVE BARRIER		AV	AUDIO VISUAL		
WEIGHT		T			





A101

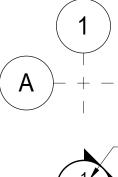


A101

A101


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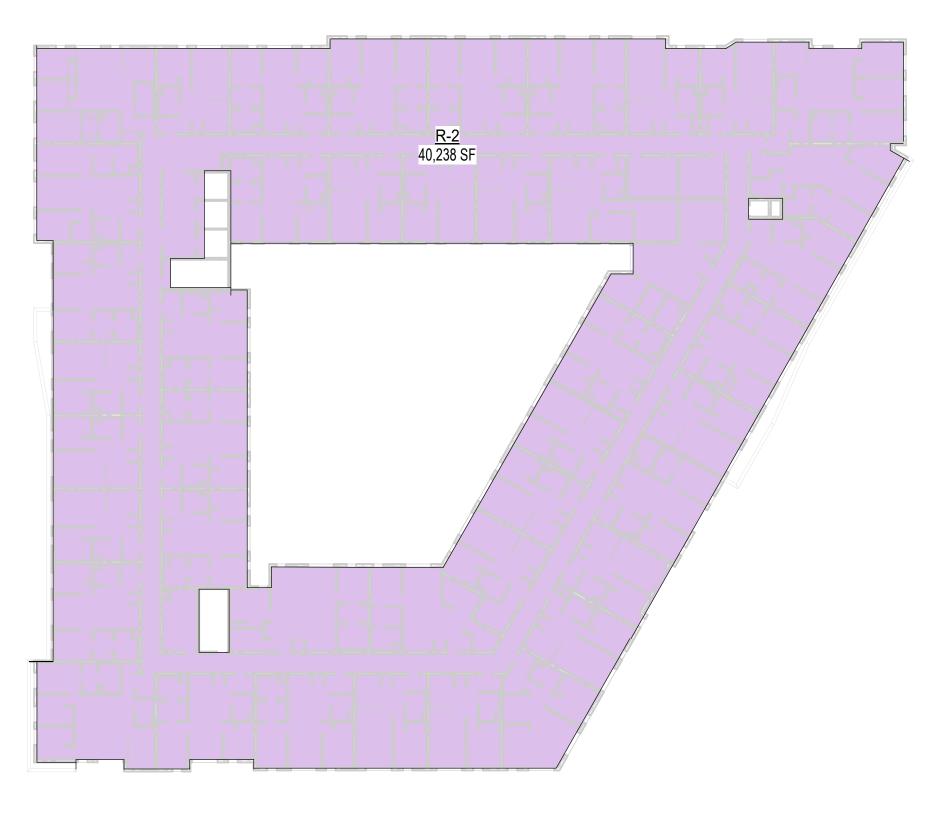
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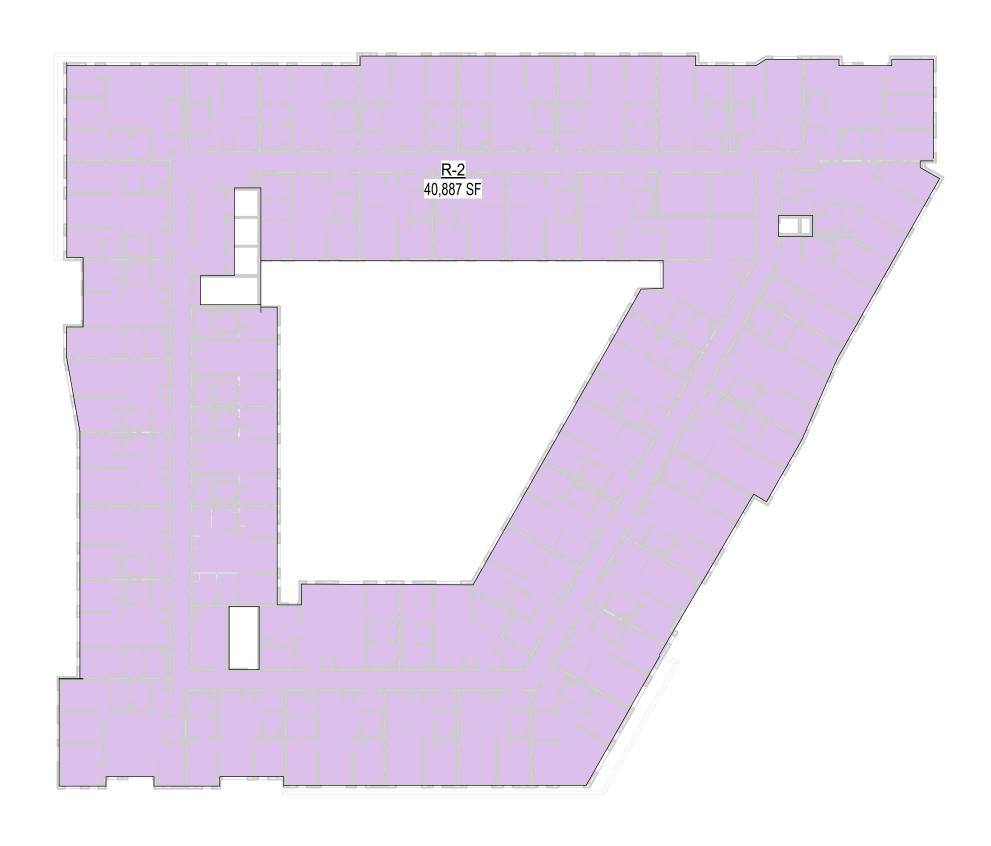


-ROOM/SPACE DESCRIPTION Ν 10000.0 • -ROOM NUMBER XXX **GRID LINE** NORTH ARROW ___ REFERENCE -AREA (SQ. FEET) ALIGN ALIGN PL----- PROPERTY LINE -SECTION IDENTIFICATION SIM -'X' IF EXTERIOR WALL TYPE -DESCRIPTION OF SIM OR OPP FOR DETAILS -DWG SHEET NUMBER **REVISION KEY** -STUD SIZE - PARTITION TAG DETAIL NUMBER $- - \frac{\text{LEVEL 2}}{+ 12' - 0''} \quad \text{ELEVATION DATUM}$ -MODIFIER (SEE A8.01 FOR MATRIX) —DESCRIPTION OF SIM OR OPP -FIRE RATING (HR) WORK, CONTROL OR ______ \bigcirc -DOOR NUMBER ELEVATION POINT SIM EXTERIOR ELEVATION SPECIFIC ELEVATION - (10.23) KEYNOTE -DWG SHEET NUMBER 1 SLOPE RISE:RUN CENTERLINE INTERIOR ELEVATION 1-SPECIFIC ELEVATION SLAB STEP DWG SHEET NUMBER #' - ##" DIMENSION AT GRIDLINE, FACE OF FRAMING OR STRUCTURE -____CP1___ MATERIAL TAG #" - ##" PERSPECTIVE VIEW DIMENSION AT CENTERLINE T-1 CPT-1 -SPECIFIC VIEW CHANGE IN FLOOR #' - ##" DIMENSION AT FACE OF FINISH FINISH -DWG SHEET NUMBER OR CLEAR DIMENSION




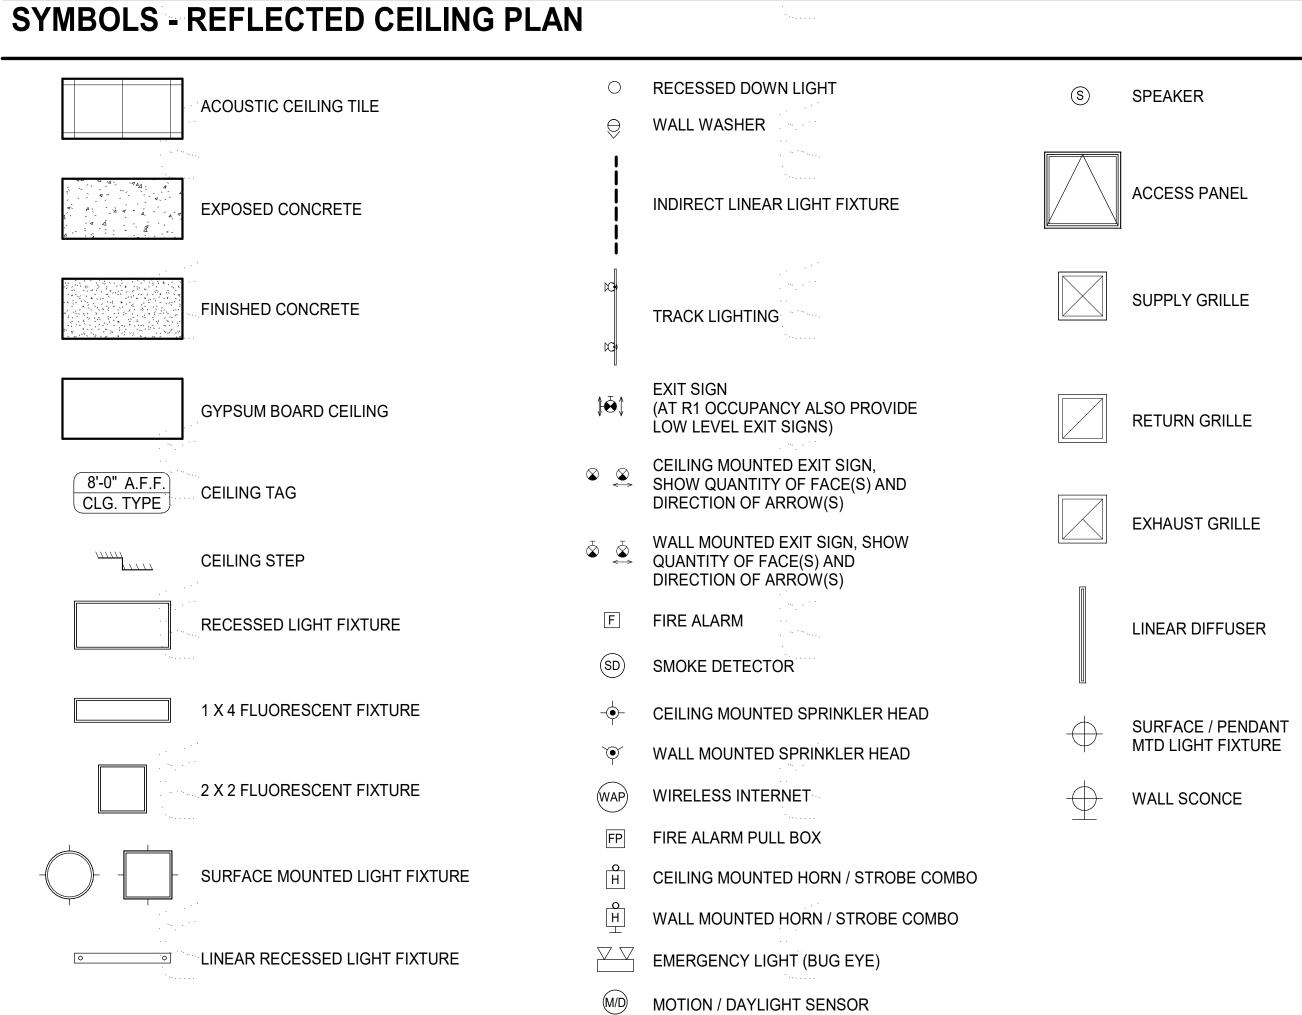

LEVEL 8 SCALE: 1" = 30'-0"

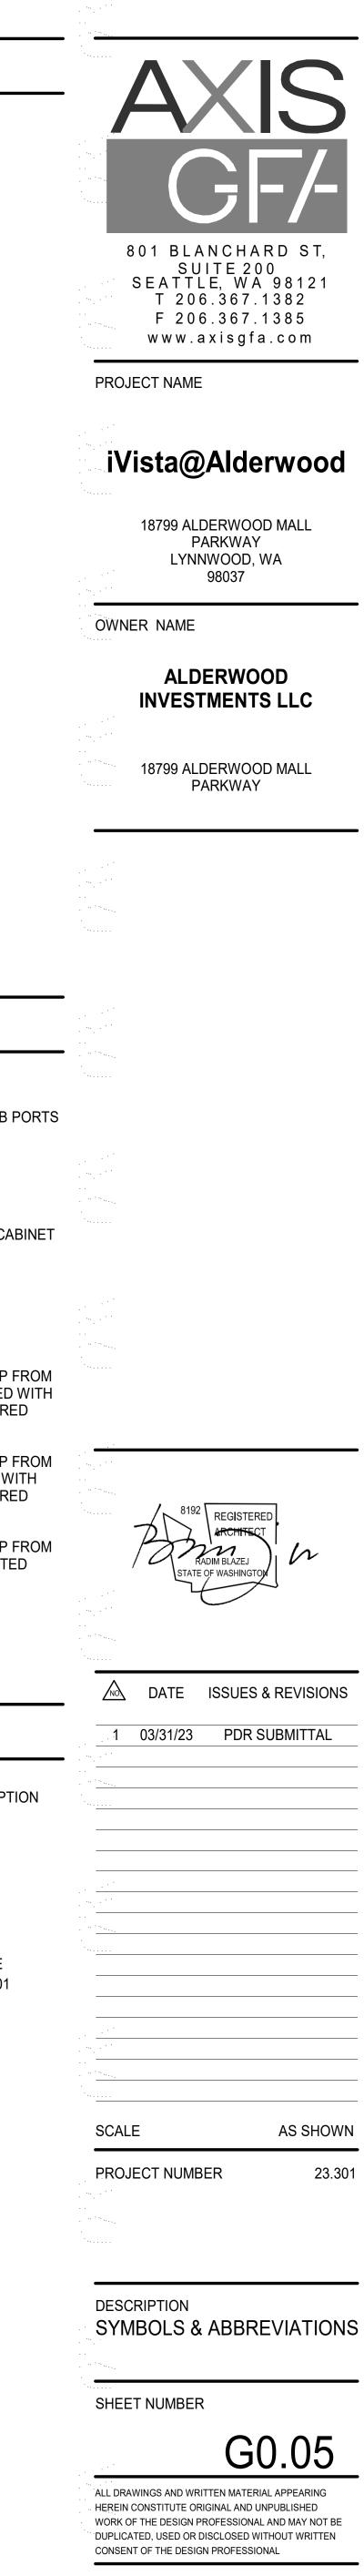



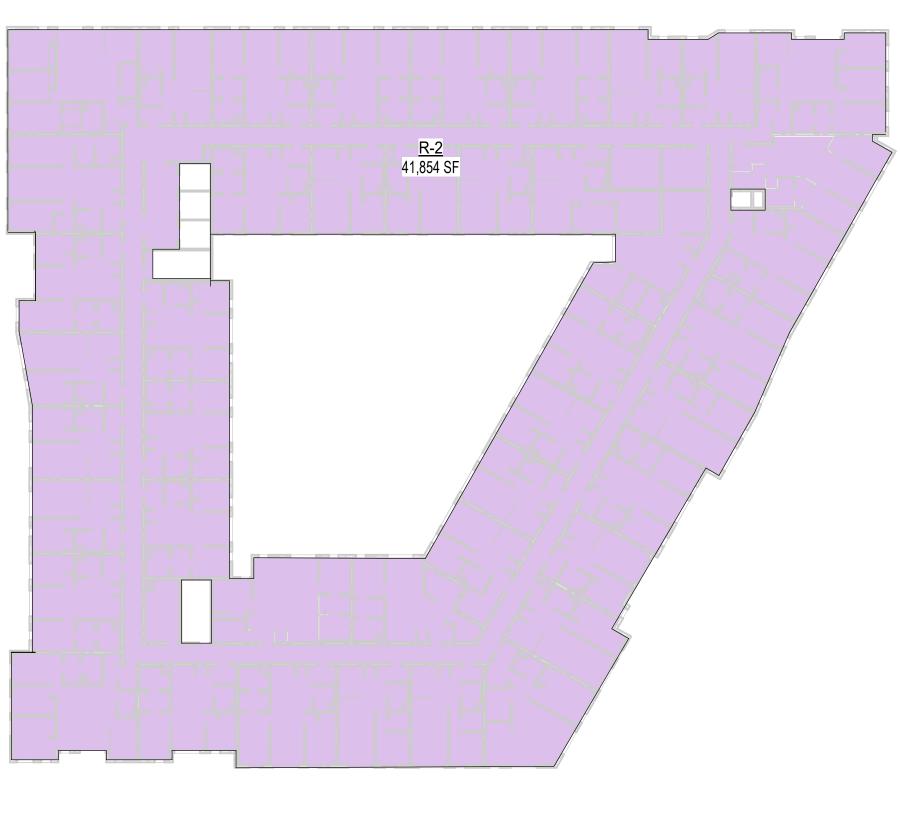





4^{12.05}

60.21


5.21

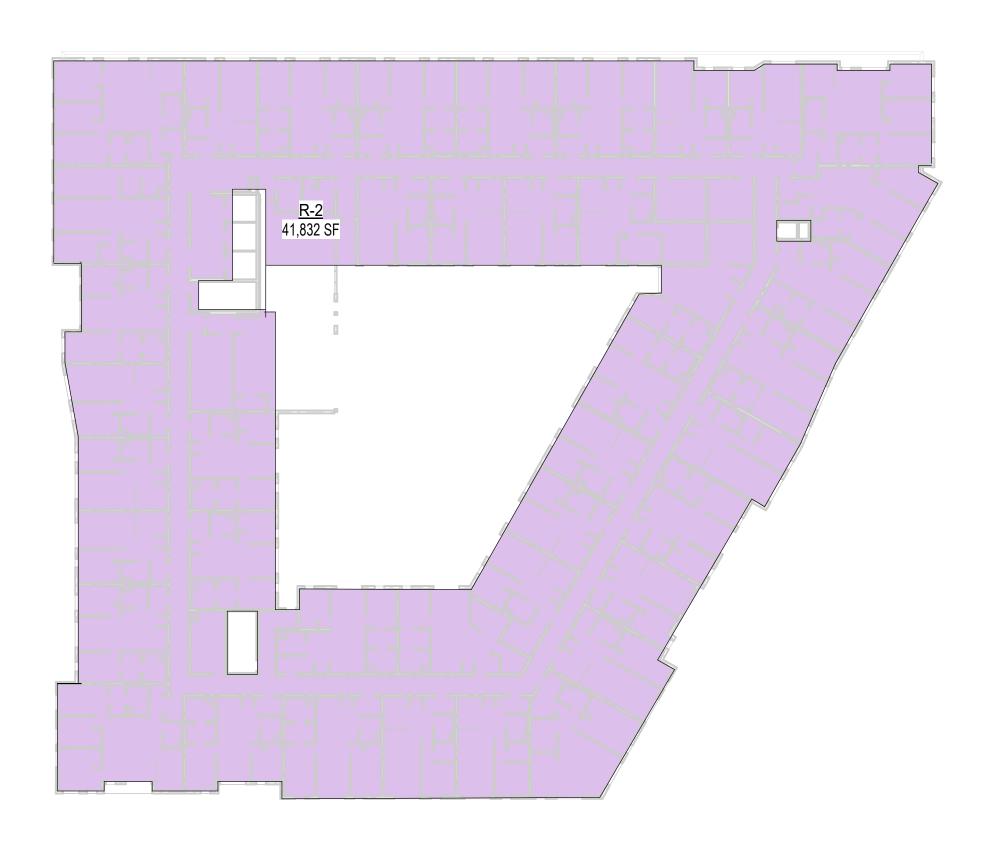

LEVEL 3 SCALE: 1" = 30'-0"

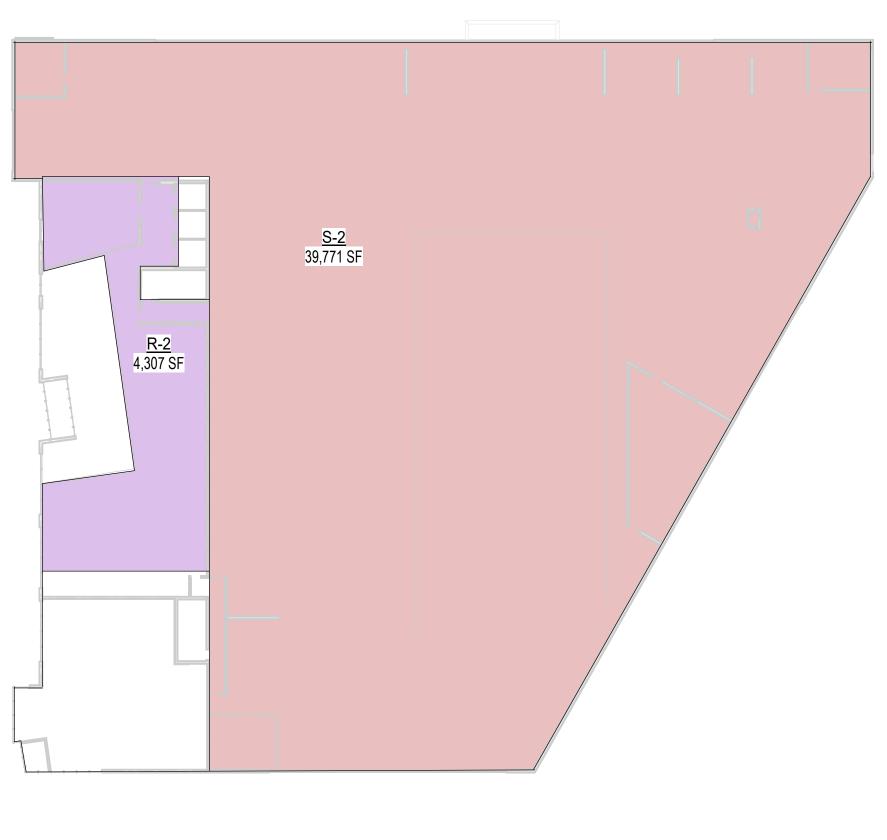

LEVEL 2 SCALE: 1" = 30'-0"

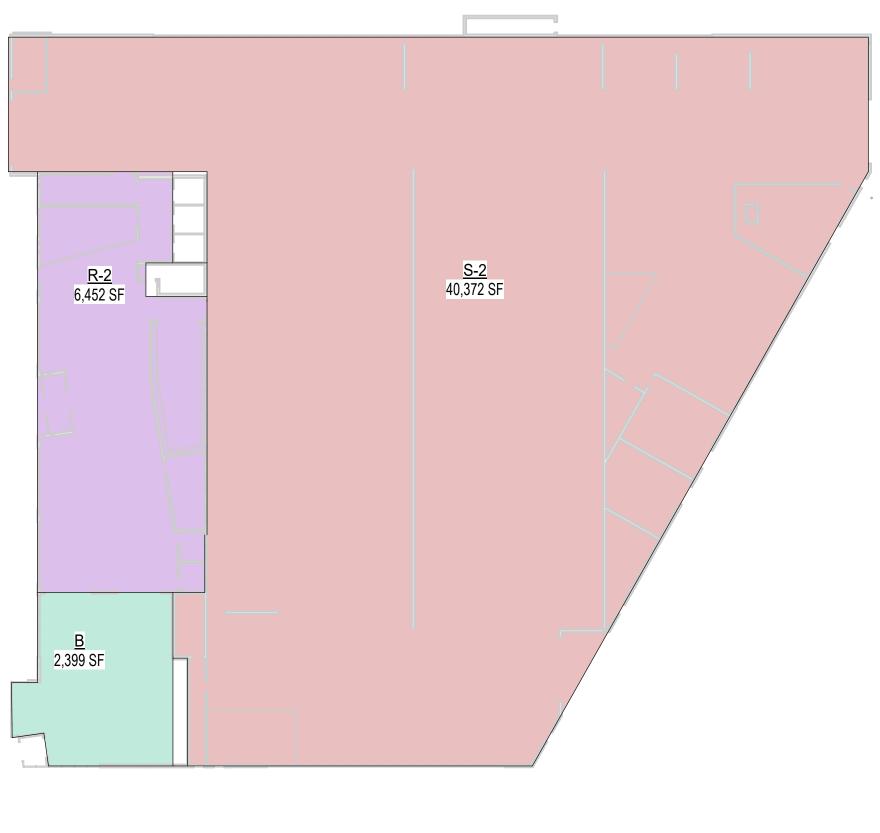





G0.21

2^{0.21}

SEC. 12.21.1-A, 5 PROVIDES: IN COMPUTING THE TOTAL FLOOR AREA WITHIN A BUILDING, THE GROSS AREA CONFINED WITHIN THE EXTERIOR WALLS WITHIN A BUILDING SHALL BE CONSIDERED AS THE FLOOR AREA OF THAT

- FLOOR OF THE BUILDING, EXCEPT FOR: • THE SPACE DEVOTED TO STAIRWAYS, ELEVATOR SHAFTS, LIGHT COURTS ROOMS HOUSING MECHANICAL EQUIPMENT
- INCIDENTAL TO THE OPERATION OF BUILDINGS
- OUTDOOR EATING AREAS OF GROUND FLOOR RESTAURANTS.

B. THE FOLLOWING GUIDELINES SHALL APPLY WHEN CALCULATING FLOOR AREA UNDER THE BUILDING CODE DEFINITION AND :

ARCHITECTURAL PROJECTION SHALL MEAN ANY PROJECTION NOT INTENDED FOR SHELTER OR OCCUPANCY AND WHICH EXTENDS BEYOND THE OUTER FACE OF AN EXTERIOR WALL OF A BUILDING, BUT SHALL NOT INCLUDE SIGNS.

AREA UNDER ARCHITECTURAL PROJECTIONS EXCEEDING 5 FEET (1524 MM) IN WIDTH SHALL BE INCLUDED IN THE FLOOR AREA CALCULATION. EXTERIOR WALLS SHALL BE CONSIDERED TO EXIST AT THE OUTER EDGES OF SUCH PROJECTIONS FOR THE PURPOSE OF ENFORCING EXTERIOR WALL CONSTRUCTION AND OPENING PROTECTION DUE TO BUILDING LOCATION ON THE PROPERTY.

GROSS BUILDING AREA - TOTALS				
NAME AREA				
В	2,399 SF			
R-2	259,277 SF			
S-2	80,143 SF			
TOTAL:	341,819 SF			

GROSS BUILDING AREA				
LEVEL	AREA			
В				
LEVEL 1	2,399 SF			
R-2				
LEVEL 1	6,452 SF			
LEVEL 2	4,307 SF			
LEVEL 3	41,832 SF			
LEVEL 4	41,854 SF			
LEVEL 5	41,854 SF			
LEVEL 6	41,854 SF			
LEVEL 7	40,887 SF			
LEVEL 8	40,238 SF			
S-2				
LEVEL 1	40,372 SF			
LEVEL 2	39,771 SF			
TOTAL:	341,819 SF			





PROJECT NAME

iVista@Alderwood


18799 ALDERWOOD MALL PARKWAY LYNNWOOD, WA 98037

OWNER NAME

ALDERWOOD INVESTMENTS LLC

18799 ALDERWOOD MALL PARKWAY



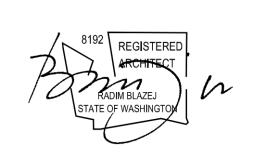

A DATE ISSUES & REVISIONS 1 03/31/23 PDR SUBMITTAL

AS SHOWN

PROJECT NUMBER


23.301

DESCRIPTION GROSS BUILDING AREA

SHEET NUMBER



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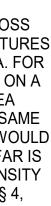
21.02.340 FLOOR AREA.

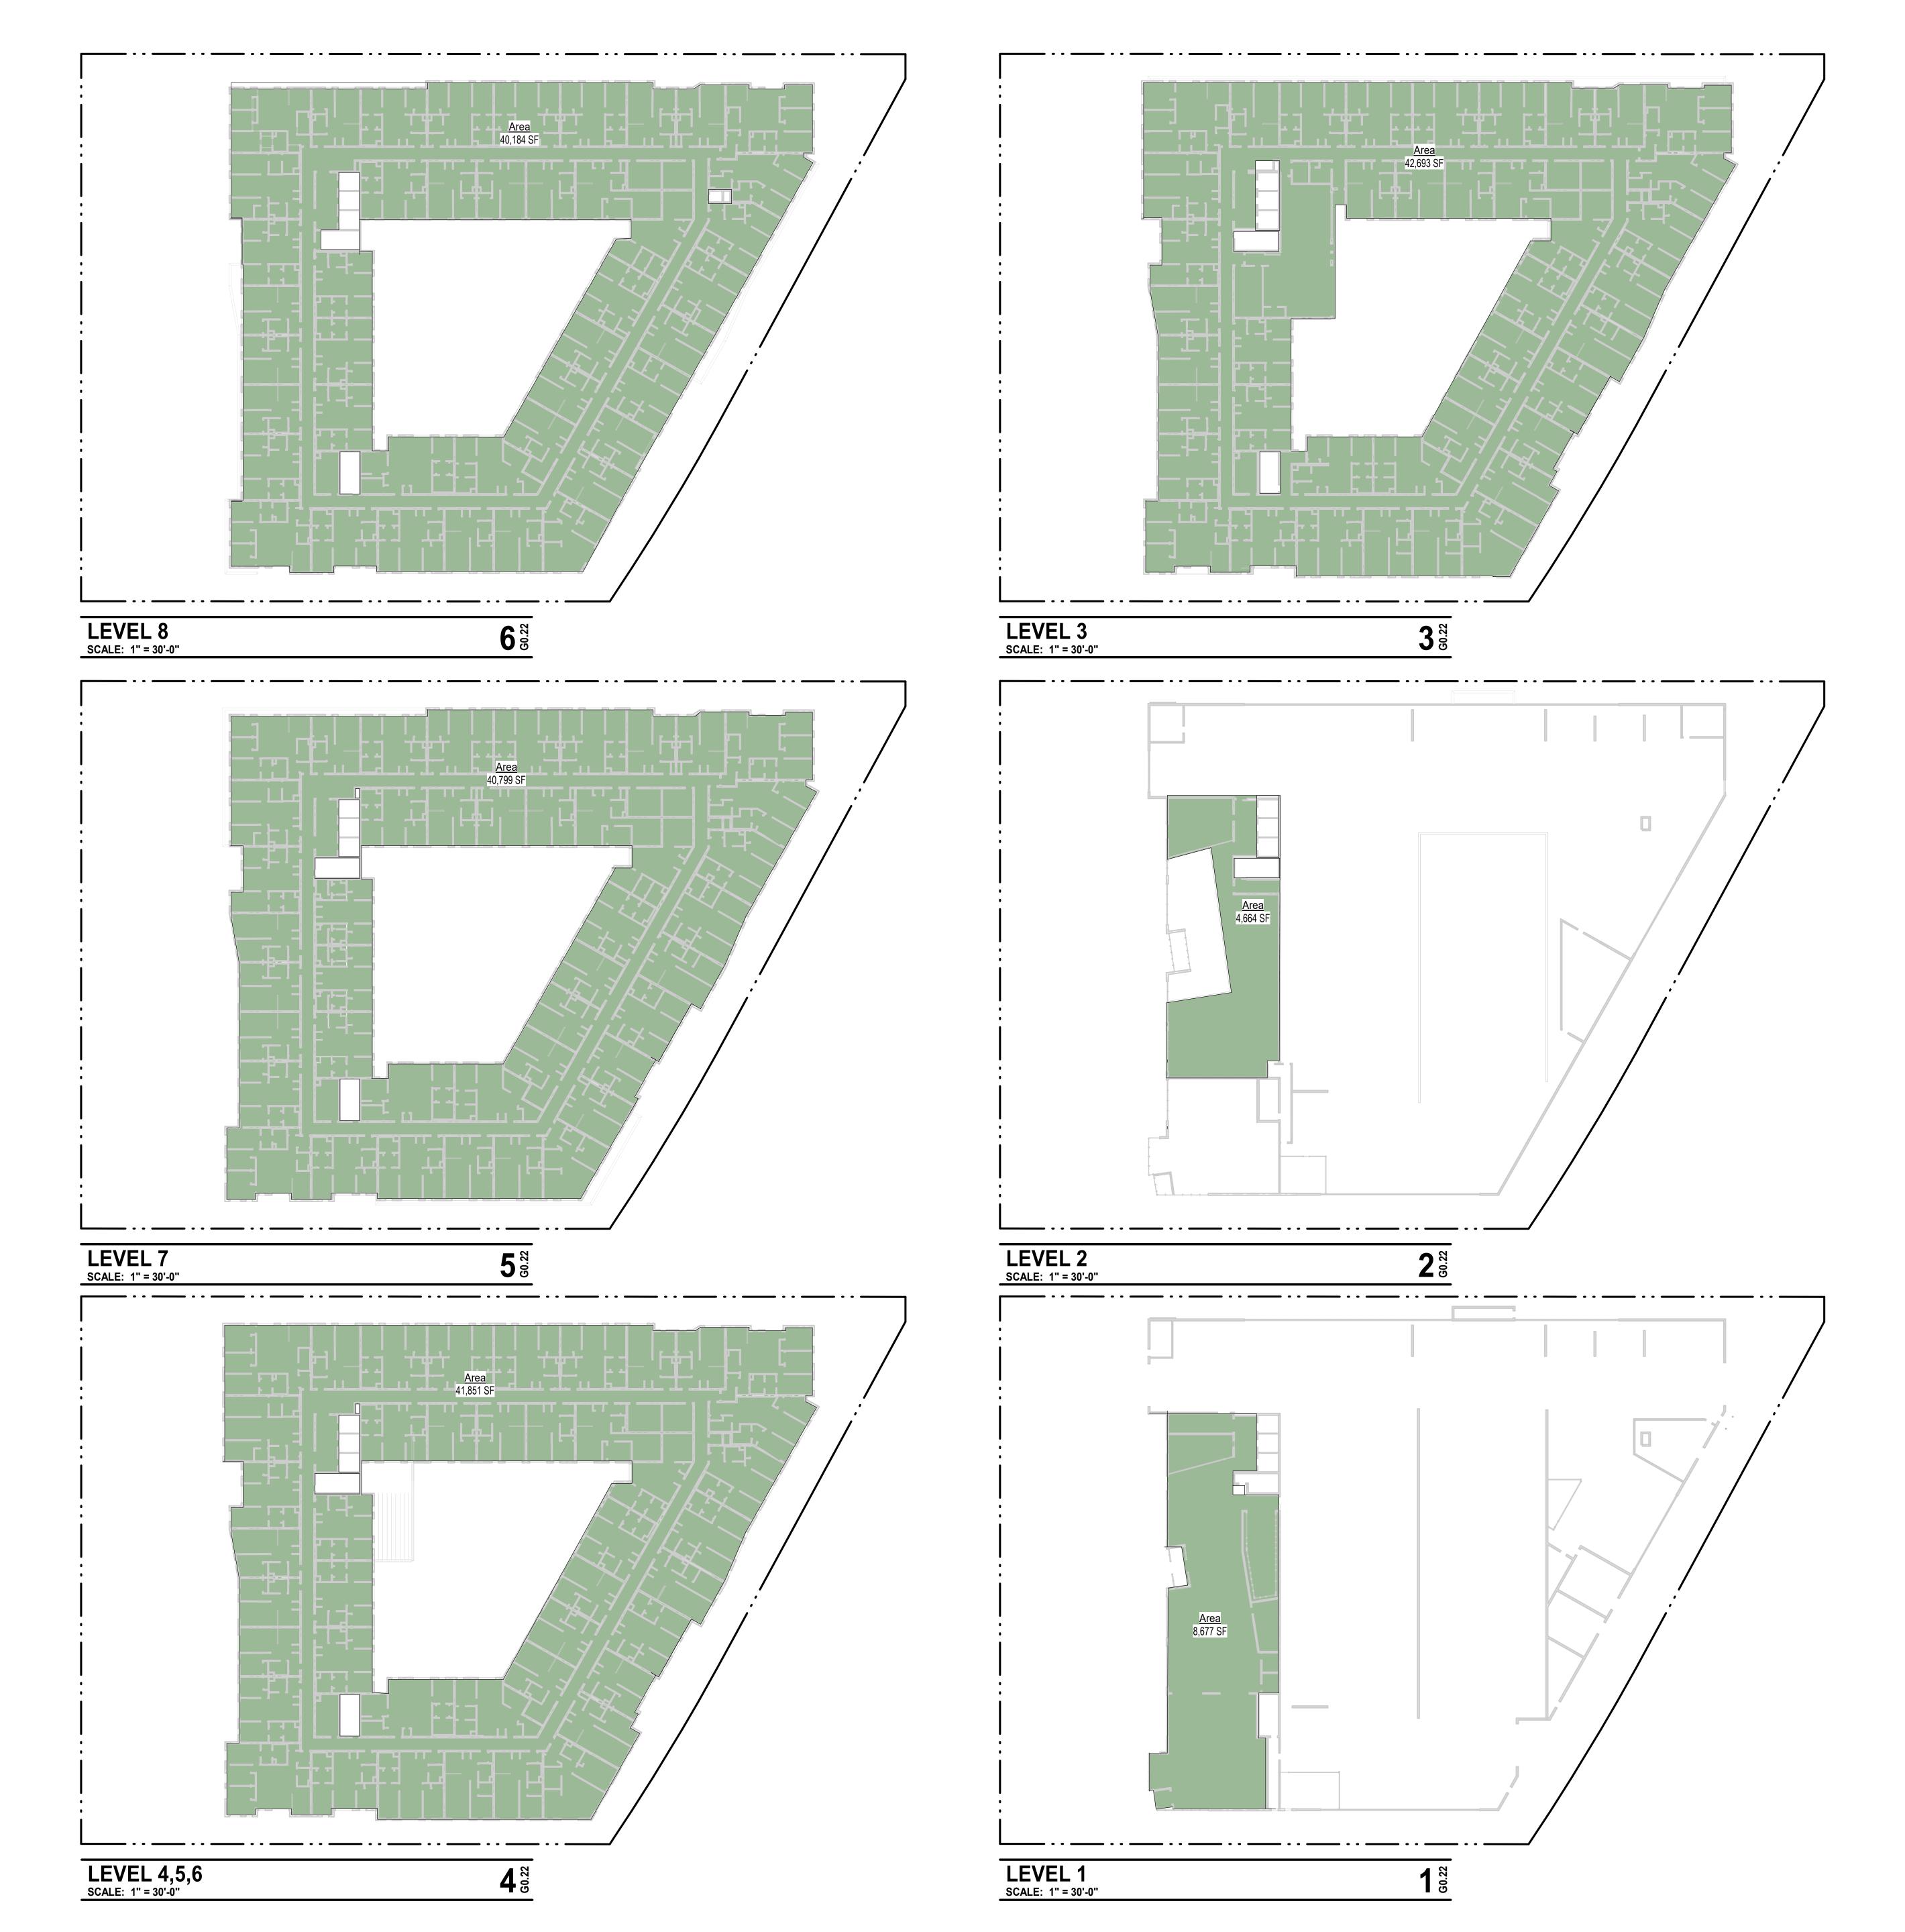"FLOOR AREA" MEANS THE AREA INCLUDED WITHIN SURROUNDING WALLS OF THE BUILDING (OR PORTION THEREOF), EXCLUSIVE OF VENT SHAFTS AND COURTS. (ORD. 2020 § 2, 1994; ORD. 190 ART. IV § 406, 1964) `

21.02.350 FLOOR AREA RATIO.

"FLOOR AREA RATIO (FAR)" MEANS THE GROSS FLOOR AREA OF ALL BUILDINGS OR STRUCTURES ON A LOT DIVIDED BY THE TOTAL LOT AREA. FOR EXAMPLE, A 5,000-SQUARE-FOOT BUILDING ON A 5,000-SQUARE-FOOT LOT HAS A FLOOR AREA RATIO OF 1.0 OR 100 PERCENT WHILE THE SAME BUILDING ON A 10,000-SQUARE-FOOT LOT WOULD HAVE A FAR OF 0.50 OR 50 PERCENT. THE FAR IS USED IN CALCULATING THE BUILDING INTENSITY OF A DEVELOPMENT PROJECT. (ORD. 3192 § 4, 2016)

	F.A.R ANALY	SIS	
ALLOWABLE	F.A.R. = UNLIMITED	AREA OF LOT = 81,668 SF	
Level	Area	F.A.R.	
LEVEL 1	8,677 SF	0.11	
LEVEL 2	4,664 SF	0.06	
LEVEL 3	42,693 SF	0.52	
LEVEL 4	41,851 SF	0.51	
LEVEL 5	41,851 SF	0.51	
LEVEL 6	41,851 SF	0.51	
LEVEL 7	40,799 SF	0.5	
LEVEL 8	40,184 SF	0.49	
TOTAL F.A.R.	262,570 SF	3.22	





PROJECT NAME


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18799 ALDERWOOD MALL PARKWAY LYNNWOOD, WA 98037

OWNER NAME

ALDERWOOD INVESTMENTS LLC

18799 ALDERWOOD MALL PARKWAY

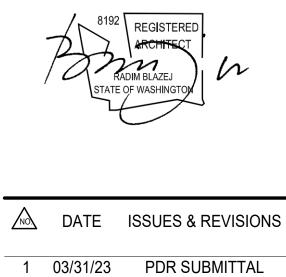

AS SHOWN

PROJECT NUMBER


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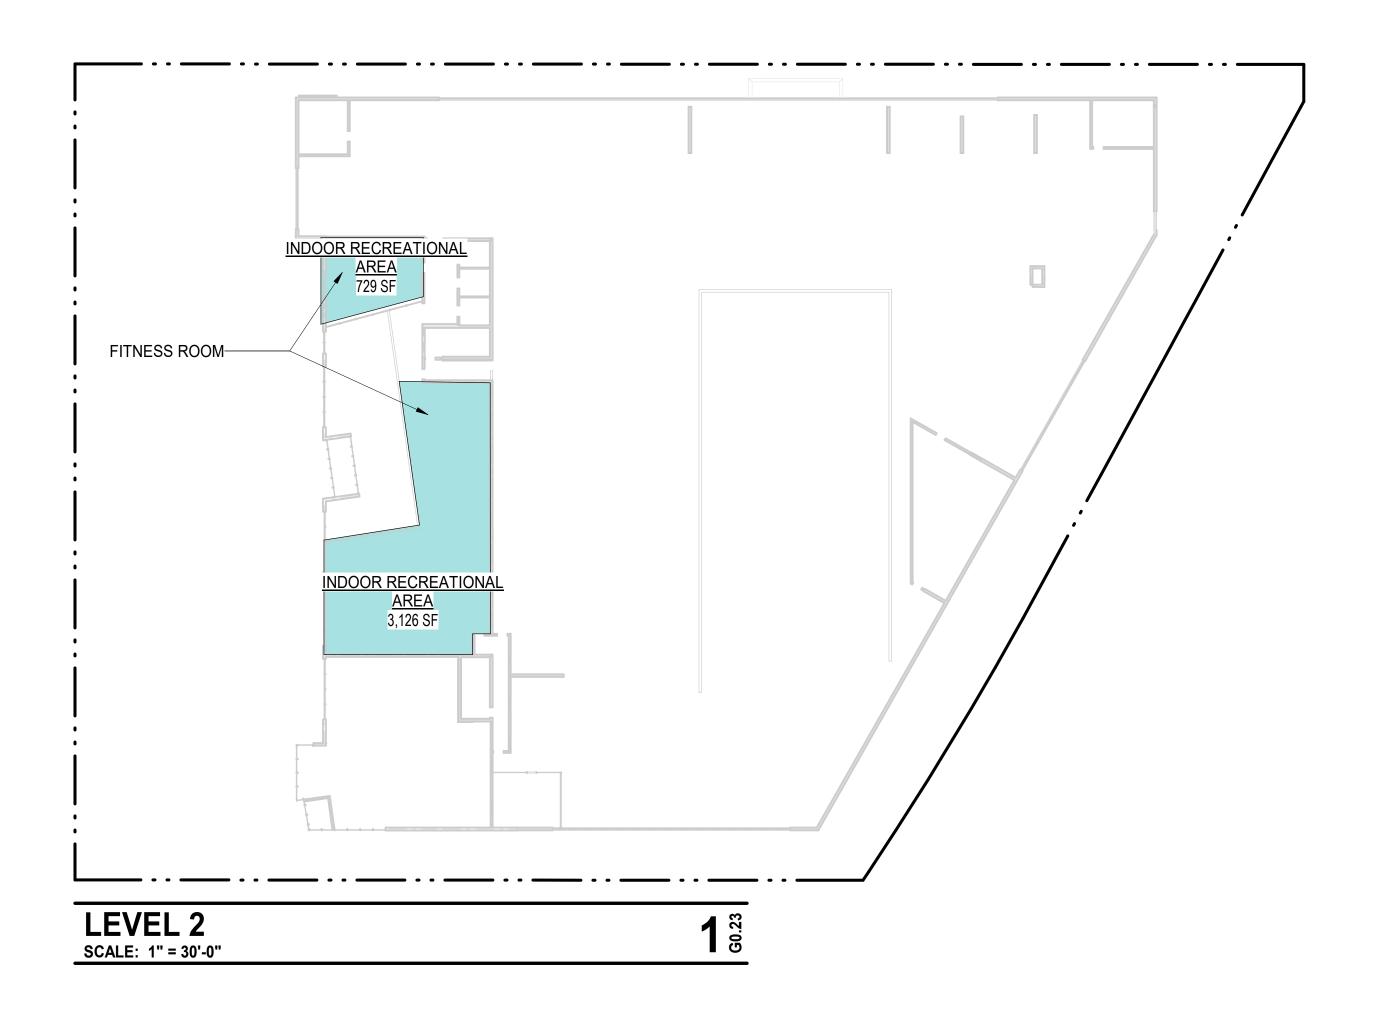
DESCRIPTION ZONING AREA (F.A.R.)

SHEET NUMBER



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SITE RECREATIONAL AREA REQUIREMENTS: FOR PROPERTIES SUBJECT TO THE PROVISIONS OF THIS CHAPTER, DEVELOPMENT WITH MULTIFAMILY DWELLINGS SHALL PROVIDE A MINIMUM OF 40 SQUARE FEET OF ON-SITE RECREATION AREA PER DWELLING. THE ON-SITE RECREATION AREA SHALL CONSIST OF A MINIMUM OF TWO OF THE FOLLOWING:

A. INDIVIDUAL PATIO, DECK OR BALCONY IMMEDIATELY ADJACENT TO THE CORRESPONDING DWELLING. INDIVIDUAL PATIOS, DECKS, OR BALCONIES SHALL BE DESIGNED SO THAT A SIX-FOOT-BY-SIX-FOOT SQUARE WILL FIT WITHIN THE PERIMETER OF THE PATIO, DECK OR BALCONY.

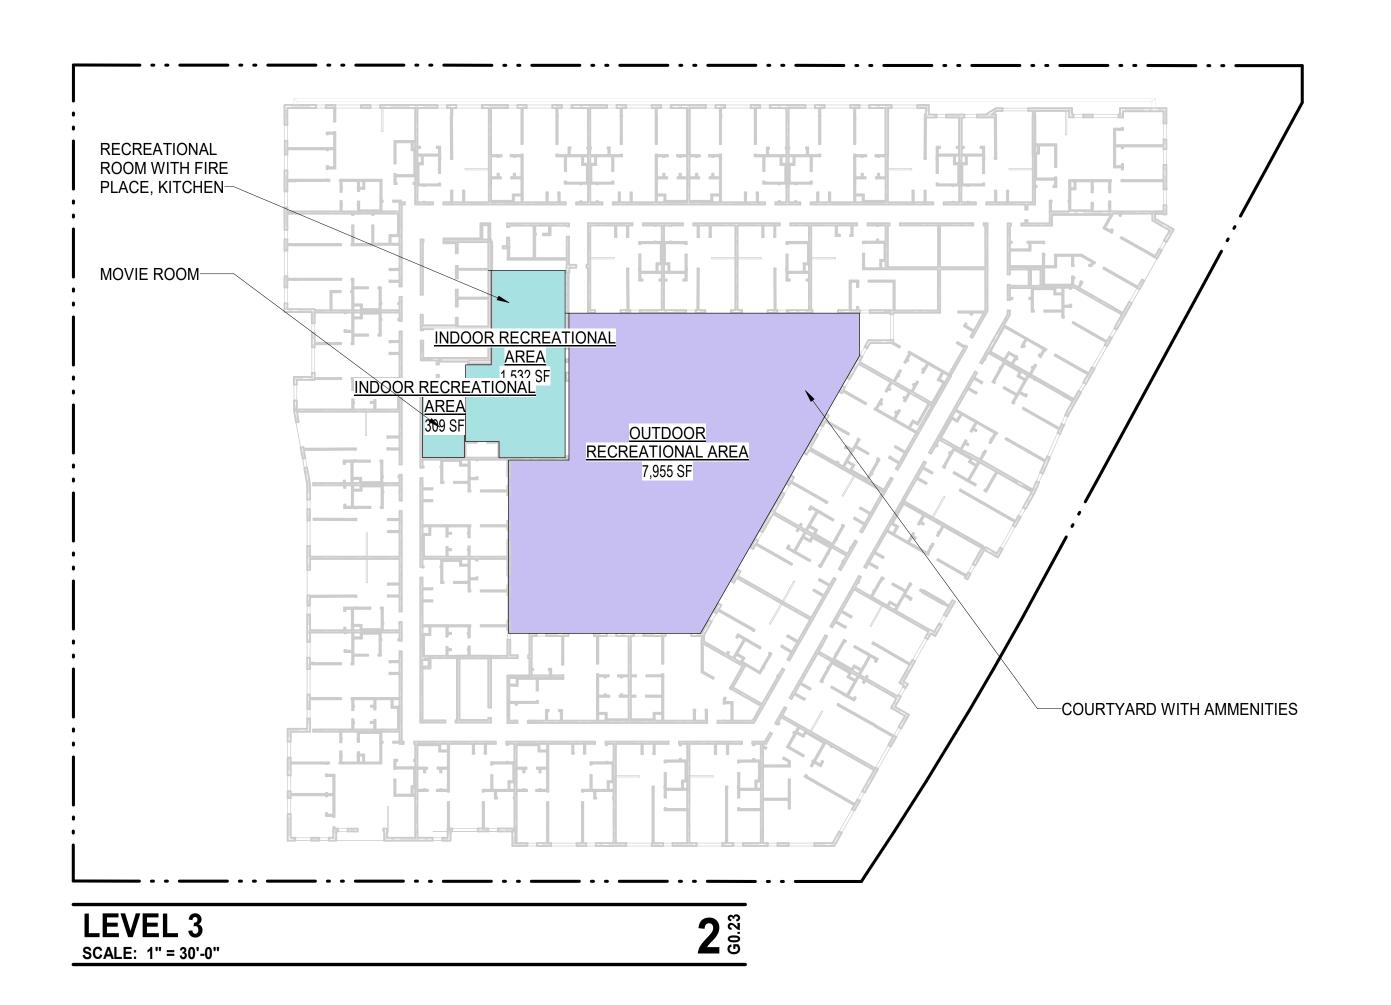B. OUTDOOR RECREATION AREA ACCESSIBLE TO ALL RESIDENTS OF THE DEVELOPMENT AND DESIGNED SO THAT A 15-FOOT-BY-15-FOOT SQUARE WILL FIT WITHIN THE PERIMETER OF THE OUTDOOR RECREATION AREA. COMMON OUTDOOR RECREATION AREAS SHALL INCLUDE FEATURES SUCH AS: LANDSCAPED COURTYARD OR PLAZA; SEATING; LIGHTING; ROOFTOP GARDEN; CHILDREN'S PLAY STRUCTURE; AND SPORT COURT. OUTDOOR RECREATION AREAS MAY INCLUDE OVERHEAD WEATHER PROTECTION, BUT SHALL NOT BE ENCLOSED. LANDSCAPING REQUIRED WITHIN PARKING AREAS SHALL NOT BE CONSIDERED OUTDOOR RECREATION AREA.

C. INDOOR RECREATION SPACE ACCESSIBLE TO ALL RESIDENTS OF THE DEVELOPMENT AND DESIGNED SO THAT A 12-FOOT-BY-12-FOOT SQUARE WILL FIT WITHIN THE INDOOR RECREATION AREA. INDOOR RECREATION AREAS SHALL INCLUDE FURNISHINGS AND FIXTURES FOR ACTIVITIES SUCH AS: AEROBIC EXERCISE; CHILDREN'S PLAY; INDOOR GAMES; SPORTS; HOBBIES AND CRAFTS; AND VIDEO ENTERTAINMENT.

256 UNITS X 40 SF = 10,240 SF OF REQUIRED AREA PROVIDED: 13,539 SF

	SITE RECREATIONAL AREAS					
	Name	Area	Le			
	INDOOR RECREATIONAL AREA	309 SF	LEVE			
	INDOOR RECREATIONAL AREA	729 SF	LEVE			
	INDOOR RECREATIONAL AREA	1,532 SF	LEVE			
	INDOOR RECREATIONAL AREA	3,126 SF	LEVE			
	OUTDOOR RECREATIONAL AREA	7,955 SF	LEVE			
	Grand total	13,652 SF				

Level EL 3 EL 2 EL 3 EL 2 EL 3




PROJECT NAME

iVista@Alderwood

18799 ALDERWOOD MALL PARKWAY LYNNWOOD, WA 98037

OWNER NAME

ALDERWOOD INVESTMENTS LLC

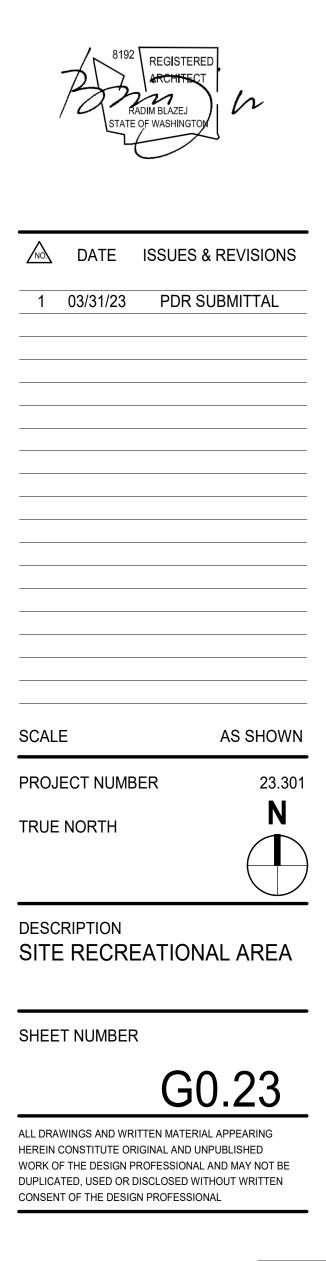

	OCCUPANCY			
NUMBER	NAME	occu		
BASEMENT				
001	BASEMENT PARKING	S		
TOTAL				

		E = = = = = = = = = =
9'-6 9'-6)" 	
		PARKING 001 5,669 SF
		OF : 200 OL - 29 - S-2
	٠ ــــــ	

BASEMENT - EXITING PLAN SCALE: 1/16" = 1'-0"

SCHEDUI	SCHEDULE - BASEMENT					
UPANCY	AREA	OCCUPANT FACTOR	OCCUPANT LOAD			
S-2	5,669 SF	200	29			

29

SECTION 1009

ACCESSIBLE MEANS OF EGRESS

1009.1 ACCESSIBLE MEANS OF EGRESS REQUIRED. ACCESSIBLE MEANS OF EGRESS SHALL COMPLY WITH THIS SECTION. ACCESSIBLE SPACES SHALL BE PROVIDED WITH NOT LESS THAN ONE ACCESSIBLE MEANS OF EGRESS. WHERE MORE THAN ONE MEANS OF EGRESS ARE REQUIRED BY SECTION 1006.2 OR 1006.3 FROM ANY ACCESSIBLE SPACE, EACH ACCESSIBLE PORTION OF THE SPACE SHALL BE SERVED BY ACCESSIBLE MEANS OF EGRESS IN AT LEAST THE SAME NUMBER AS REQUIRED BY SECTIONS 1006.2 OR 1006.3. IN ADDITION TO THE REQUIREMENTS OF THIS CHAPTER, MEANS OF EGRESS, WHICH PROVIDE ACCESS TO, OR EGRESS FROM, BUILDINGS FOR PERSONS WITH DISABILI-TIES, SHALL ALSO COMPLY WITH THE REQUIREMENTS OF CHAPTER 11A OR 11B AS APPLICABLE.

EXCEPTIONS:

1. ACCESSIBLE MEANS OF EGRESS ARE NOT REQUIRED TO BE PROVIDED IN EXISTING BUILDINGS. 2. ONE ACCESSIBLE MEANS OF EGRESS IS REQUIRED FROM AN ACCESSIBLE MEZZANINE LEVEL IN ACCORDANCE WITH SECTION 1009.3, 1009.4 OR 1009.5, AND CHAPTER 11A OR 11B, AS APPLICABLE. 3. IN ASSEMBLY AREAS WITH RAMPED AISLES OR STEPPED AISLES. ONE ACCESSIBLE MEANS OF EGRESS IS PERMITTED WHERE THE COMMON PATH OF EGRESS TRAVEL IS ACCESSI-BLE AND MEETS THE REQUIREMENTS IN SECTION 1029.8, AND CHAPTER 11A OR 11B, AS APPLICABLE.

1009.2 CONTINUITY AND COMPONENTS. EACH REQUIRED ACCESSIBLE MEANS OF EGRESS SHALL BE CONTINUOUS TO A PUBLIC WAY AND SHALL CONSIST OF ONE OR MORE OF THE FOLLOWING COMPONENTS: 1. ACCESSIBLE ROUTES COMPLYING WITH CHAPTER 11A, SECTIONS 1110A.1 AND 1120A, OR CHAPTER 11B, SECTIONS 11B-206 AND 11B-402, AS APPLICABLE

2. INTERIOR EXIT STAIRWAYS COMPLYING WITH SECTIONS 1009.3 AND 1023, AND CHAPTER 11A, SECTION 1123A, OR CHAPTER 11B, SECTIONS 11B-210 AND 11B-504, APPLICABLE. 3. EXIT ACCESS STAIRWAYS COMPLYING WITH SECTIONS 1009.3 AND 1019.3 OR 1019.4, CHAPTER 11A, SECTION

1123A, OR CHAPTER 11B, SECTIONS 11B-210 AND 11B-504, AS APPLICABLE. 4. EXTERIOR EXIT STAIRWAYS COMPLYING WITH SECTIONS 1009.3 AND 1027 AND CHAPTER 11A, SECTION 1115A, OR CHAPTER 11B, SECTIONS 11B-210 AND 11B-504, AS APPLICABLE AND SERVING LEVELS OTHER THAN THE LEVEL OF EXIT DISCHARGE.

5. ELEVATORS COMPLYING WITH SECTION 1009.4, AND CHAPTER 11A, SECTION 1124A, OR CHAPTER 11B, SECTIONS 11B-206.6 AND 11B-407, AS APPLICABLE. 6. PLATFORM LIFTS COMPLYING WITH SECTION 1009.5 AND CHAPTER 11A, SECTION 1124A, OR CHAPTER 11B,

SECTIONS 11B-206.7, 11B-207.2 AND 11B-410 AS APPLICABLE. 7. HORIZONTAL EXITS COMPLYING WITH SECTION 1026.

8. RAMPS COMPLYING WITH SECTION 1012, AND CHAPTER 11A, SECTIONS 1114A AND 1122A, OR CHAPTER 11B, 11B-405, AS APPLICABLE.

9. AREAS OF REFUGE COMPLYING WITH SECTION 1009.6. 10. EXTERIOR AREAS FOR ASSISTED RESCUE COMPLYING WITH SECTION 1009.7 SERVING EXITS AT THE LEVEL OF EXIT DISCHARGE.

1009.2.1 ELEVATORS REQUIRED. IN BUILDINGS WHERE A REQUIRED ACCESSIBLE FLOOR IS FOUR OR MORE STORIES ABOVE OR BELOW A LEVEL OF EXIT DISCHARGE, NOT LESS THAN ONE REQUIRED ACCESSIBLE MEANS OF EGRESS SHALL BE AN ELEVATOR COMPLYING WITH SECTION 1009.4.

EXCEPTIONS:

CONJUNCTION WITH A HORIZONTAL EXIT.

1. IN BUILDINGS EQUIPPED THROUGHOUT WITH AN AUTOMATIC SPRINKLER SYSTEM INSTALLED IN ACCORDANCE WITH SECTION 903.3.1.1 OR 903.3.1.2, THE ELEVATOR SHALL NOT BE REQUIRED ON FLOORS PROVIDED WITH A HORIZONTAL EXIT AND LOCATED AT OR ABOVE THE LEVELS OF EXIT DISCHARGE. 2. IN BUILDINGS EQUIPPED THROUGHOUT WITH AN AUTOMATIC SPRINKLER SYSTEM INSTALLED IN ACCORDANCE WITH SECTION 903.3.1.1 OR 903.3.1.2, THE ELEVATOR SHALL NOT BE REQUIRED ON FLOORS PROVIDED WITH A RAMP CONFORMING TO THE PROVISIONS OF SECTION 1012.

1009.3 STAIRWAYS. IN ORDER TO BE CONSIDERED PART OF AN ACCESSIBLE MEANS OF EGRESS, A STAIRWAY BETWEEN STORIES SHALL HAVE A CLEAR WIDTH OF 48 INCHES (1219 MM) MINIMUM BETWEEN HANDRAILS AND SHALL EITHER INCORPORATE AN AREA OF REFUGE WITHIN AN ENLARGED FLOOR-LEVEL LANDING OR SHALL BE ACCESSED FROM AN AREA OF REFUGE COMPLYING WITH SECTION 1009.6. EXIT ACCESS STAIRWAYS THAT CONNECT LEVELS IN THE SAME STORY ARE NOT PERMITTED AS PART OF AN ACCESSIBLE MEANS OF EGRESS. [DSA-AC & HCD 1-AC] IN ADDITION, EXIT STAIRWAYS SHALL COMPLY WITH CHAPTER 11A, SECTIONS 1115A AND 1123A, OR CHAPTER 11B, SECTIONS 11B-210 AND 11B-504, AS APPLICABLE. EXCEPTIONS:

1. EXIT ACCESS STAIRWAYS PROVIDING MEANS OF EGRESS FROM MEZZANINES ARE PERMITTED AS PART OF AN ACCESSIBLE MEANS OF EGRESS.

2. THE CLEAR WIDTH OF 48 INCHES (1219 MM) BETWEEN HANDRAILS IS NOT REQUIRED IN BUILDINGS EQUIPPED THROUGHOUT WITH AN AUTOMATIC SPRINKLER SYSTEM INSTALLED IN ACCORDANCE WITH SECTION 903.3.1.1 OR 903.3.1.2.

3. THE CLEAR WIDTH OF 48 INCHES (1219 MM) BETWEEN HANDRAILS IS NOT REQUIRED FOR STAIRWAYS ACCESSED FROM A REFUGE AREA IN CONJUNCTION WITH A HORIZONTAL EXIT. 4. AREAS OF REFUGE ARE NOT REQUIRED AT EXIT ACCESS STAIR-WAYS WHERE TWO-WAY COMMUNICATION IS

PROVIDED AT THE ELEVATOR LANDING IN ACCORDANCE WITH SECTION 1009.8. 5. AREAS OF REFUGE ARE NOT REQUIRED AT STAIRWAYS IN BUILDINGS EQUIPPED THROUGHOUT WITH AN AUTOMATIC SPRINKLER SYSTEM INSTALLED IN ACCORDANCE WITH SECTION 903.3.1.1 OR 903.3.1.2. 6. AREAS OF REFUGE ARE NOT REQUIRED AT STAIRWAYS SERVING OPEN PARKING GARAGES. 7. AREAS OF REFUGE ARE NOT REQUIRED FOR SMOKE-PROTECTED ASSEMBLY SEATING AREAS COMPLYING

WITH SECTION 1029.6.2. 8. AREAS OF REFUGE ARE NOT REQUIRED AT STAIRWAYS IN GROUP R-2 OCCUPANCIES. 9. AREAS OF REFUGE ARE NOT REQUIRED FOR STAIRWAYS ACCESSED FROM A REFUGE AREA IN

1009.4 ELEVATORS. IN ORDER TO BE CONSIDERED PART OF AN ACCESSIBLE MEANS OF EGRESS, AN ELEVATOR SHALL COMPLY WITH THE EMERGENCY OPERATION AND SIGNALING DEVICE REQUIREMENTS OF CALIFORNIA CODE OF REGULATIONS, TITLE 8, DIVISION 1, CHAPTER 4, SUBCHAPTER 6, ELEVATOR SAFETY ORDERS. STANDBY POWER SHALL BE PROVIDED IN ACCORDANCE WITH CHAPTER 27 AND SECTION 3003. THE ELEVATOR SHALL BE ACCESSED FROM AN AREA OF REFUGE COMPLYING WITH SECTION 1009.6. EXCEPTIONS:

1. AREAS OF REFUGE ARE NOT REQUIRED AT THE ELEVATOR IN OPEN PARKING GARAGES. 2. AREAS OF REFUGE ARE NOT REQUIRED IN BUILDINGS AND FACILITIES EQUIPPED THROUGHOUT WITH AN AUTOMATIC SPRINKLER SYSTEM INSTALLED IN ACCORDANCE WITH SECTION 903.3.1.1 OR 903.3.1.2 3. AREAS OF REFUGE ARE NOT REQUIRED AT ELEVATORS NOT REQUIRED TO BE LOCATED IN A SHAFT IN ACCORDANCE WITH SECTION 712. 4. AREAS OF REFUGE ARE NOT REQUIRED AT ELEVATORS SERVING SMOKE-PROTECTED ASSEMBLY SEATING

AREAS COMPLYING WITH SECTION 1029.6.2. 5. AREAS OF REFUGE ARE NOT REQUIRED FOR ELEVATORS ACCESSED FROM A REFUGE AREA IN

CONJUNCTION WITH A HORIZONTAL EXIT.

LEGEND

ROON

	STAIR LOAD
EXIT STAIR OL - ### OF : ### ##" REQUIRED	CAPACITY FACTOR — PER CBC 2016 SECTION 1005.3.1
## REQUIRED + ##" PROVIDED -	REQUIRED WIDTH
•	PROVIDED WIDTH
EXIT DOOR	
OL - ### OF : ### ##" REQUIRED	CAPACITY FACTOR — PER CBC 2016 SECTION 1005.3.2
##" PROVIDED	REQUIRED WIDTH
	PROVIDED WIDTH
ROOM NAME	AREA
101 150 SF OF : ### OL - ###	OCCUPANT LOAD FACTOR PER CBC 2019 TABLE 1004.5
OCC. TYPE	OCCUPANT LOAD
	OCCUPANCY TYPE
####	ACCUMULATED LOAD AND TRAVEL DIRECTION
-	

●---->



PROJECT NAME

iVista@Alderwood

18799 ALDERWOOD MALL PARKWAY LYNNWOOD, WA 98037

OWNER NAME

ALDERWOOD INVESTMENTS LLC


18799 ALDERWOOD MALL PARKWAY

RADIM BLAZE TATE OF WASHING DATE ISSUES & REVISIONS 1 03/31/23 PDR SUBMITTAL -----_____ AS SHOWN SCALE PROJECT NUMBER 23.301 DESCRIPTION **EXITING PLAN - BASEMENT** SHEET NUMBER G0.51

EGRESS PATH OF

TRAVEL

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PARKING

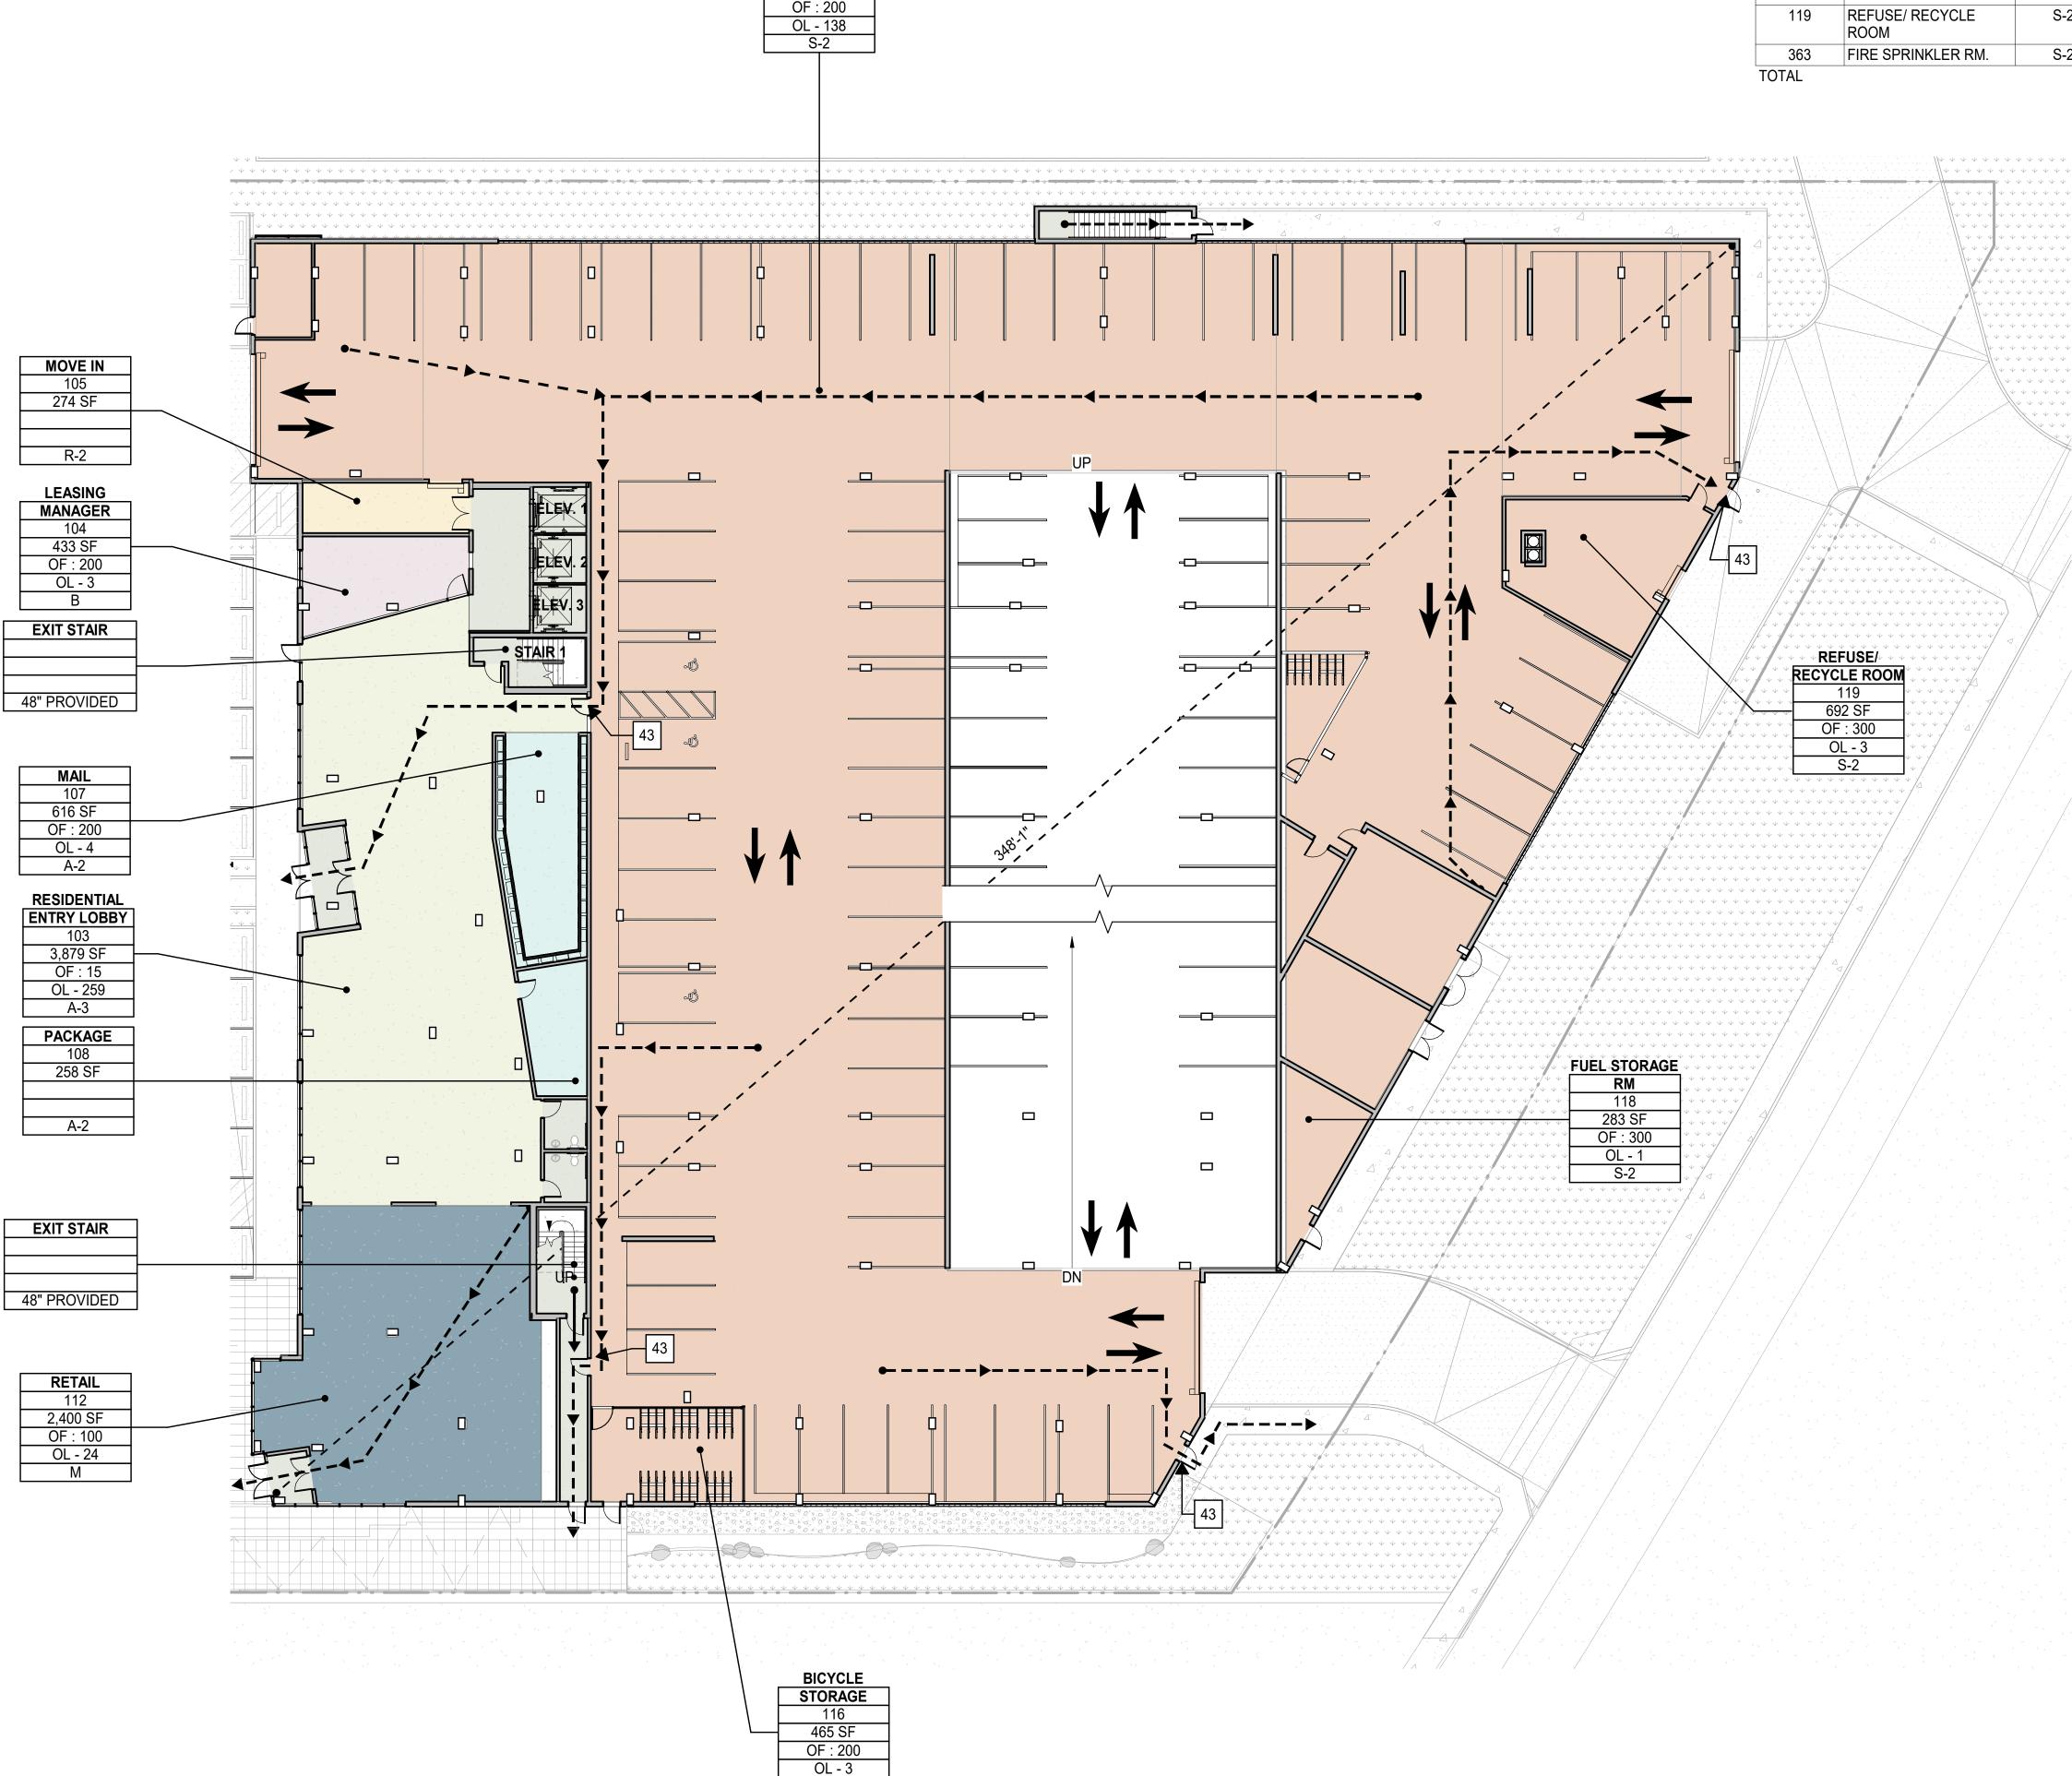GARAGE L1

101

27,556 SF

OCCUPANCY SCHEDULE - LEVEL 1					
NUMBER	NAME	OCCUPANCY	AREA	OCCUPANT FACTOR	OCCUPANT LOAD
LEVEL 1					
101	PARKING GARAGE L1	S-2	27,556 SF	200	138
103	RESIDENTIAL ENTRY LOBBY	A-3	3,879 SF	15	259
104	LEASING MANAGER	В	433 SF	200	3
105	MOVE IN	R-2	274 SF		
107	MAIL	A-2	616 SF	200	4
108	PACKAGE	A-2	258 SF		
112	RETAIL	М	2,400 SF	100	24
116	BICYCLE STORAGE	S-2	465 SF	200	3
117	TRANSFORMER RM	S-2	576 SF	300	2
117.1	BUILDING MAINT.	S-2	135 SF		
117.2	EMERGENCY GENERATOR	S-2	479 SF		
118	FUEL STORAGE RM	S-2	283 SF	300	1
119	REFUSE/ RECYCLE ROOM	S-2	692 SF	300	3
363	FIRE SPRINKLER RM.	S-2	173 SF		
TOTAL					437

ACCESSIBLE MEANS OF EGRESS

1009.1 ACCESSIBLE MEANS OF EGRESS REQUIRED. ACCESSIBLE MEANS OF EGRESS SHALL COMPLY WITH THIS SECTION. ACCESSIBLE SPACES SHALL BE PROVIDED WITH NOT LESS THAN ONE ACCESSIBLE MEANS OF EGRESS. WHERE MORE THAN ONE MEANS OF EGRESS ARE REQUIRED BY SECTION 1006.2 OR 1006.3 FROM ANY ACCESSIBLE SPACE, EACH ACCESSIBLE PORTION OF THE SPACE SHALL BE SERVED BY ACCESSIBLE MEANS OF EGRESS IN AT LEAST THE SAME NUMBER AS REQUIRED BY SECTIONS 1006.2 OR 1006.3. IN ADDITION TO THE REQUIREMENTS OF THIS CHAPTER, MEANS OF EGRESS, WHICH PROVIDE ACCESS TO, OR EGRESS FROM, BUILDINGS FOR PERSONS WITH DISABILI-TIES, SHALL ALSO COMPLY WITH THE REQUIREMENTS OF CHAPTER 11A OR 11B AS APPLICABLE.

EXCEPTIONS:

1. ACCESSIBLE MEANS OF EGRESS ARE NOT REQUIRED TO BE PROVIDED IN EXISTING BUILDINGS. 2. ONE ACCESSIBLE MEANS OF EGRESS IS REQUIRED FROM AN ACCESSIBLE MEZZANINE LEVEL IN ACCORDANCE WITH SECTION 1009.3, 1009.4 OR 1009.5, AND CHAPTER 11A OR 11B, AS APPLICABLE. 3. IN ASSEMBLY AREAS WITH RAMPED AISLES OR STEPPED AISLES. ONE ACCESSIBLE MEANS OF EGRESS IS PERMITTED WHERE THE COMMON PATH OF EGRESS TRAVEL IS ACCESSI-BLE AND MEETS THE REQUIREMENTS

IN SECTION 1029.8, AND CHAPTER 11A OR 11B, AS APPLICABLE.

1009.2 CONTINUITY AND COMPONENTS. EACH REQUIRED ACCESSIBLE MEANS OF EGRESS SHALL BE CONTINUOUS TO A PUBLIC WAY AND SHALL CONSIST OF ONE OR MORE OF THE FOLLOWING COMPONENTS: 1. ACCESSIBLE ROUTES COMPLYING WITH CHAPTER 11A, SECTIONS 1110A.1 AND 1120A, OR CHAPTER 11B, SECTIONS 11B-206 AND 11B-402, AS APPLICABLE

2. INTERIOR EXIT STAIRWAYS COMPLYING WITH SECTIONS 1009.3 AND 1023, AND CHAPTER 11A, SECTION 1123A, OR CHAPTER 11B, SECTIONS 11B-210 AND 11B-504, APPLICABLE. 3. EXIT ACCESS STAIRWAYS COMPLYING WITH SECTIONS 1009.3 AND 1019.3 OR 1019.4, CHAPTER 11A, SECTION

1123A, OR CHAPTER 11B, SECTIONS 11B-210 AND 11B-504, AS APPLICABLE. 4. EXTERIOR EXIT STAIRWAYS COMPLYING WITH SECTIONS 1009.3 AND 1027 AND CHAPTER 11A, SECTION 1115A, OR CHAPTER 11B, SECTIONS 11B-210 AND 11B-504, AS APPLICABLE AND SERVING LEVELS OTHER THAN THE LEVEL OF EXIT DISCHARGE.

5. ELEVATORS COMPLYING WITH SECTION 1009.4, AND CHAPTER 11A, SECTION 1124A, OR CHAPTER 11B, SECTIONS 11B-206.6 AND 11B-407, AS APPLICABLE. 6. PLATFORM LIFTS COMPLYING WITH SECTION 1009.5 AND CHAPTER 11A, SECTION 1124A, OR CHAPTER 11B,

SECTIONS 11B-206.7, 11B-207.2 AND 11B-410 AS APPLICABLE. 7. HORIZONTAL EXITS COMPLYING WITH SECTION 1026.

8. RAMPS COMPLYING WITH SECTION 1012, AND CHAPTER 11A, SECTIONS 1114A AND 1122A, OR CHAPTER 11B, 11B-405, AS APPLICABLE.

9. AREAS OF REFUGE COMPLYING WITH SECTION 1009.6. 10. EXTERIOR AREAS FOR ASSISTED RESCUE COMPLYING WITH SECTION 1009.7 SERVING EXITS AT THE LEVEL OF EXIT DISCHARGE.

1009.2.1 ELEVATORS REQUIRED. IN BUILDINGS WHERE A REQUIRED ACCESSIBLE FLOOR IS FOUR OR MORE STORIES ABOVE OR BELOW A LEVEL OF EXIT DISCHARGE, NOT LESS THAN ONE REQUIRED ACCESSIBLE MEANS OF EGRESS SHALL BE AN ELEVATOR COMPLYING WITH SECTION 1009.4.

EXCEPTIONS:

CONJUNCTION WITH A HORIZONTAL EXIT.

1. IN BUILDINGS EQUIPPED THROUGHOUT WITH AN AUTOMATIC SPRINKLER SYSTEM INSTALLED IN ACCORDANCE WITH SECTION 903.3.1.1 OR 903.3.1.2, THE ELEVATOR SHALL NOT BE REQUIRED ON FLOORS PROVIDED WITH A HORIZONTAL EXIT AND LOCATED AT OR ABOVE THE LEVELS OF EXIT DISCHARGE. 2. IN BUILDINGS EQUIPPED THROUGHOUT WITH AN AUTOMATIC SPRINKLER SYSTEM INSTALLED IN ACCORDANCE WITH SECTION 903.3.1.1 OR 903.3.1.2, THE ELEVATOR SHALL NOT BE REQUIRED ON FLOORS PROVIDED WITH A RAMP CONFORMING TO THE PROVISIONS OF SECTION 1012.

1009.3 STAIRWAYS. IN ORDER TO BE CONSIDERED PART OF AN ACCESSIBLE MEANS OF EGRESS, A STAIRWAY BETWEEN STORIES SHALL HAVE A CLEAR WIDTH OF 48 INCHES (1219 MM) MINIMUM BETWEEN HANDRAILS AND SHALL EITHER INCORPORATE AN AREA OF REFUGE WITHIN AN ENLARGED FLOOR-LEVEL LANDING OR SHALL BE ACCESSED FROM AN AREA OF REFUGE COMPLYING WITH SECTION 1009.6. EXIT ACCESS STAIRWAYS THAT CONNECT LEVELS IN THE SAME STORY ARE NOT PERMITTED AS PART OF AN ACCESSIBLE MEANS OF EGRESS. [DSA-AC & HCD 1-AC] IN ADDITION, EXIT STAIRWAYS SHALL COMPLY WITH CHAPTER 11A, SECTIONS 1115A AND 1123A, OR CHAPTER 11B, SECTIONS 11B-210 AND 11B-504, AS APPLICABLE. EXCEPTIONS:

1. EXIT ACCESS STAIRWAYS PROVIDING MEANS OF EGRESS FROM MEZZANINES ARE PERMITTED AS PART OF AN ACCESSIBLE MEANS OF EGRESS.

2. THE CLEAR WIDTH OF 48 INCHES (1219 MM) BETWEEN HANDRAILS IS NOT REQUIRED IN BUILDINGS EQUIPPED THROUGHOUT WITH AN AUTOMATIC SPRINKLER SYSTEM INSTALLED IN ACCORDANCE WITH SECTION 903.3.1.1 OR 903.3.1.2.

3. THE CLEAR WIDTH OF 48 INCHES (1219 MM) BETWEEN HANDRAILS IS NOT REQUIRED FOR STAIRWAYS ACCESSED FROM A REFUGE AREA IN CONJUNCTION WITH A HORIZONTAL EXIT. 4. AREAS OF REFUGE ARE NOT REQUIRED AT EXIT ACCESS STAIR-WAYS WHERE TWO-WAY COMMUNICATION IS PROVIDED AT THE ELEVATOR LANDING IN ACCORDANCE WITH SECTION 1009.8.

5. AREAS OF REFUGE ARE NOT REQUIRED AT STAIRWAYS IN BUILDINGS EQUIPPED THROUGHOUT WITH AN AUTOMATIC SPRINKLER SYSTEM INSTALLED IN ACCORDANCE WITH SECTION 903.3.1.1 OR 903.3.1.2. 6. AREAS OF REFUGE ARE NOT REQUIRED AT STAIRWAYS SERVING OPEN PARKING GARAGES. 7. AREAS OF REFUGE ARE NOT REQUIRED FOR SMOKE-PROTECTED ASSEMBLY SEATING AREAS COMPLYING

WITH SECTION 1029.6.2. 8. AREAS OF REFUGE ARE NOT REQUIRED AT STAIRWAYS IN GROUP R-2 OCCUPANCIES. 9. AREAS OF REFUGE ARE NOT REQUIRED FOR STAIRWAYS ACCESSED FROM A REFUGE AREA IN

1009.4 ELEVATORS. IN ORDER TO BE CONSIDERED PART OF AN ACCESSIBLE MEANS OF EGRESS, AN ELEVATOR SHALL COMPLY WITH THE EMERGENCY OPERATION AND SIGNALING DEVICE REQUIREMENTS OF CALIFORNIA CODE OF REGULATIONS, TITLE 8, DIVISION 1, CHAPTER 4, SUBCHAPTER 6, ELEVATOR SAFETY ORDERS. STANDBY POWER SHALL BE PROVIDED IN ACCORDANCE WITH CHAPTER 27 AND SECTION 3003. THE ELEVATOR SHALL BE ACCESSED FROM AN AREA OF REFUGE COMPLYING WITH SECTION 1009.6.

EXCEPTIONS: 1. AREAS OF REFUGE ARE NOT REQUIRED AT THE ELEVATOR IN OPEN PARKING GARAGES. 2. AREAS OF REFUGE ARE NOT REQUIRED IN BUILDINGS AND FACILITIES EQUIPPED THROUGHOUT WITH AN

AUTOMATIC SPRINKLER SYSTEM INSTALLED IN ACCORDANCE WITH SECTION 903.3.1.1 OR 903.3.1.2 3. AREAS OF REFUGE ARE NOT REQUIRED AT ELEVATORS NOT REQUIRED TO BE LOCATED IN A SHAFT IN ACCORDANCE WITH SECTION 712. 4. AREAS OF REFUGE ARE NOT REQUIRED AT ELEVATORS SERVING SMOKE-PROTECTED ASSEMBLY SEATING

AREAS COMPLYING WITH SECTION 1029.6.2. 5. AREAS OF REFUGE ARE NOT REQUIRED FOR ELEVATORS ACCESSED FROM A REFUGE AREA IN CONJUNCTION WITH A HORIZONTAL EXIT.

LEGEND

	-STAIR LOAD
EXIT STAIR OL - ### OF : ###	CAPACITY FACTOR —PER CBC 2016 SECTION 1005.3.1
##" REQUIRED ##" PROVIDED	REQUIRED WIDTH
•	PROVIDED WIDTH
EXIT DOOR OL - ### OF : ### ##" REQUIRED ##" PROVIDED	 DOOR LOAD CAPACITY FACTOR PER CBC 2016 SECTION 1005.3.2 REQUIRED WIDTH PROVIDED WIDTH
ROOM NAME 101 150 SF OF : ### OL - ### OCC. TYPE	-ROOM NUMBER -AREA -OCCUPANT LOAD FACTOR PER CBC 2019 TABLE 1004.5 -OCCUPANT LOAD
###	OCCUPANCY TYPE ACCUMULATED LOAD AND TRAVEL DIRECTION
•>	EGRESS PATH OF TRAVEL



PROJECT NAME

iVista@Alderwood

18799 ALDERWOOD MALL PARKWAY LYNNWOOD, WA 98037

OWNER NAME


ALDERWOOD **INVESTMENTS LLC**

18799 ALDERWOOD MALL PARKWAY

1 03/31/23 PDR SUBMITTAL AS SHOWN PROJECT NUMBER 23.301 DESCRIPTION **EXITING PLAN - LEVEL 1** SHEET NUMBER G0.52 ALL DRAWINGS AND WRITTEN MATERIAL APPEARING HEREIN CONSTITUTE ORIGINAL AND UNPUBLISHED WORK OF THE DESIGN PROFESSIONAL AND MAY NOT BE DUPLICATED, USED OR DISCLOSED WITHOUT WRITTEN CONSENT OF THE DESIGN PROFESSIONAL

DATE ISSUES & REVISIONS

STATE OF WASHINGT

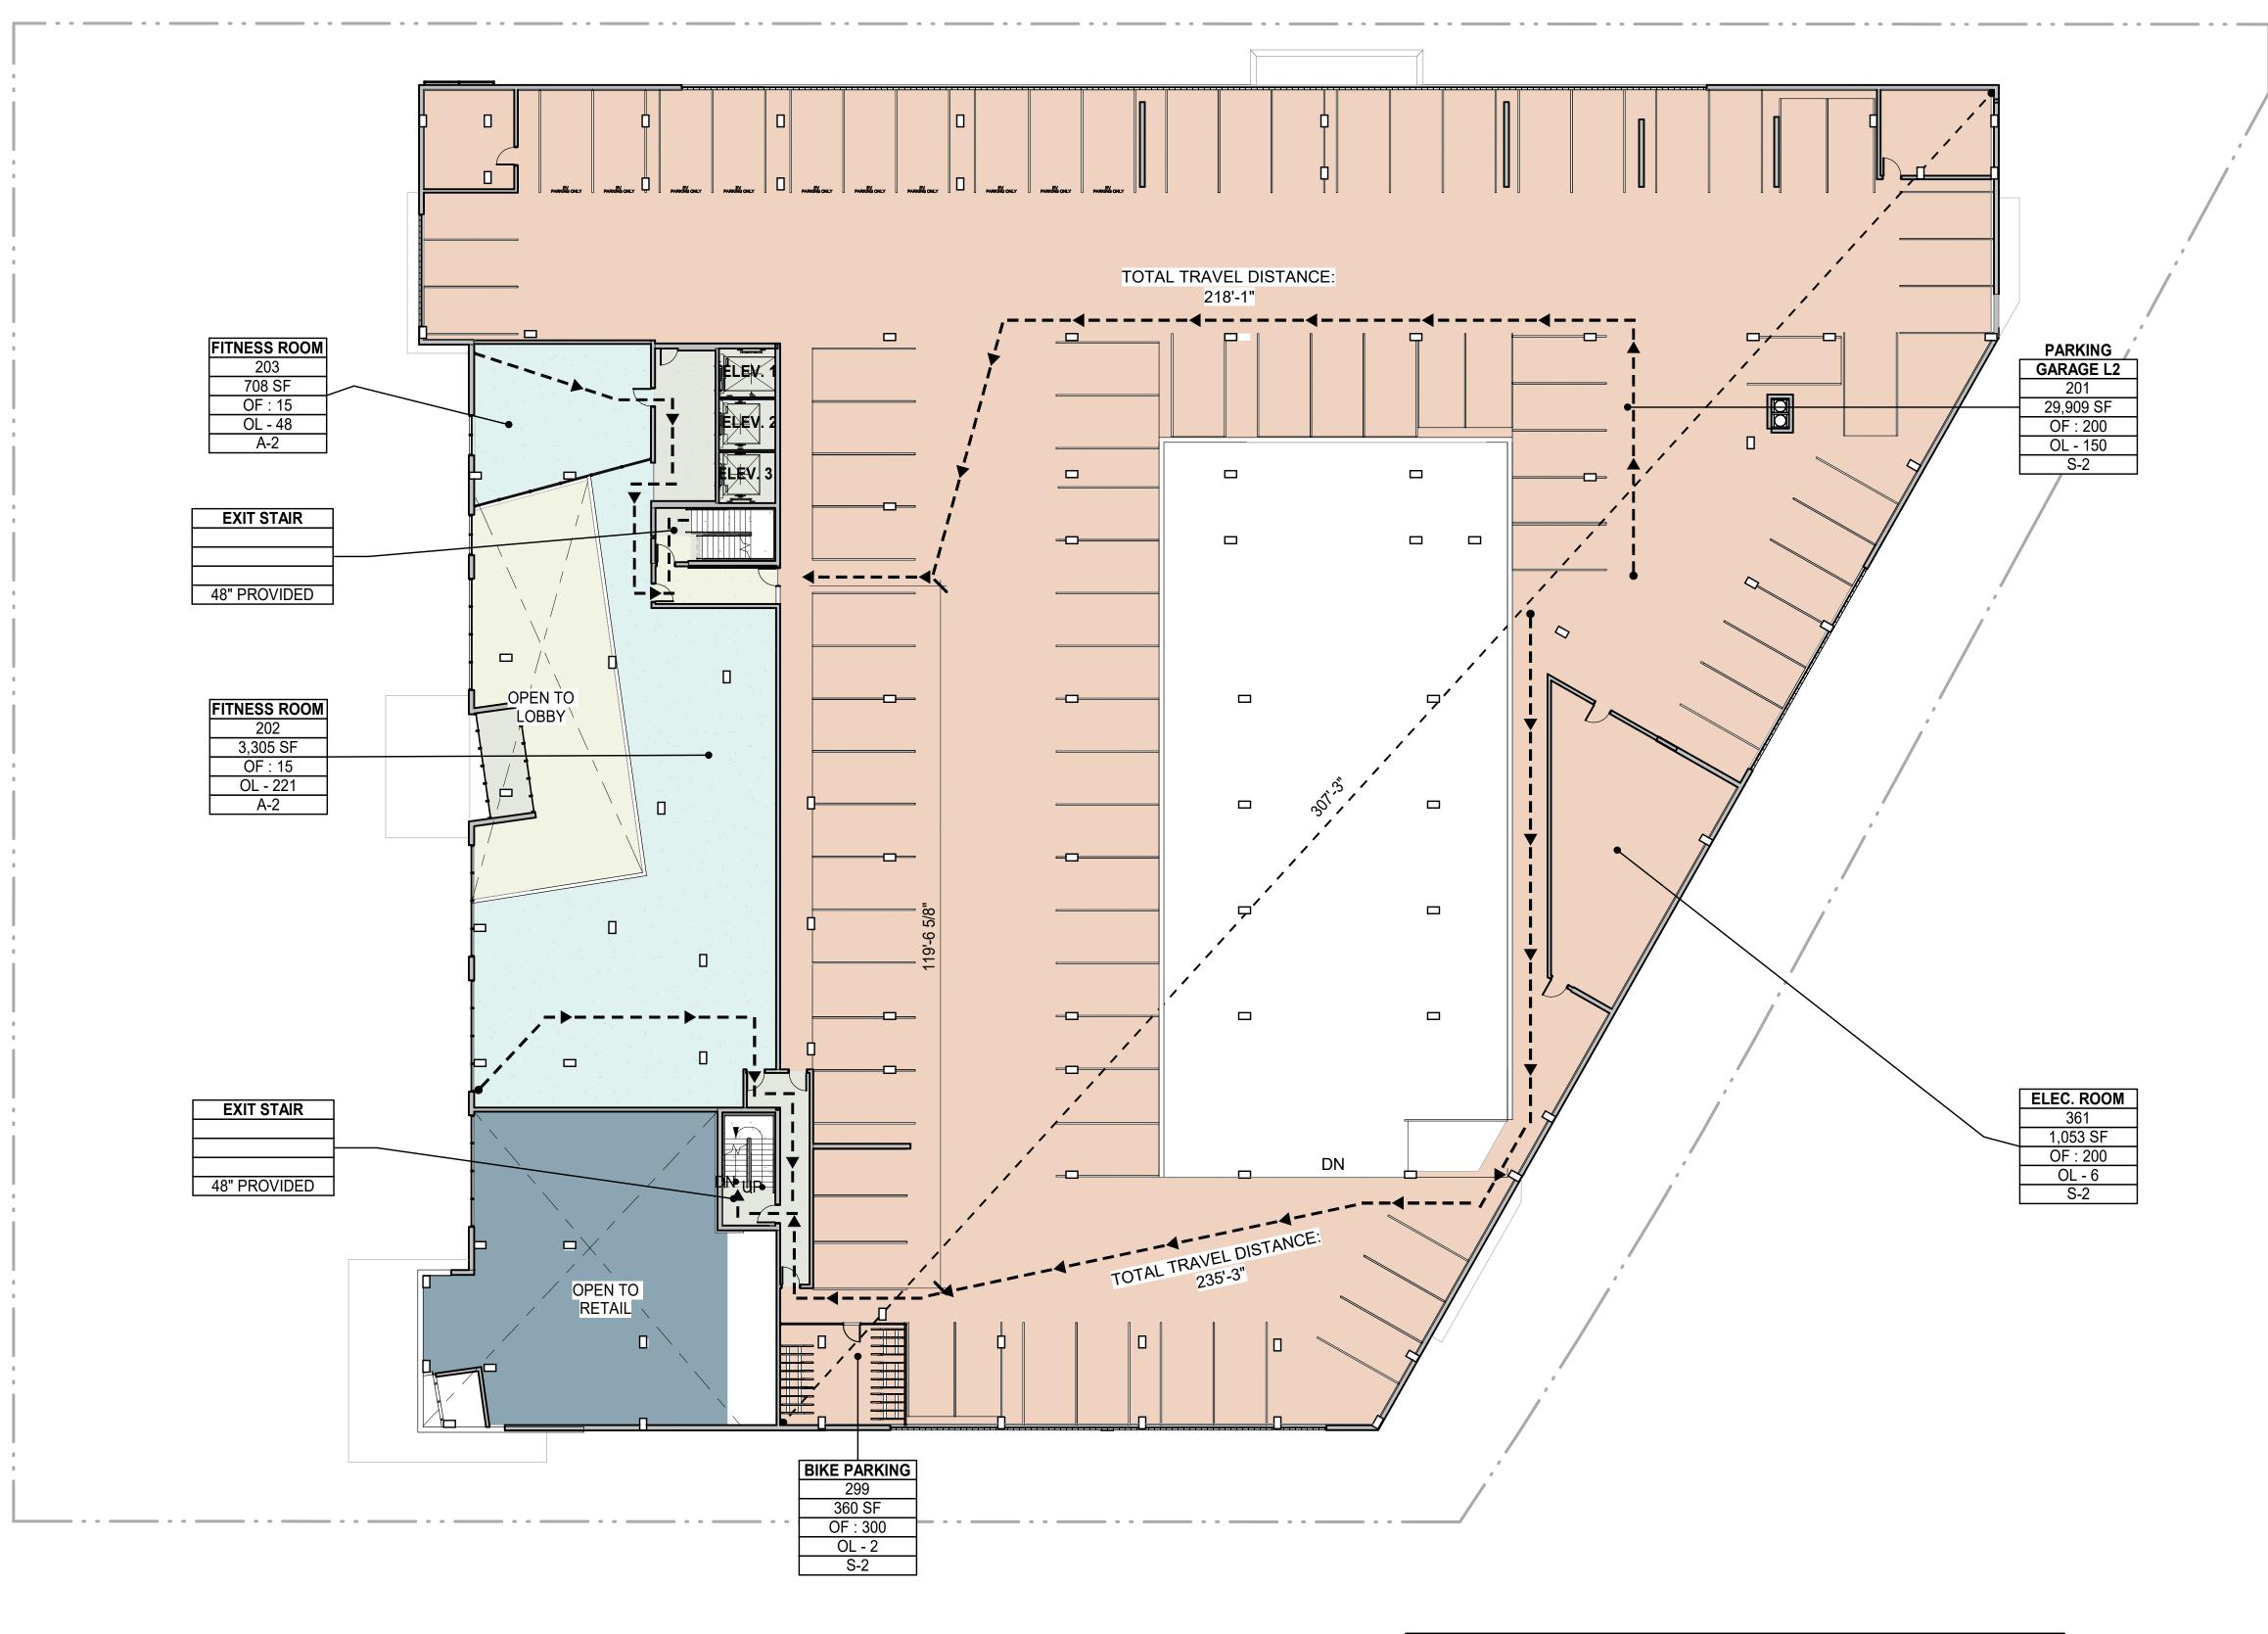

OCCUPANCY SCHEDULE - LEVEL 2					
NUMBER	NAME	OCCUPANCY	AREA	OCCUPANT FACTOR	OCCUPANT LOAD
LEVEL 2					
201	PARKING GARAGE L2	S-2	29,909 SF	200	150
202	FITNESS ROOM	A-2	3,305 SF	15	221
203	FITNESS ROOM	A-2	708 SF	15	48
299	BIKE PARKING	S-2	360 SF	300	2
361	ELEC. ROOM	S-2	1,053 SF	200	6
364	STORAGE	S-2	258 SF	300	1
530	STORAGE	S-2	274 SF		
TOTAL				1	428

LEVEL 2 - EXITING PLAN SCALE: 1/16" = 1'-0"

SECTION 1009

ACCESSIBLE MEANS OF EGRESS

1009.1 ACCESSIBLE MEANS OF EGRESS REQUIRED. ACCESSIBLE MEANS OF EGRESS SHALL COMPLY WITH THIS SECTION. ACCESSIBLE SPACES SHALL BE PROVIDED WITH NOT LESS THAN ONE ACCESSIBLE MEANS OF EGRESS. WHERE MORE THAN ONE MEANS OF EGRESS ARE REQUIRED BY SECTION 1006.2 OR 1006.3 FROM ANY ACCESSIBLE SPACE, EACH ACCESSIBLE PORTION OF THE SPACE SHALL BE SERVED BY ACCESSIBLE MEANS OF EGRESS IN AT LEAST THE SAME NUMBER AS REQUIRED BY SECTIONS 1006.2 OR 1006.3. IN ADDITION TO THE REQUIREMENTS OF THIS CHAPTER, MEANS OF EGRESS, WHICH PROVIDE ACCESS TO, OR EGRESS FROM, BUILDINGS FOR PERSONS WITH DISABILI-TIES, SHALL ALSO COMPLY WITH THE REQUIREMENTS OF CHAPTER 11A OR 11B AS APPLICABLE.

EXCEPTIONS:

1. ACCESSIBLE MEANS OF EGRESS ARE NOT REQUIRED TO BE PROVIDED IN EXISTING BUILDINGS. 2. ONE ACCESSIBLE MEANS OF EGRESS IS REQUIRED FROM AN ACCESSIBLE MEZZANINE LEVEL IN ACCORDANCE WITH SECTION 1009.3, 1009.4 OR 1009.5, AND CHAPTER 11A OR 11B, AS APPLICABLE. 3. IN ASSEMBLY AREAS WITH RAMPED AISLES OR STEPPED AISLES, ONE ACCESSIBLE MEANS OF EGRESS IS PERMITTED WHERE THE COMMON PATH OF EGRESS TRAVEL IS ACCESSI-BLE AND MEETS THE REQUIREMENTS IN SECTION 1029.8, AND CHAPTER 11A OR 11B, AS APPLICABLE.

1009.2 CONTINUITY AND COMPONENTS. EACH REQUIRED ACCESSIBLE MEANS OF EGRESS SHALL BE CONTINUOUS TO A PUBLIC WAY AND SHALL CONSIST OF ONE OR MORE OF THE FOLLOWING COMPONENTS: 1. ACCESSIBLE ROUTES COMPLYING WITH CHAPTER 11A, SECTIONS 1110A.1 AND 1120A, OR CHAPTER 11B, SECTIONS 11B-206 AND 11B-402, AS APPLICABLE

2. INTERIOR EXIT STAIRWAYS COMPLYING WITH SECTIONS 1009.3 AND 1023, AND CHAPTER 11A, SECTION 1123A, OR CHAPTER 11B, SECTIONS 11B-210 AND 11B-504, APPLICABLE. 3. EXIT ACCESS STAIRWAYS COMPLYING WITH SECTIONS 1009.3 AND 1019.3 OR 1019.4, CHAPTER 11A, SECTION

1123A, OR CHAPTER 11B, SECTIONS 11B-210 AND 11B-504, AS APPLICABLE. 4. EXTERIOR EXIT STAIRWAYS COMPLYING WITH SECTIONS 1009.3 AND 1027 AND CHAPTER 11A, SECTION 1115A, OR CHAPTER 11B, SECTIONS 11B-210 AND 11B-504, AS APPLICABLE AND SERVING LEVELS OTHER THAN THE

LEVEL OF EXIT DISCHARGE. 5. ELEVATORS COMPLYING WITH SECTION 1009.4, AND CHAPTER 11A, SECTION 1124A, OR CHAPTER 11B, SECTIONS 11B-206.6 AND 11B-407, AS APPLICABLE.

6. PLATFORM LIFTS COMPLYING WITH SECTION 1009.5 AND CHAPTER 11A, SECTION 1124A, OR CHAPTER 11B, SECTIONS 11B-206.7, 11B-207.2 AND 11B-410 AS APPLICABLE. 7. HORIZONTAL EXITS COMPLYING WITH SECTION 1026.

8. RAMPS COMPLYING WITH SECTION 1012, AND CHAPTER 11A, SECTIONS 1114A AND 1122A, OR CHAPTER 11B, 11B-405, AS APPLICABLE.

9. AREAS OF REFUGE COMPLYING WITH SECTION 1009.6. 10. EXTERIOR AREAS FOR ASSISTED RESCUE COMPLYING WITH SECTION 1009.7 SERVING EXITS AT THE LEVEL OF EXIT DISCHARGE.

1009.2.1 ELEVATORS REQUIRED. IN BUILDINGS WHERE A REQUIRED ACCESSIBLE FLOOR IS FOUR OR MORE STORIES ABOVE OR BELOW A LEVEL OF EXIT DISCHARGE, NOT LESS THAN ONE REQUIRED ACCESSIBLE MEANS OF EGRESS SHALL BE AN ELEVATOR COMPLYING WITH SECTION 1009.4.

EXCEPTIONS: 1. IN BUILDINGS EQUIPPED THROUGHOUT WITH AN AUTOMATIC SPRINKLER SYSTEM INSTALLED IN ACCORDANCE WITH SECTION 903.3.1.1 OR 903.3.1.2, THE ELEVATOR SHALL NOT BE REQUIRED ON FLOORS PROVIDED WITH A HORIZONTAL EXIT AND LOCATED AT OR ABOVE THE LEVELS OF EXIT DISCHARGE. 2. IN BUILDINGS EQUIPPED THROUGHOUT WITH AN AUTOMATIC SPRINKLER SYSTEM INSTALLED IN ACCORDANCE WITH SECTION 903.3.1.1 OR 903.3.1.2, THE ELEVATOR SHALL NOT BE REQUIRED ON FLOORS PROVIDED WITH A RAMP CONFORMING TO THE PROVISIONS OF SECTION 1012.

1009.3 STAIRWAYS. IN ORDER TO BE CONSIDERED PART OF AN ACCESSIBLE MEANS OF EGRESS, A STAIRWAY BETWEEN STORIES SHALL HAVE A CLEAR WIDTH OF 48 INCHES (1219 MM) MINIMUM BETWEEN HANDRAILS AND SHALL EITHER INCORPORATE AN AREA OF REFUGE WITHIN AN ENLARGED FLOOR-LEVEL LANDING OR SHALL BE ACCESSED FROM AN AREA OF REFUGE COMPLYING WITH SECTION 1009.6. EXIT ACCESS STAIRWAYS THAT CONNECT LEVELS IN THE SAME STORY ARE NOT PERMITTED AS PART OF AN ACCESSIBLE MEANS OF EGRESS. [DSA-AC & HCD 1-AC] IN ADDITION, EXIT STAIRWAYS SHALL COMPLY WITH CHAPTER 11A, SECTIONS 1115A AND 1123A, OR CHAPTER 11B, SECTIONS 11B-210 AND 11B-504, AS APPLICABLE. EXCEPTIONS:

1. EXIT ACCESS STAIRWAYS PROVIDING MEANS OF EGRESS FROM MEZZANINES ARE PERMITTED AS PART OF AN ACCESSIBLE MEANS OF EGRESS.

2. THE CLEAR WIDTH OF 48 INCHES (1219 MM) BETWEEN HANDRAILS IS NOT REQUIRED IN BUILDINGS EQUIPPED THROUGHOUT WITH AN AUTOMATIC SPRINKLER SYSTEM INSTALLED IN ACCORDANCE WITH SECTION 903.3.1.1 OR 903.3.1.2.

3. THE CLEAR WIDTH OF 48 INCHES (1219 MM) BETWEEN HANDRAILS IS NOT REQUIRED FOR STAIRWAYS ACCESSED FROM A REFUGE AREA IN CONJUNCTION WITH A HORIZONTAL EXIT. 4. AREAS OF REFUGE ARE NOT REQUIRED AT EXIT ACCESS STAIR-WAYS WHERE TWO-WAY COMMUNICATION IS

PROVIDED AT THE ELEVATOR LANDING IN ACCORDANCE WITH SECTION 1009.8. 5. AREAS OF REFUGE ARE NOT REQUIRED AT STAIRWAYS IN BUILDINGS EQUIPPED THROUGHOUT WITH AN AUTOMATIC SPRINKLER SYSTEM INSTALLED IN ACCORDANCE WITH SECTION 903.3.1.1 OR 903.3.1.2. 6. AREAS OF REFUGE ARE NOT REQUIRED AT STAIRWAYS SERVING OPEN PARKING GARAGES. 7. AREAS OF REFUGE ARE NOT REQUIRED FOR SMOKE-PROTECTED ASSEMBLY SEATING AREAS COMPLYING

WITH SECTION 1029.6.2. 8. AREAS OF REFUGE ARE NOT REQUIRED AT STAIRWAYS IN GROUP R-2 OCCUPANCIES. 9. AREAS OF REFUGE ARE NOT REQUIRED FOR STAIRWAYS ACCESSED FROM A REFUGE AREA IN

CONJUNCTION WITH A HORIZONTAL EXIT. **1009.4 ELEVATORS.** IN ORDER TO BE CONSIDERED PART OF AN ACCESSIBLE MEANS OF EGRESS, AN ELEVATOR SHALL COMPLY WITH THE EMERGENCY OPERATION AND SIGNALING DEVICE REQUIREMENTS OF CALIFORNIA CODE OF REGULATIONS, TITLE 8, DIVISION 1, CHAPTER 4, SUBCHAPTER 6, ELEVATOR SAFETY ORDERS. STANDBY POWER SHALL BE PROVIDED IN ACCORDANCE WITH CHAPTER 27 AND SECTION 3003.

THE ELEVATOR SHALL BE ACCESSED FROM AN AREA OF REFUGE COMPLYING WITH SECTION 1009.6. EXCEPTIONS: 1. AREAS OF REFUGE ARE NOT REQUIRED AT THE ELEVATOR IN OPEN PARKING GARAGES.

2. AREAS OF REFUGE ARE NOT REQUIRED IN BUILDINGS AND FACILITIES EQUIPPED THROUGHOUT WITH AN AUTOMATIC SPRINKLER SYSTEM INSTALLED IN ACCORDANCE WITH SECTION 903.3.1.1 OR 903.3.1.2 3. AREAS OF REFUGE ARE NOT REQUIRED AT ELEVATORS NOT REQUIRED TO BE LOCATED IN A SHAFT IN ACCORDANCE WITH SECTION 712.

4. AREAS OF REFUGE ARE NOT REQUIRED AT ELEVATORS SERVING SMOKE-PROTECTED ASSEMBLY SEATING AREAS COMPLYING WITH SECTION 1029.6.2. 5. AREAS OF REFUGE ARE NOT REQUIRED FOR ELEVATORS ACCESSED FROM A REFUGE AREA IN

CONJUNCTION WITH A HORIZONTAL EXIT.


ELEC. ROOM
361
1,053 SF
OF : 200
OL - 6
S-2

LEGEND

	—STAIR LOAD
EXIT STAIR OL - ### OF : ###	CAPACITY FACTOR —PER CBC 2016 SECTION 1005.3.1
##" REQUIRED ##" PROVIDED	REQUIRED WIDTH
	PROVIDED WIDTH
EXIT DOOR OL - ### OF : ### ##" REQUIRED ##" PROVIDED	 DOOR LOAD CAPACITY FACTOR PER CBC 2016 SECTION 1005.3.2 REQUIRED WIDTH PROVIDED WIDTH
	—ROOM NUMBER —AREA
101 150 SF OF : ### OL - ###	OCCUPANT LOAD FACTOR PER CBC 2019 TABLE 1004.5
OCC. TYPE	-OCCUPANT LOAD
	OCCUPANCY TYPE
###	ACCUMULATED LOAD AND TRAVEL DIRECTION
•>	EGRESS PATH OF

TRAVEL

A 12

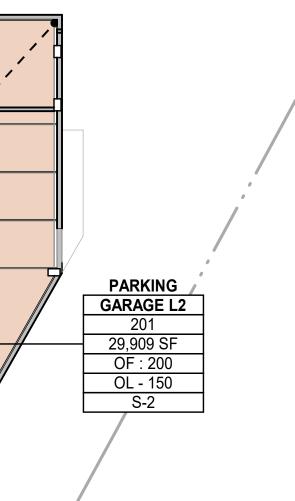



PROJECT NAME

iVista@Alderwood

18799 ALDERWOOD MALL PARKWAY LYNNWOOD, WA 98037

OWNER NAME


ALDERWOOD INVESTMENTS LLC

18799 ALDERWOOD MALL PARKWAY

A DATE ISSUES & REVISIONS 1 03/31/23 PDR SUBMITTAL AS SHOWN PROJECT NUMBER 23.301 DESCRIPTION EXITING PLAN - LEVEL 2 SHEET NUMBER G0.53 ALL DRAWINGS AND WRITTEN MATERIAL APPEARING HEREIN CONSTITUTE ORIGINAL AND UNPUBLISHED WORK OF THE DESIGN PROFESSIONAL AND MAY NOT BE DUPLICATED, USED OR DISCLOSED WITHOUT WRITTEN CONSENT OF THE DESIGN PROFESSIONAL

STATE OF WASHINGT

OCCUPANCY SCHEDULE - LEVEL 3					
NUMBER	NAME	OCCUPANCY	AREA	OCCUPANT FACTOR	OCCUPANT LOAD
EVEL 3					
301	3-BR	R-2	1,270 SF	200	7
302	INDOOR AMENITY - AREA 1	A-2	936 SF		
303	1-BR	R-2	642 SF	200	4
304	MOVIE ROOM	A-2	306 SF		
305	2-BR	R-2	875 SF	200	5
306	1-BR	R-2	577 SF	200	3
307	2-BR	R-2	877 SF	200	5
308	1-BR	R-2	578 SF	200	3
309	2-BR	R-2	878 SF	200	5
310	1-BR	R-2	578 SF	200	3
311	2-BR	R-2	877 SF	200	5
312	1-BR W DEN	R-2	810 SF	200	5
313	1-BR	R-2	613 SF	200	4
314	TENANT STORAGE	S-2	203 SF	300	1
315	1-BR	R-2	605 SF	200	4
316	ELEC. ROOM	S-2	185 SF	300	1
317	3-BR	R-2	1,230 SF	200	7
318	PANTRY	S-2	47 SF		
319	2-BR	R-2	968 SF	200	5
320	1-BR W DEN	R-2	793 SF	200	4
321	2-BR	R-2	878 SF	200	5
322	2-BR	R-2	770 SF	200	4
323	2-BR	R-2	940 SF	200	5
324	1-BR	R-2	576 SF	200	3
325	1-BR	R-2	723 SF	200	4

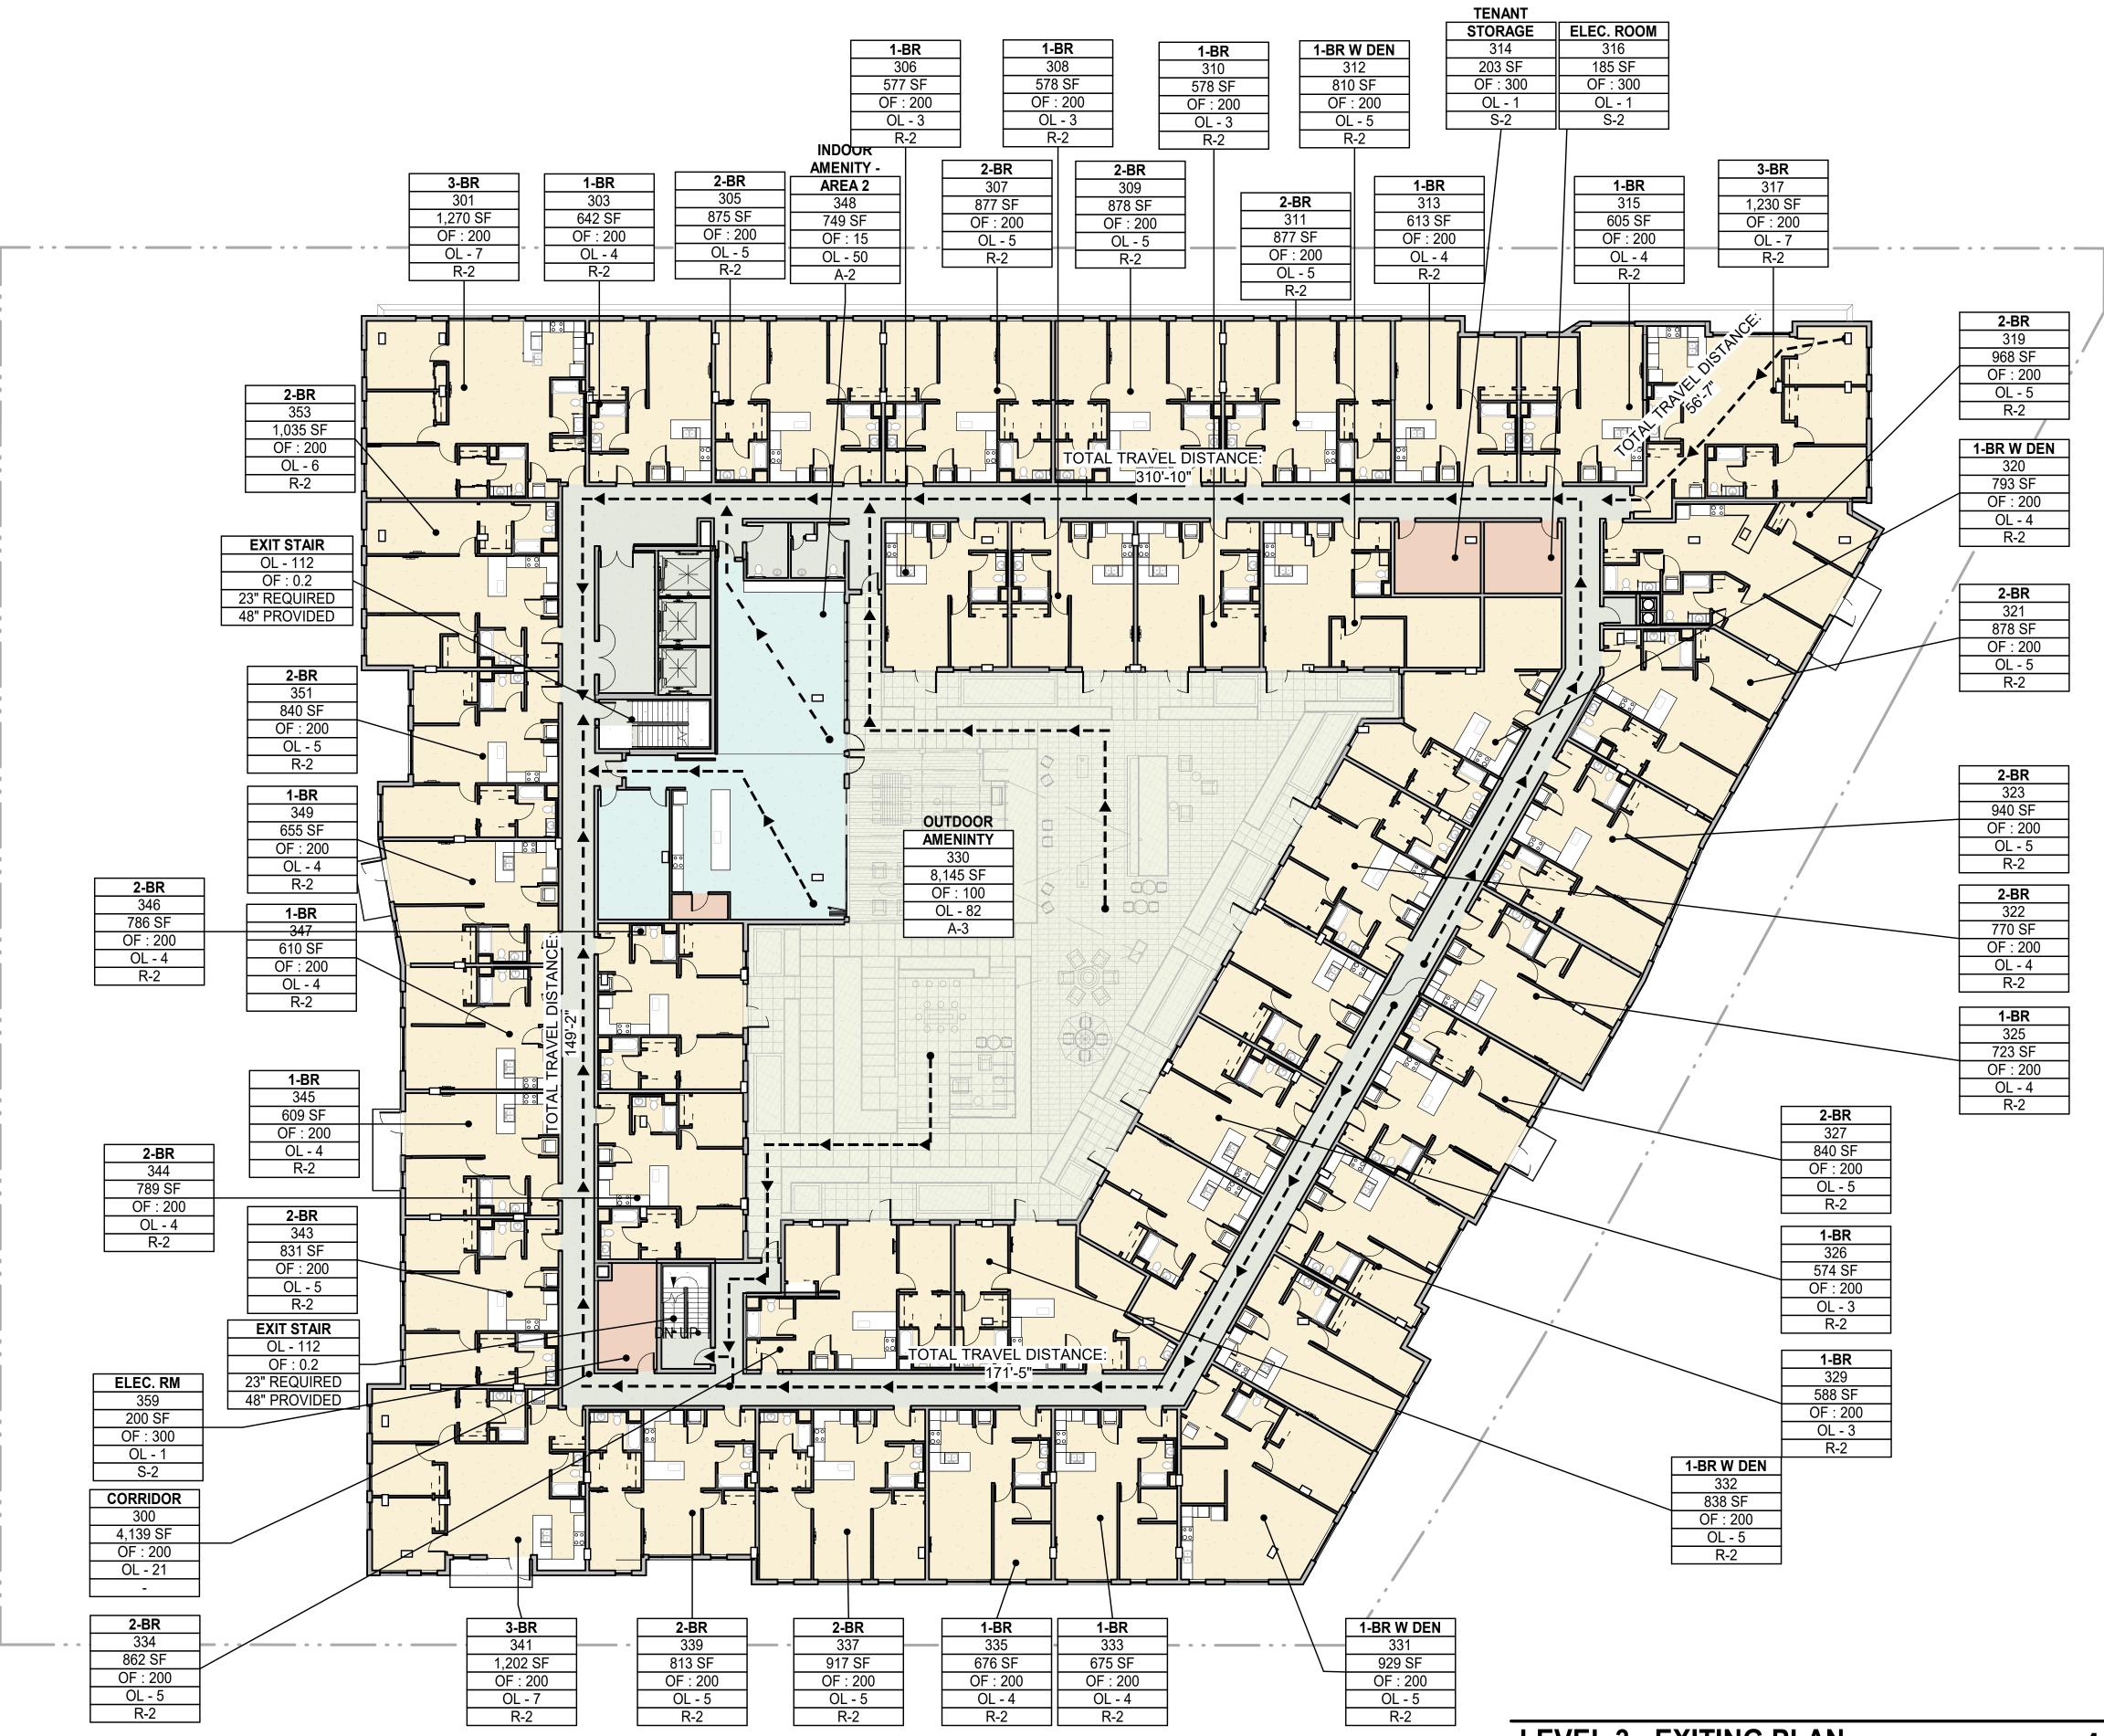

OCCUPANCY SCHEDULE - LEVEL 3					
NUMBER	NAME	OCCUPANCY	AREA	OCCUPANT FACTOR	OCCUPANT LOAI
326	1-BR	R-2	574 SF	200	3
327	2-BR	R-2	840 SF	200	5
328	1-BR W DEN	R-2	656 SF	200	4
329	1-BR	R-2	588 SF	200	3
330	OUTDOOR AMENINTY	A-3	8,145 SF	100	82
330	1-BR	R-2	710 SF	200	4
331	1-BR W DEN	R-2	929 SF	200	5
332	1-BR W DEN	R-2	838 SF	200	5
333	1-BR	R-2	675 SF	200	4
334	2-BR	R-2	862 SF	200	5
335	1-BR	R-2	676 SF	200	4
337	2-BR	R-2	917 SF	200	5
339	2-BR	R-2	813 SF	200	5
341	3-BR	R-2	1,202 SF	200	7
343	2-BR	R-2	831 SF	200	5
344	2-BR	R-2	789 SF	200	4
345	1-BR	R-2	609 SF	200	4
346	2-BR	R-2	786 SF	200	4
347	1-BR	R-2	610 SF	200	4
348	INDOOR AMENITY - AREA 2	A-2	749 SF	15	50
349	1-BR	R-2	655 SF	200	4
351	2-BR	R-2	840 SF	200	5
353	2-BR	R-2	1,035 SF	200	6
359	ELEC. RM	S-2	200 SF	300	1

LEVEL 3 - EXITING PLAN SCALE: 1/16" = 1'-0"

SECTION 1009

ACCESSIBLE MEANS OF EGRESS

1009.1 ACCESSIBLE MEANS OF EGRESS REQUIRED. ACCESSIBLE MEANS OF EGRESS SHALL COMPLY WITH THIS SECTION. ACCESSIBLE SPACES SHALL BE PROVIDED WITH NOT LESS THAN ONE ACCESSIBLE MEANS OF EGRESS. WHERE MORE THAN ONE MEANS OF EGRESS ARE REQUIRED BY SECTION 1006.2 OR 1006.3 FROM ANY ACCESSIBLE SPACE, EACH ACCESSIBLE PORTION OF THE SPACE SHALL BE SERVED BY ACCESSIBLE MEANS OF EGRESS IN AT LEAST THE SAME NUMBER AS REQUIRED BY SECTIONS 1006.2 OR 1006.3. IN ADDITION TO THE REQUIREMENTS OF THIS CHAPTER, MEANS OF EGRESS, WHICH PROVIDE ACCESS TO, OR EGRESS FROM, BUILDINGS FOR PERSONS WITH DISABILI-TIES, SHALL ALSO COMPLY WITH THE REQUIREMENTS OF CHAPTER 11A OR 11B AS APPLICABLE.

EXCEPTIONS:

1. ACCESSIBLE MEANS OF EGRESS ARE NOT REQUIRED TO BE PROVIDED IN EXISTING BUILDINGS. 2. ONE ACCESSIBLE MEANS OF EGRESS IS REQUIRED FROM AN ACCESSIBLE MEZZANINE LEVEL IN ACCORDANCE WITH SECTION 1009.3, 1009.4 OR 1009.5, AND CHAPTER 11A OR 11B, AS APPLICABLE. 3. IN ASSEMBLY AREAS WITH RAMPED AISLES OR STEPPED AISLES, ONE ACCESSIBLE MEANS OF EGRESS IS PERMITTED WHERE THE COMMON PATH OF EGRESS TRAVEL IS ACCESSI-BLE AND MEETS THE REQUIREMENTS IN SECTION 1029.8, AND CHAPTER 11A OR 11B, AS APPLICABLE.

1009.2 CONTINUITY AND COMPONENTS. EACH REQUIRED ACCESSIBLE MEANS OF EGRESS SHALL BE CONTINUOUS TO A PUBLIC WAY AND SHALL CONSIST OF ONE OR MORE OF THE FOLLOWING COMPONENTS: 1. ACCESSIBLE ROUTES COMPLYING WITH CHAPTER 11A, SECTIONS 1110A.1 AND 1120A, OR CHAPTER 11B, SECTIONS 11B-206 AND 11B-402, AS APPLICABLE

2. INTERIOR EXIT STAIRWAYS COMPLYING WITH SECTIONS 1009.3 AND 1023, AND CHAPTER 11A, SECTION 1123A, OR CHAPTER 11B, SECTIONS 11B-210 AND 11B-504, APPLICABLE. 3. EXIT ACCESS STAIRWAYS COMPLYING WITH SECTIONS 1009.3 AND 1019.3 OR 1019.4, CHAPTER 11A, SECTION

1123A. OR CHAPTER 11B. SECTIONS 11B-210 AND 11B-504. AS APPLICABLE. 4. EXTERIOR EXIT STAIRWAYS COMPLYING WITH SECTIONS 1009.3 AND 1027 AND CHAPTER 11A, SECTION 1115A, OR CHAPTER 11B, SECTIONS 11B-210 AND 11B-504, AS APPLICABLE AND SERVING LEVELS OTHER THAN THE

LEVEL OF EXIT DISCHARGE. 5. ELEVATORS COMPLYING WITH SECTION 1009.4, AND CHAPTER 11A, SECTION 1124A, OR CHAPTER 11B, SECTIONS 11B-206.6 AND 11B-407, AS APPLICABLE.

6. PLATFORM LIFTS COMPLYING WITH SECTION 1009.5 AND CHAPTER 11A, SECTION 1124A, OR CHAPTER 11B, SECTIONS 11B-206.7, 11B-207.2 AND 11B-410 AS APPLICABLE. 7. HORIZONTAL EXITS COMPLYING WITH SECTION 1026.

8. RAMPS COMPLYING WITH SECTION 1012, AND CHAPTER 11A, SECTIONS 1114A AND 1122A, OR CHAPTER 11B, 11B-405, AS APPLICABLE.

9. AREAS OF REFUGE COMPLYING WITH SECTION 1009.6. 10. EXTERIOR AREAS FOR ASSISTED RESCUE COMPLYING WITH SECTION 1009.7 SERVING EXITS AT THE LEVEL OF EXIT DISCHARGE.

1009.2.1 ELEVATORS REQUIRED. IN BUILDINGS WHERE A REQUIRED ACCESSIBLE FLOOR IS FOUR OR MORE STORIES ABOVE OR BELOW A LEVEL OF EXIT DISCHARGE, NOT LESS THAN ONE REQUIRED ACCESSIBLE MEANS OF EGRESS SHALL BE AN ELEVATOR COMPLYING WITH SECTION 1009.4.

EXCEPTIONS:

1. IN BUILDINGS EQUIPPED THROUGHOUT WITH AN AUTOMATIC SPRINKLER SYSTEM INSTALLED IN ACCORDANCE WITH SECTION 903.3.1.1 OR 903.3.1.2, THE ELEVATOR SHALL NOT BE REQUIRED ON FLOORS PROVIDED WITH A HORIZONTAL EXIT AND LOCATED AT OR ABOVE THE LEVELS OF EXIT DISCHARGE. 2. IN BUILDINGS EQUIPPED THROUGHOUT WITH AN AUTOMATIC SPRINKLER SYSTEM INSTALLED IN ACCORDANCE WITH SECTION 903.3.1.1 OR 903.3.1.2, THE ELEVATOR SHALL NOT BE REQUIRED ON FLOORS PROVIDED WITH A RAMP CONFORMING TO THE PROVISIONS OF SECTION 1012.

1009.3 STAIRWAYS. IN ORDER TO BE CONSIDERED PART OF AN ACCESSIBLE MEANS OF EGRESS, A STAIRWAY BETWEEN STORIES SHALL HAVE A CLEAR WIDTH OF 48 INCHES (1219 MM) MINIMUM BETWEEN HANDRAILS AND SHALL EITHER INCORPORATE AN AREA OF REFUGE WITHIN AN ENLARGED FLOOR-LEVEL LANDING OR SHALL BE ACCESSED FROM AN AREA OF REFUGE COMPLYING WITH SECTION 1009.6. EXIT ACCESS STAIRWAYS THAT CONNECT LEVELS IN THE SAME STORY ARE NOT PERMITTED AS PART OF AN ACCESSIBLE MEANS OF EGRESS. [DSA-AC & HCD 1-AC] IN ADDITION, EXIT STAIRWAYS SHALL COMPLY WITH CHAPTER 11A, SECTIONS 1115A AND 1123A, OR CHAPTER 11B, SECTIONS 11B-210 AND 11B-504, AS APPLICABLE. EXCEPTIONS:

1. EXIT ACCESS STAIRWAYS PROVIDING MEANS OF EGRESS FROM MEZZANINES ARE PERMITTED AS PART OF AN ACCESSIBLE MEANS OF EGRESS.

2. THE CLEAR WIDTH OF 48 INCHES (1219 MM) BETWEEN HANDRAILS IS NOT REQUIRED IN BUILDINGS EQUIPPED THROUGHOUT WITH AN AUTOMATIC SPRINKLER SYSTEM INSTALLED IN ACCORDANCE WITH SECTION 903.3.1.1 OR 903.3.1.2.

3. THE CLEAR WIDTH OF 48 INCHES (1219 MM) BETWEEN HANDRAILS IS NOT REQUIRED FOR STAIRWAYS ACCESSED FROM A REFUGE AREA IN CONJUNCTION WITH A HORIZONTAL EXIT. 4. AREAS OF REFUGE ARE NOT REQUIRED AT EXIT ACCESS STAIR-WAYS WHERE TWO-WAY COMMUNICATION IS

PROVIDED AT THE ELEVATOR LANDING IN ACCORDANCE WITH SECTION 1009.8. 5. AREAS OF REFUGE ARE NOT REQUIRED AT STAIRWAYS IN BUILDINGS EQUIPPED THROUGHOUT WITH AN AUTOMATIC SPRINKLER SYSTEM INSTALLED IN ACCORDANCE WITH SECTION 903.3.1.1 OR 903.3.1.2. 6. AREAS OF REFUGE ARE NOT REQUIRED AT STAIRWAYS SERVING OPEN PARKING GARAGES. 7. AREAS OF REFUGE ARE NOT REQUIRED FOR SMOKE-PROTECTED ASSEMBLY SEATING AREAS COMPLYING

WITH SECTION 1029.6.2. 8. AREAS OF REFUGE ARE NOT REQUIRED AT STAIRWAYS IN GROUP R-2 OCCUPANCIES.

9. AREAS OF REFUGE ARE NOT REQUIRED FOR STAIRWAYS ACCESSED FROM A REFUGE AREA IN CONJUNCTION WITH A HORIZONTAL EXIT.

1009.4 ELEVATORS. IN ORDER TO BE CONSIDERED PART OF AN ACCESSIBLE MEANS OF EGRESS, AN ELEVATOR SHALL COMPLY WITH THE EMERGENCY OPERATION AND SIGNALING DEVICE REQUIREMENTS OF CALIFORNIA CODE OF REGULATIONS, TITLE 8, DIVISION 1, CHAPTER 4, SUBCHAPTER 6, ELEVATOR SAFETY ORDERS. STANDBY POWER SHALL BE PROVIDED IN ACCORDANCE WITH CHAPTER 27 AND SECTION 3003. THE ELEVATOR SHALL BE ACCESSED FROM AN AREA OF REFUGE COMPLYING WITH SECTION 1009.6. EXCEPTIONS:

1. AREAS OF REFUGE ARE NOT REQUIRED AT THE ELEVATOR IN OPEN PARKING GARAGES. 2. AREAS OF REFUGE ARE NOT REQUIRED IN BUILDINGS AND FACILITIES EQUIPPED THROUGHOUT WITH AN AUTOMATIC SPRINKLER SYSTEM INSTALLED IN ACCORDANCE WITH SECTION 903.3.1.1 OR 903.3.1.2 3. AREAS OF REFUGE ARE NOT REQUIRED AT ELEVATORS NOT REQUIRED TO BE LOCATED IN A SHAFT IN ACCORDANCE WITH SECTION 712.

4. AREAS OF REFUGE ARE NOT REQUIRED AT ELEVATORS SERVING SMOKE-PROTECTED ASSEMBLY SEATING AREAS COMPLYING WITH SECTION 1029.6.2. 5. AREAS OF REFUGE ARE NOT REQUIRED FOR ELEVATORS ACCESSED FROM A REFUGE AREA IN

CONJUNCTION WITH A HORIZONTAL EXIT.

G0.54



PROJECT NAME

iVista@Alderwood

18799 ALDERWOOD MALL PARKWAY LYNNWOOD, WA 98037

OWNER NAME

ALDERWOOD **INVESTMENTS LLC**

18799 ALDERWOOD MALL PARKWAY

REGISTER

RADIM BLAZEJ

STATE OF WASHINGTON

DATE ISSUES & REVISIONS

1 03/31/23 PDR SUBMITTAL

PROJECT NUMBER


AS SHOWN

DESCRIPTION **EXITING PLAN - LEVEL 3**

SHEET NUMBER



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OCCUPANCY SCHEDULE - LEVEL 2					
NUMBER	NAME	OCCUPANCY	AREA	OCCUPANT FACTOR	OCCUPANT LOA
LEVEL 2					
201	PARKING GARAGE L2	S-2	29,909 SF	200	150
202	FITNESS ROOM	A-2	3,305 SF	15	221
203	FITNESS ROOM	A-2	708 SF	15	48
299	BIKE PARKING	S-2	360 SF	300	2
361	ELEC. ROOM	S-2	1,053 SF	200	6
364	STORAGE	S-2	258 SF	300	1
530	STORAGE	S-2	274 SF		
TOTAL				1	428

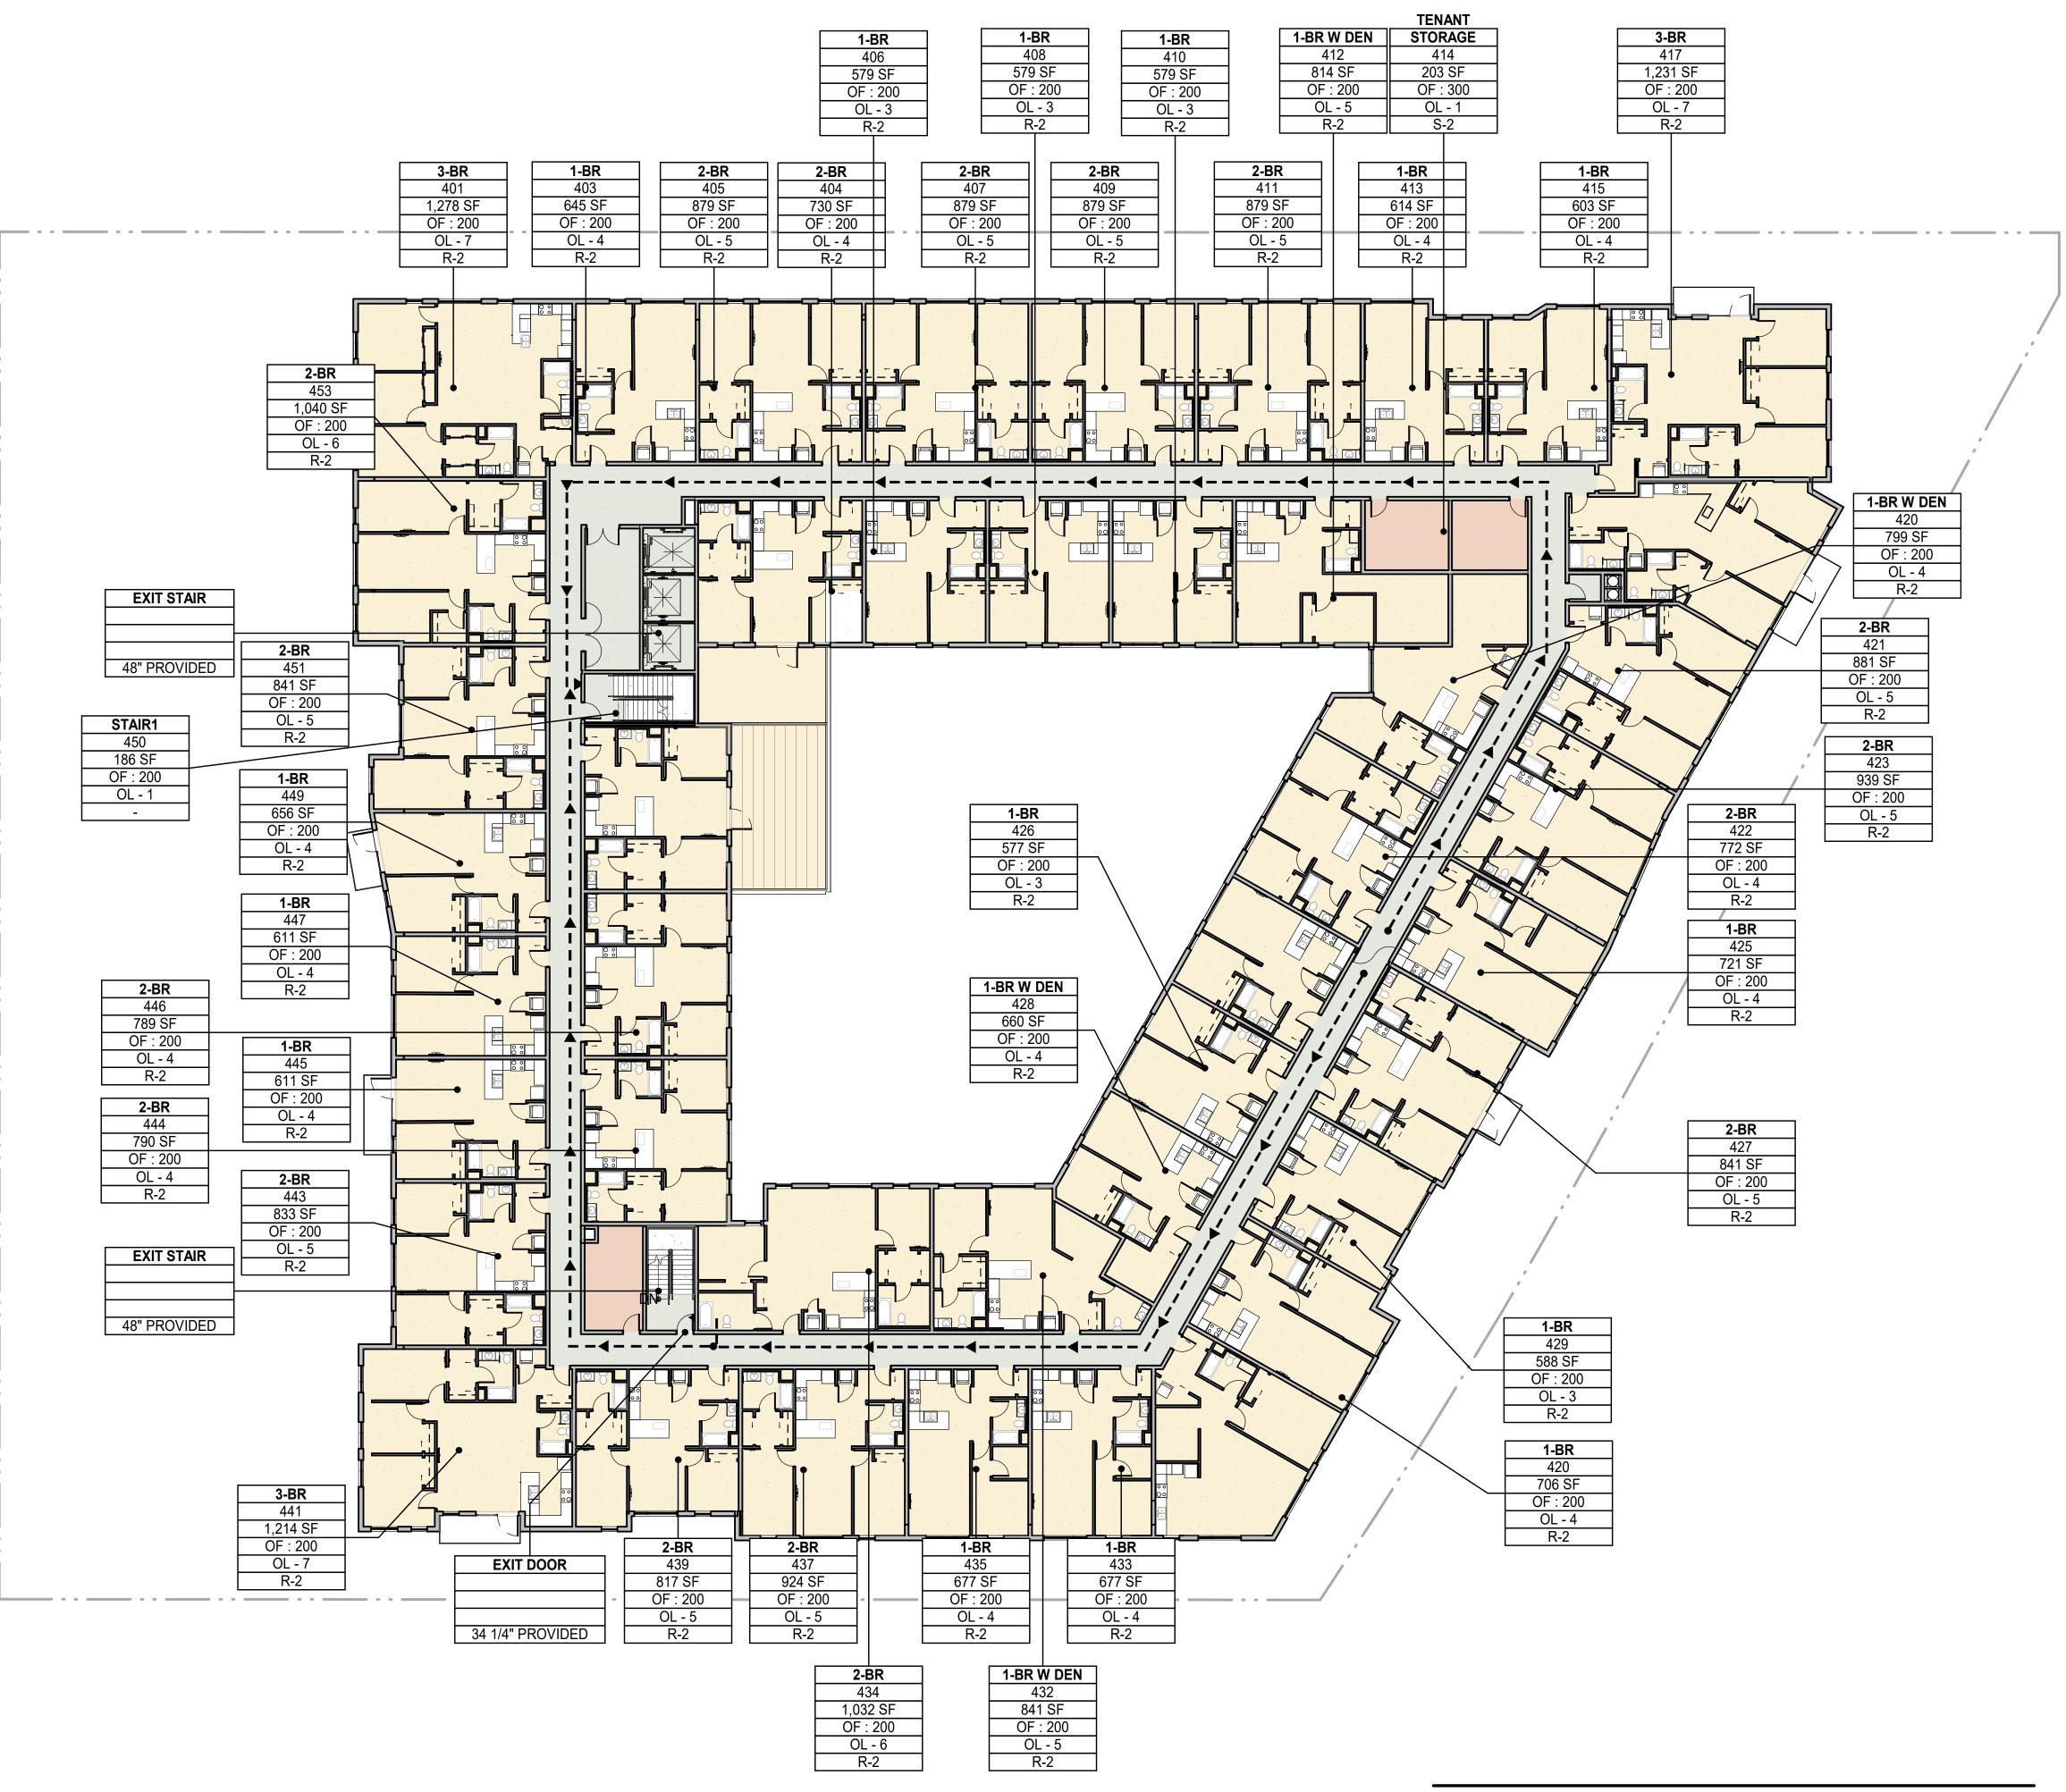SECTION 1009

ACCESSIBLE MEANS OF EGRESS

1009.1 ACCESSIBLE MEANS OF EGRESS REQUIRED. ACCESSIBLE MEANS OF EGRESS SHALL COMPLY WITH THIS SECTION. ACCESSIBLE SPACES SHALL BE PROVIDED WITH NOT LESS THAN ONE ACCESSIBLE MEANS OF EGRESS. WHERE MORE THAN ONE MEANS OF EGRESS ARE REQUIRED BY SECTION 1006.2 OR 1006.3 FROM ANY ACCESSIBLE SPACE, EACH ACCESSIBLE PORTION OF THE SPACE SHALL BE SERVED BY ACCESSIBLE MEANS OF EGRESS IN AT LEAST THE SAME NUMBER AS REQUIRED BY SECTIONS 1006.2 OR 1006.3. IN ADDITION TO THE REQUIREMENTS OF THIS CHAPTER, MEANS OF EGRESS, WHICH PROVIDE ACCESS TO, OR EGRESS FROM, BUILDINGS FOR PERSONS WITH DISABILI-TIES, SHALL ALSO COMPLY WITH THE REQUIREMENTS OF CHAPTER 11A OR 11B AS APPLICABLE.

EXCEPTIONS:

1. ACCESSIBLE MEANS OF EGRESS ARE NOT REQUIRED TO BE PROVIDED IN EXISTING BUILDINGS. 2. ONE ACCESSIBLE MEANS OF EGRESS IS REQUIRED FROM AN ACCESSIBLE MEZZANINE LEVEL IN ACCORDANCE WITH SECTION 1009.3, 1009.4 OR 1009.5, AND CHAPTER 11A OR 11B, AS APPLICABLE. 3. IN ASSEMBLY AREAS WITH RAMPED AISLES OR STEPPED AISLES, ONE ACCESSIBLE MEANS OF EGRESS IS PERMITTED WHERE THE COMMON PATH OF EGRESS TRAVEL IS ACCESSI-BLE AND MEETS THE REQUIREMENTS IN SECTION 1029.8, AND CHAPTER 11A OR 11B, AS APPLICABLE.

1009.2 CONTINUITY AND COMPONENTS. EACH REQUIRED ACCESSIBLE MEANS OF EGRESS SHALL BE CONTINUOUS TO A PUBLIC WAY AND SHALL CONSIST OF ONE OR MORE OF THE FOLLOWING COMPONENTS: 1. ACCESSIBLE ROUTES COMPLYING WITH CHAPTER 11A, SECTIONS 1110A.1 AND 1120A, OR CHAPTER 11B, SECTIONS 11B-206 AND 11B-402, AS APPLICABLE

2. INTERIOR EXIT STAIRWAYS COMPLYING WITH SECTIONS 1009.3 AND 1023, AND CHAPTER 11A, SECTION 1123A, OR CHAPTER 11B, SECTIONS 11B-210 AND 11B-504, APPLICABLE. 3. EXIT ACCESS STAIRWAYS COMPLYING WITH SECTIONS 1009.3 AND 1019.3 OR 1019.4, CHAPTER 11A, SECTION

1123A. OR CHAPTER 11B. SECTIONS 11B-210 AND 11B-504. AS APPLICABLE. 4. EXTERIOR EXIT STAIRWAYS COMPLYING WITH SECTIONS 1009.3 AND 1027 AND CHAPTER 11A, SECTION 1115A, OR CHAPTER 11B, SECTIONS 11B-210 AND 11B-504, AS APPLICABLE AND SERVING LEVELS OTHER THAN THE LEVEL OF EXIT DISCHARGE.

5. ELEVATORS COMPLYING WITH SECTION 1009.4, AND CHAPTER 11A, SECTION 1124A, OR CHAPTER 11B, SECTIONS 11B-206.6 AND 11B-407, AS APPLICABLE.

6. PLATFORM LIFTS COMPLYING WITH SECTION 1009.5 AND CHAPTER 11A, SECTION 1124A, OR CHAPTER 11B, SECTIONS 11B-206.7, 11B-207.2 AND 11B-410 AS APPLICABLE. 7. HORIZONTAL EXITS COMPLYING WITH SECTION 1026.

8. RAMPS COMPLYING WITH SECTION 1012, AND CHAPTER 11A, SECTIONS 1114A AND 1122A, OR CHAPTER 11B, 11B-405, AS APPLICABLE.

9. AREAS OF REFUGE COMPLYING WITH SECTION 1009.6. 10. EXTERIOR AREAS FOR ASSISTED RESCUE COMPLYING WITH SECTION 1009.7 SERVING EXITS AT THE LEVEL OF EXIT DISCHARGE.

1009.2.1 ELEVATORS REQUIRED. IN BUILDINGS WHERE A REQUIRED ACCESSIBLE FLOOR IS FOUR OR MORE STORIES ABOVE OR BELOW A LEVEL OF EXIT DISCHARGE, NOT LESS THAN ONE REQUIRED ACCESSIBLE MEANS OF EGRESS SHALL BE AN ELEVATOR COMPLYING WITH SECTION 1009.4.

EXCEPTIONS:

1. IN BUILDINGS EQUIPPED THROUGHOUT WITH AN AUTOMATIC SPRINKLER SYSTEM INSTALLED IN ACCORDANCE WITH SECTION 903.3.1.1 OR 903.3.1.2, THE ELEVATOR SHALL NOT BE REQUIRED ON FLOORS PROVIDED WITH A HORIZONTAL EXIT AND LOCATED AT OR ABOVE THE LEVELS OF EXIT DISCHARGE. 2. IN BUILDINGS EQUIPPED THROUGHOUT WITH AN AUTOMATIC SPRINKLER SYSTEM INSTALLED IN ACCORDANCE WITH SECTION 903.3.1.1 OR 903.3.1.2, THE ELEVATOR SHALL NOT BE REQUIRED ON FLOORS PROVIDED WITH A RAMP CONFORMING TO THE PROVISIONS OF SECTION 1012.

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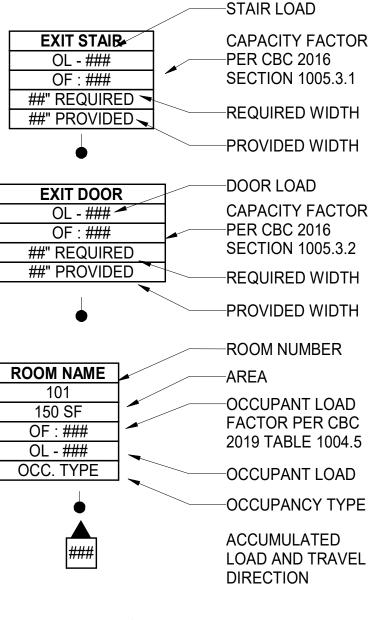
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CONJUNCTION WITH A HORIZONTAL EXIT.

LEGEND



●---->

EGRESS PATH OF TRAVEL



PROJECT NAME

iVista@Alderwood

18799 ALDERWOOD MALL PARKWAY LYNNWOOD, WA 98037

OWNER NAME

ALDERWOOD **INVESTMENTS LLC**

18799 ALDERWOOD MALL PARKWAY

STATE OF WASHINGTO DATE ISSUES & REVISIONS 1 03/31/23 PDR SUBMITTAL AS SHOWN SCALE PROJECT NUMBER 23.301 DESCRIPTION **EXITING PLAN - LEVEL 4-8** SHEET NUMBER G0.55

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				2,816 SF TOTAL AREA 800 SF U.P.OPENING 28% OPEN< 45% ALLOWED 12'-6" TO PROPERTY LINE
				2,816 SF TOTAL AREA 800 SF U.P.OPENING 28% OPEN< 45% ALLOWED 12'-6" TO PROPERTY LINE
				2,846 SF TOTAL AREA 800 SF U.P.OPENING 28% OPEN< 45% ALLOWED 12'-6" TO PROPERTY LINE
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				2,846 SF TOTAL AREA 800 SF U.P.OPENING 28% OPEN< 45% ALLOWED 12'-6" TO PROPERTY LINE
				3,030 SF TOTAL AREA 723 SF U.P.OPENING 24% OPEN< 45% ALLOWED 12'-6" TO PROPERTY LINE
				3,092 SF TOTAL AREA 856 SF U.P.OPENING 28% OPEN< 45% ALLOWED 10'-6" TO PROPERTY LINE
				2,550 SF TOTAL AREA 713 SF U.P.OPENING 29% OPEN< 45% ALLOWED 10'-6" TO PROPERTY LINE













69'-0" TO PROPERTY LINE


UNLIMITED OPENINGS ALLOWED ON WEST ELEVATION


AAXASA AAXAS BOLANCHARD ST, SUITE 200 SEATTLE, WA 98121 T 206.367.1382 F 206.367.1385 www.axisgfa.com
PROJECT NAME
iVista@Alderwood
18799 ALDERWOOD MALL PARKWAY LYNNWOOD, WA 98037
OWNER NAME
ALDERWOOD INVESTMENTS LLC
18799 ALDERWOOD MALL PARKWAY
REGISTERED ARCHITECT RADIM BLAZEJ STATE OF WASHINGTON
DATE ISSUES & REVISIONS
1 03/31/23 PDR SUBMITTAL
2
SCALE AS SHOWN
PROJECT NUMBER 23.301
DESCRIPTION OPENING CALCULATION
SHEET NUMBER G0.61
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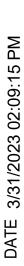


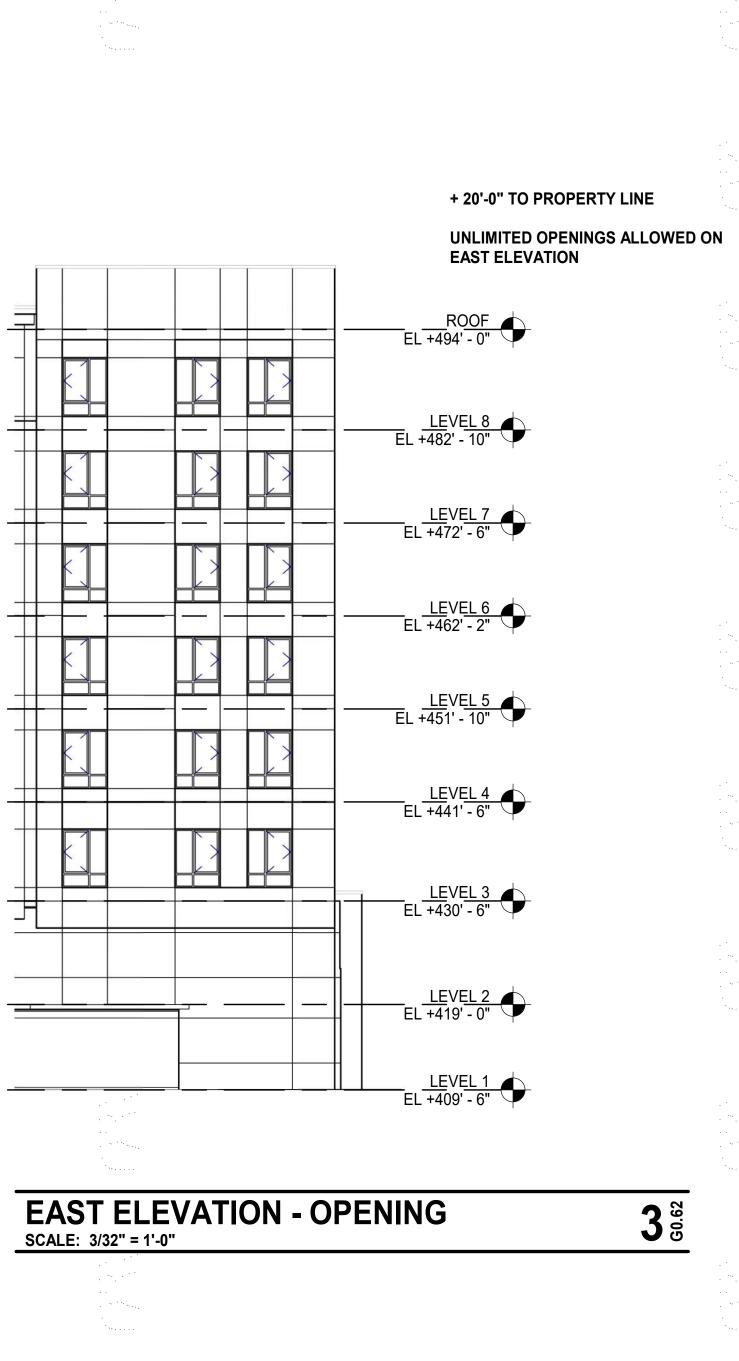

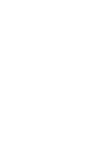



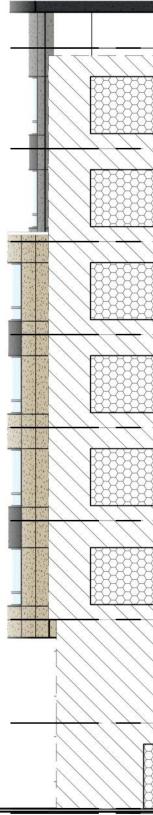

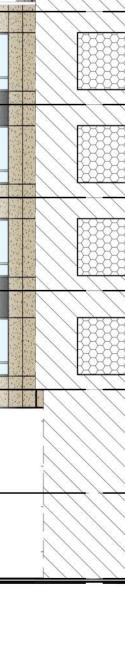

	1,878 SF TOTAL AREA 570 SF U.P.OPENING 30% OPEN< 45% ALLOWED 11'-0" TO PROPERTY LINE AT CLOSES DIM. 1,878 SF TOTAL AREA 570 SF U.P.OPENING 30% OPEN< 45% ALLOWED 11'-0" TO PROPERTY LINE AT CLOSES DIM. 1,878 SF TOTAL AREA 570 SF U.P.OPENING 30% OPEN< 45% ALLOWED 11'-0" TO PROPERTY LINE AT CLOSES DIM.
	570 SF U.P.OPENING 30% OPEN< 45% ALLOWED 11'-0" TO PROPERTY LINE AT CLOSES DIM. EL +451'-10" 1,878 SF TOTAL AREA 570 SF U.P.OPENING 30% OPEN< 45% ALLOWED 11'-0" TO PROPERTY LINE AT CLOSES DIM. 11'-0" TO PROPERTY LINE AT CLOSES DIM. EL +441'-6" 570 SF U.P.OPENING 30% OPEN< 45% ALLOWED 11'-0" TO PROPERTY LINE AT CLOSES DIM. EL +441'-6"
SOUTH ELEVATION - OPENING	480 SF U.P.OPENING 26% OPEN< 75% ALLOWED 15'-6" TO PROPERTY LINE 1,517 SF TOTAL AREA 645 SE U D OPENING
SCALE: 3/32" = 1'-0"	
	2,420 SF TOTAL AREA 757 SF U.P.OPENING 31% OPEN< 45% ALLOWED 11'-10" TO PROPERTY LINE AT THE CLOSEST LOCATION 2,420 SF TOTAL AREA 2,420 SF TOTAL AREA 757 SF U.P.OPENING 31% OPEN< 45% ALLOWED 11'-10" TO PROPERTY LINE AT THE CLOSEST LOCATION 2,420 SF TOTAL AREA 757 SF U.P.OPENING 31% OPEN< 45% ALLOWED 11'-10" TO PROPERTY LINE AT THE CLOSEST LOCATION 11'-10" TO PROPERTY LINE AT THE 11'-10" TO PROPERTY LINE
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				1,878 SF TOTAL AREA EL +494' - 0" 570 SF U.P.OPENING 30% OPEN< 45% ALLOWED 11'-0" TO PROPERTY LINE AT CLOSES DIM. 1,878 SF TOTAL AREA EL +482' - 10"
				570 SF U.P.OPENING 30% OPEN< 45% ALLOWED 11'-0" TO PROPERTY LINE AT CLOSES DIM.
				1,878 SF TOTAL AREA 570 SF U.P.OPENING 30% OPEN< 45% ALLOWED 11'-0" TO PROPERTY LINE AT CLOSES DIM.
				570 SF U.P.OPENING 30% OPEN< 45% ALLOWED 11'-0" TO PROPERTY LINE AT CLOSES DIM.
				1,878 SF TOTAL AREA 570 SF U.P.OPENING 30% OPEN< 45% ALLOWED 11'-0" TO PROPERTY LINE AT CLOSES DIM. 1,878 SF TOTAL AREA EL +441' - 6"
				570 SF U.P.OPENING 30% OPEN< 45% ALLOWED 11'-0" TO PROPERTY LINE AT CLOSES DIM.
				480 SF U.P.OPENING 26% OPEN< 75% ALLOWED 15'-6" TO PROPERTY LINE
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	SCALE: 3/32" = 7			
				2,420 SF TOTAL AREA 757 SF U.P.OPENING 31% OPEN< 45% ALLOWED 11'-10" TO PROPERTY LINE AT THE
				CLOSEST LOCATION 2,420 SF TOTAL AREA 757 SF U.P.OPENING 31% OPEN< 45% ALLOWED 11'-10" TO PROPERTY LINE AT THE
				CLOSEST LOCATION 2,420 SF TOTAL AREA 757 SF U.P.OPENING 31% OPEN< 45% ALLOWED 11'-10" TO PROPERTY LINE AT THE CLOSEST LOCATION LEVEL 6
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				2,420 SF TOTAL AREA 757 SF U.P.OPENING 31% OPEN< 45% ALLOWED 11'-10" TO PROPERTY LINE AT THE
				2,420 SF TOTAL AREA 757 SF U.P.OPENING 31% OPEN< 45% ALLOWED 11'-10" TO PROPERTY LINE AT THE
				EL +430' - 6" 2,473 SF TOTAL AREA 267 SF U.P.OPENING 11% OPEN< UNLIMITED ALLOWED
				20'-0" TO PROPERTY LINE LEVEL 2 2,043 SF TOTAL AREA EL +419' - 0" 713 SF U.P.OPENING

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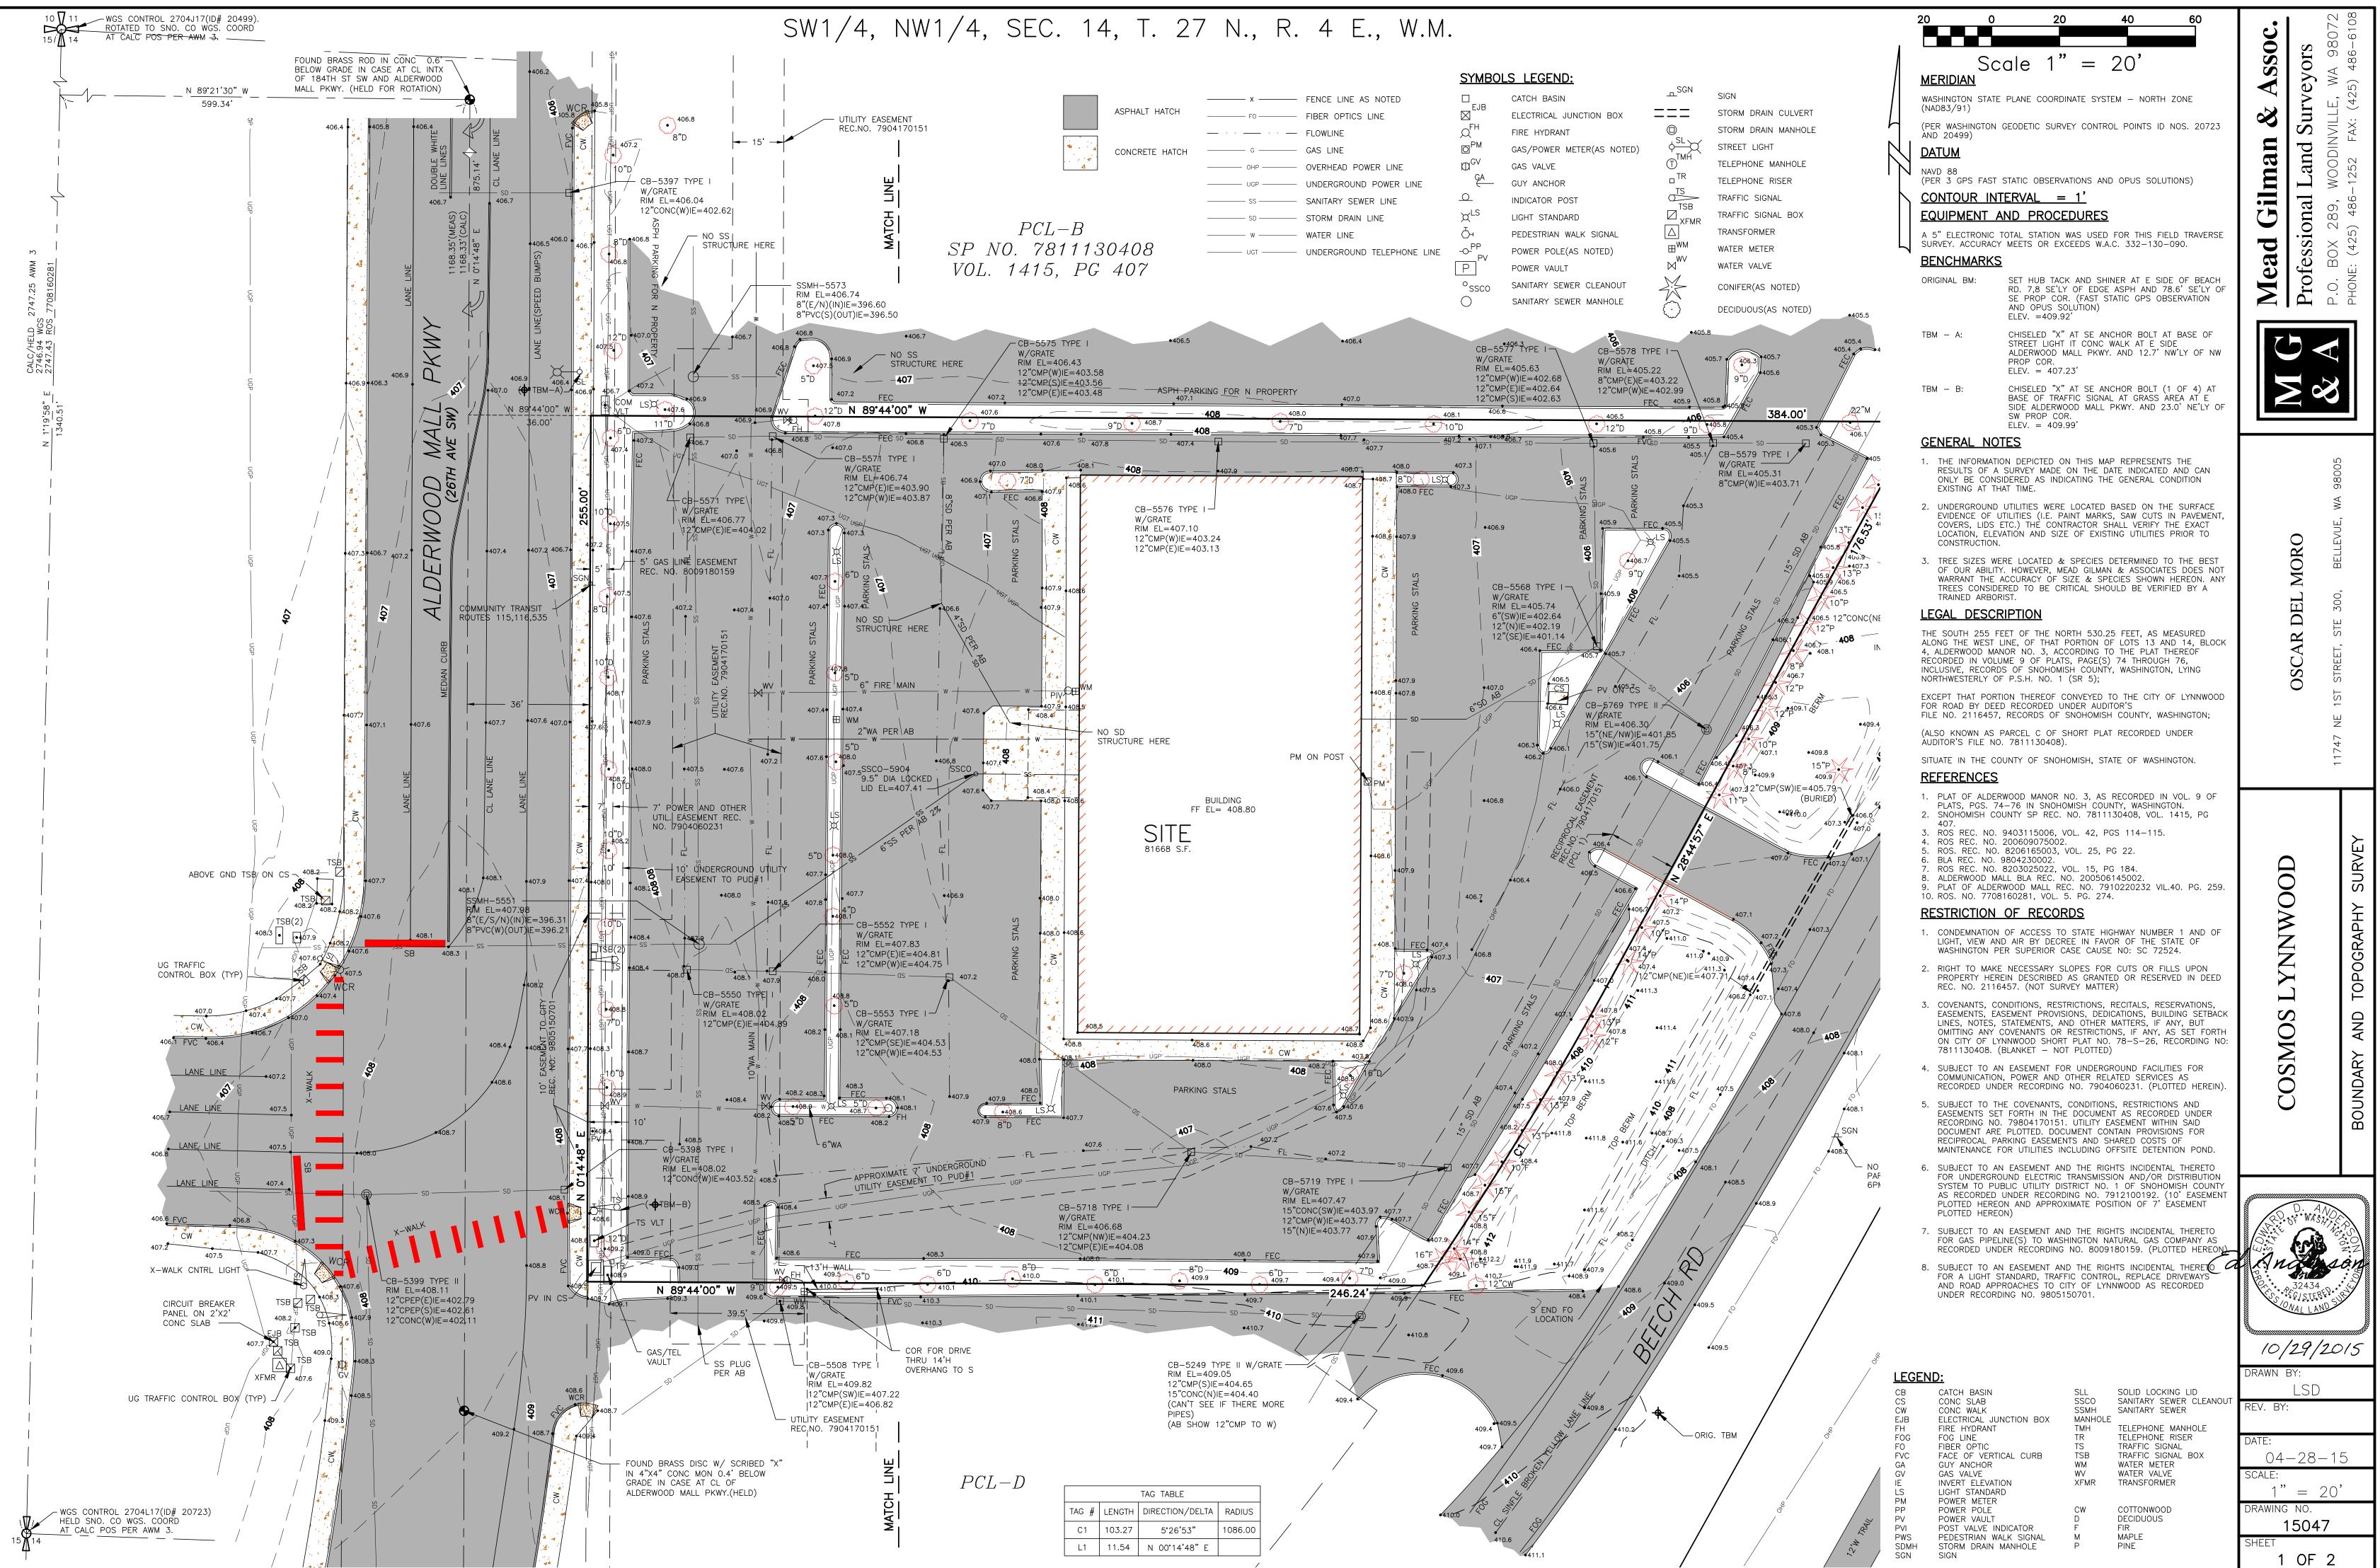



2,043 SF IUTAL AREA 713 SF U.P.OPENING 35% OPEN< UNLIMITED ALLOWED 20'-0" TO PROPERTY LINE EL +409' - 0"

SOUTHEAST ELEVATION- OPENING SCALE: 3/32" = 1'-0"

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AXIS
GF/-
801 BLANCHARD ST, SUITE 200 SEATTLE, WA 98121 T 206.367.1382 F 206.367.1385 www.axisgfa.com
PROJECT NAME
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18799 ALDERWOOD MALL PARKWAY LYNNWOOD, WA 98037
OWNER NAME
ALDERWOOD INVESTMENTS LLC
18799 ALDERWOOD MALL PARKWAY
a sector de la constante de la Constante de la constante de la Constante de la constante de la
REGISTERED ARCHITECT RADIM BLAZEJ STATE OF WASHINGTON
DATE ISSUES & REVISIONS
2
SCALE AS SHOWN
PROJECT NUMBER 23.301
DESCRIPTION OPENING CALCULATION
SHEET NUMBER G0.62
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04.0 04.0 04.0 EL 270414002C RSHIP SNO. CC	MERIDIAN WASHINGTON ST (NAD83/91) (PER WASHINGTO 20723 AND 204 DATUM NAVD 88 (PER 3 GPS FA CONTOUR EQUIPMENT A 5" ELECTRON	AST STATIC OBSERVATIONS AND OPUS SOLUTIONS) INTERVAL = 1' MIC TOTAL STATION WAS USED FOR THIS FIELD VEY. ACCURACY MEETS OR EXCEEDS W.A.C.	Mead G Professiona	PHONE: (425) 486-1252 FAX: (425) 486-610
R WSDOT	RESULTS OF ONLY BE CO EXISTING AT 2. UNDERGROU SURFACE EN IN PAVEMEN VERIFY THE UTILITIES PF 3. TREE SIZES BEST OF OU DOES NOT N SHOWN HER	NOTES MATION DEPICTED ON THIS MAP REPRESENTS THE f a survey made on the date indicated and can onsidered as indicating the general condition that time. UND UTILITIES WERE LOCATED BASED ON THE VIDENCE OF UTILITIES (i.E. PAINT MARKS, SAW CUTS if, covers, LIDS ETC.) THE CONTRACTOR SHALL EXACT LOCATION, ELEVATION AND SIZE OF EXISTING and to construction. WERE LOCATED & SPECIES DETERMINED TO THE WARBAILTY. HOWEVER, MEAD GILMAN & ASSOCIATES WARRANT THE ACCURACY OF SIZE & SPECIES ECON. ANY TREES CONSIDERED TO BE CRITICAL WERIFIED BY A TRAINED ARBORIST.	OSCAR DEL MORO	11/4/ NE 151 SIKEEI, SIE 300, BELLEVUE, WA 98005
VD: CATCH BASIN CONC SLAB CONC SLAB CONC WALK ELECTRICAL JUNCTION BOX FIRE HYDRANT FOG LINE FIBER OPTIC FACE OF VERTICAL CURB		A LEGEND: CATCH BASIN ELECTRICAL JUNCTION BOX TIRE HYDRANT GAS/POWER METER(AS NOTED) GAS VALVE GUY ANCHOR NDICATOR POST JGHT STANDARD PEDESTRIAN WALK SIGNAL POWER POLE(AS NOTED) POWER VAULT GANITARY SEWER CLEANOUT GANITARY SEWER MANHOLE GIGN STORM DRAIN CULVERT	COSMOS LYNNWOOD	BOUNDARY AND TOPOGRAPHY SURVEY
GUY ANCHOR GAS VALVE INVERT ELEVATION LIGHT STANDARD POWER METER POWER POLE POWER VAULT POST VALVE INDICATOR PEDESTRIAN WALK SIGNAL STORM DRAIN MANHOLE SIGN SOLID LOCKING LID SANITARY SEWER CLEANOUT SANITARY SEWER MANHOLE TELEPHONE MANHOLE TELEPHONE RISER	© S ¢ ^{SL} S TMH T □ ^{TR} T ^{TS} T ^{TSB} T ^{XFMR} T	STORM DRAIN MANHOLE STREET LIGHT TELEPHONE MANHOLE TELEPHONE RISER TRAFFIC SIGNAL TRAFFIC SIGNAL BOX TRANSFORMER WATER METER	D. AND D. AND NASH HISS NASH HISS NASH HISS SCIENCE ONAL LAND	RECONNERS

WATER METER WATER VALVE TRANSFORMER COTTONWOOD DECIDUOUS FIR MAPLE

TRAFFIC SIGNAL

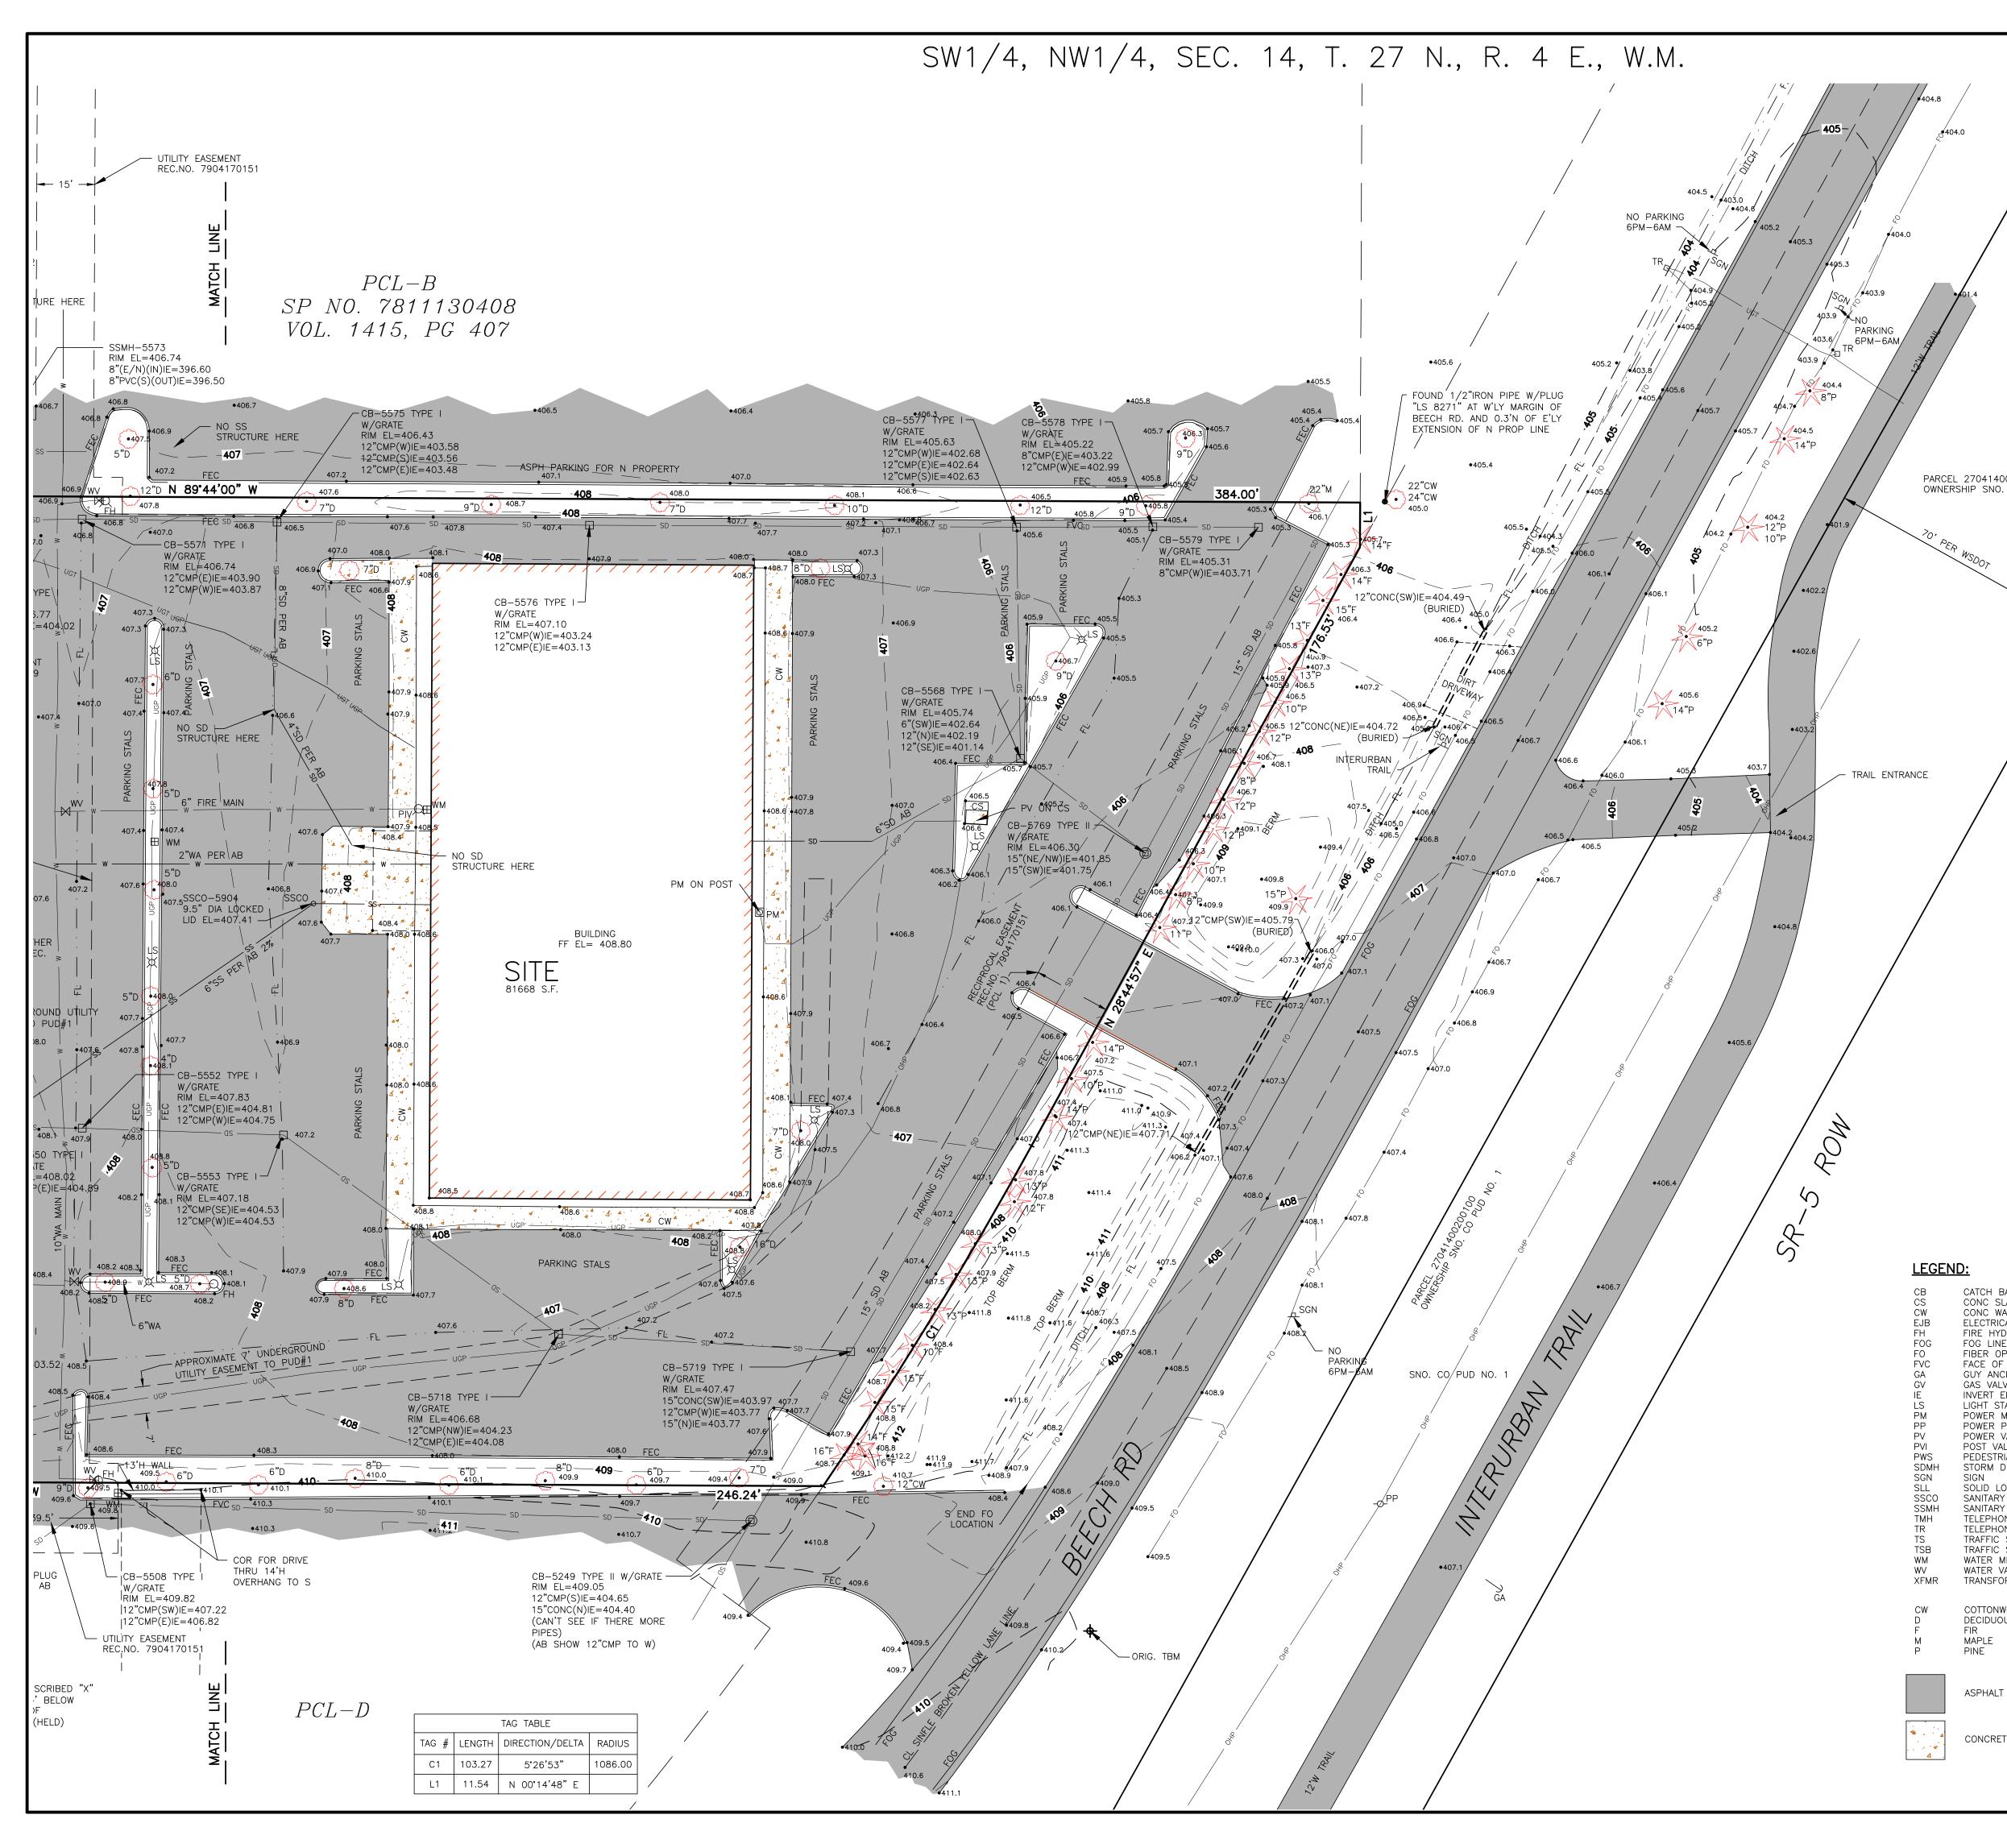TRAFFIC SIGNAL BOX

ASPHALT HATCH

PINE

CONCRETE HATCH

WATER VALVE CONIFER(AS NOTED) DECIDUOUS(AS NOTED) ------ X ------ FENCE LINE AS NOTED FO FIBER OPTICS LINE G GAS LINE OVERHEAD POWER LINE UNDERGROUND POWER LINE ------- SD ------ STORM DRAIN LINE ------ WATER LINE UNDERGROUND TELEPHONE LINE

10/29/2015

LSD

04-28-15

1" = 20'

15047

2 OF 2

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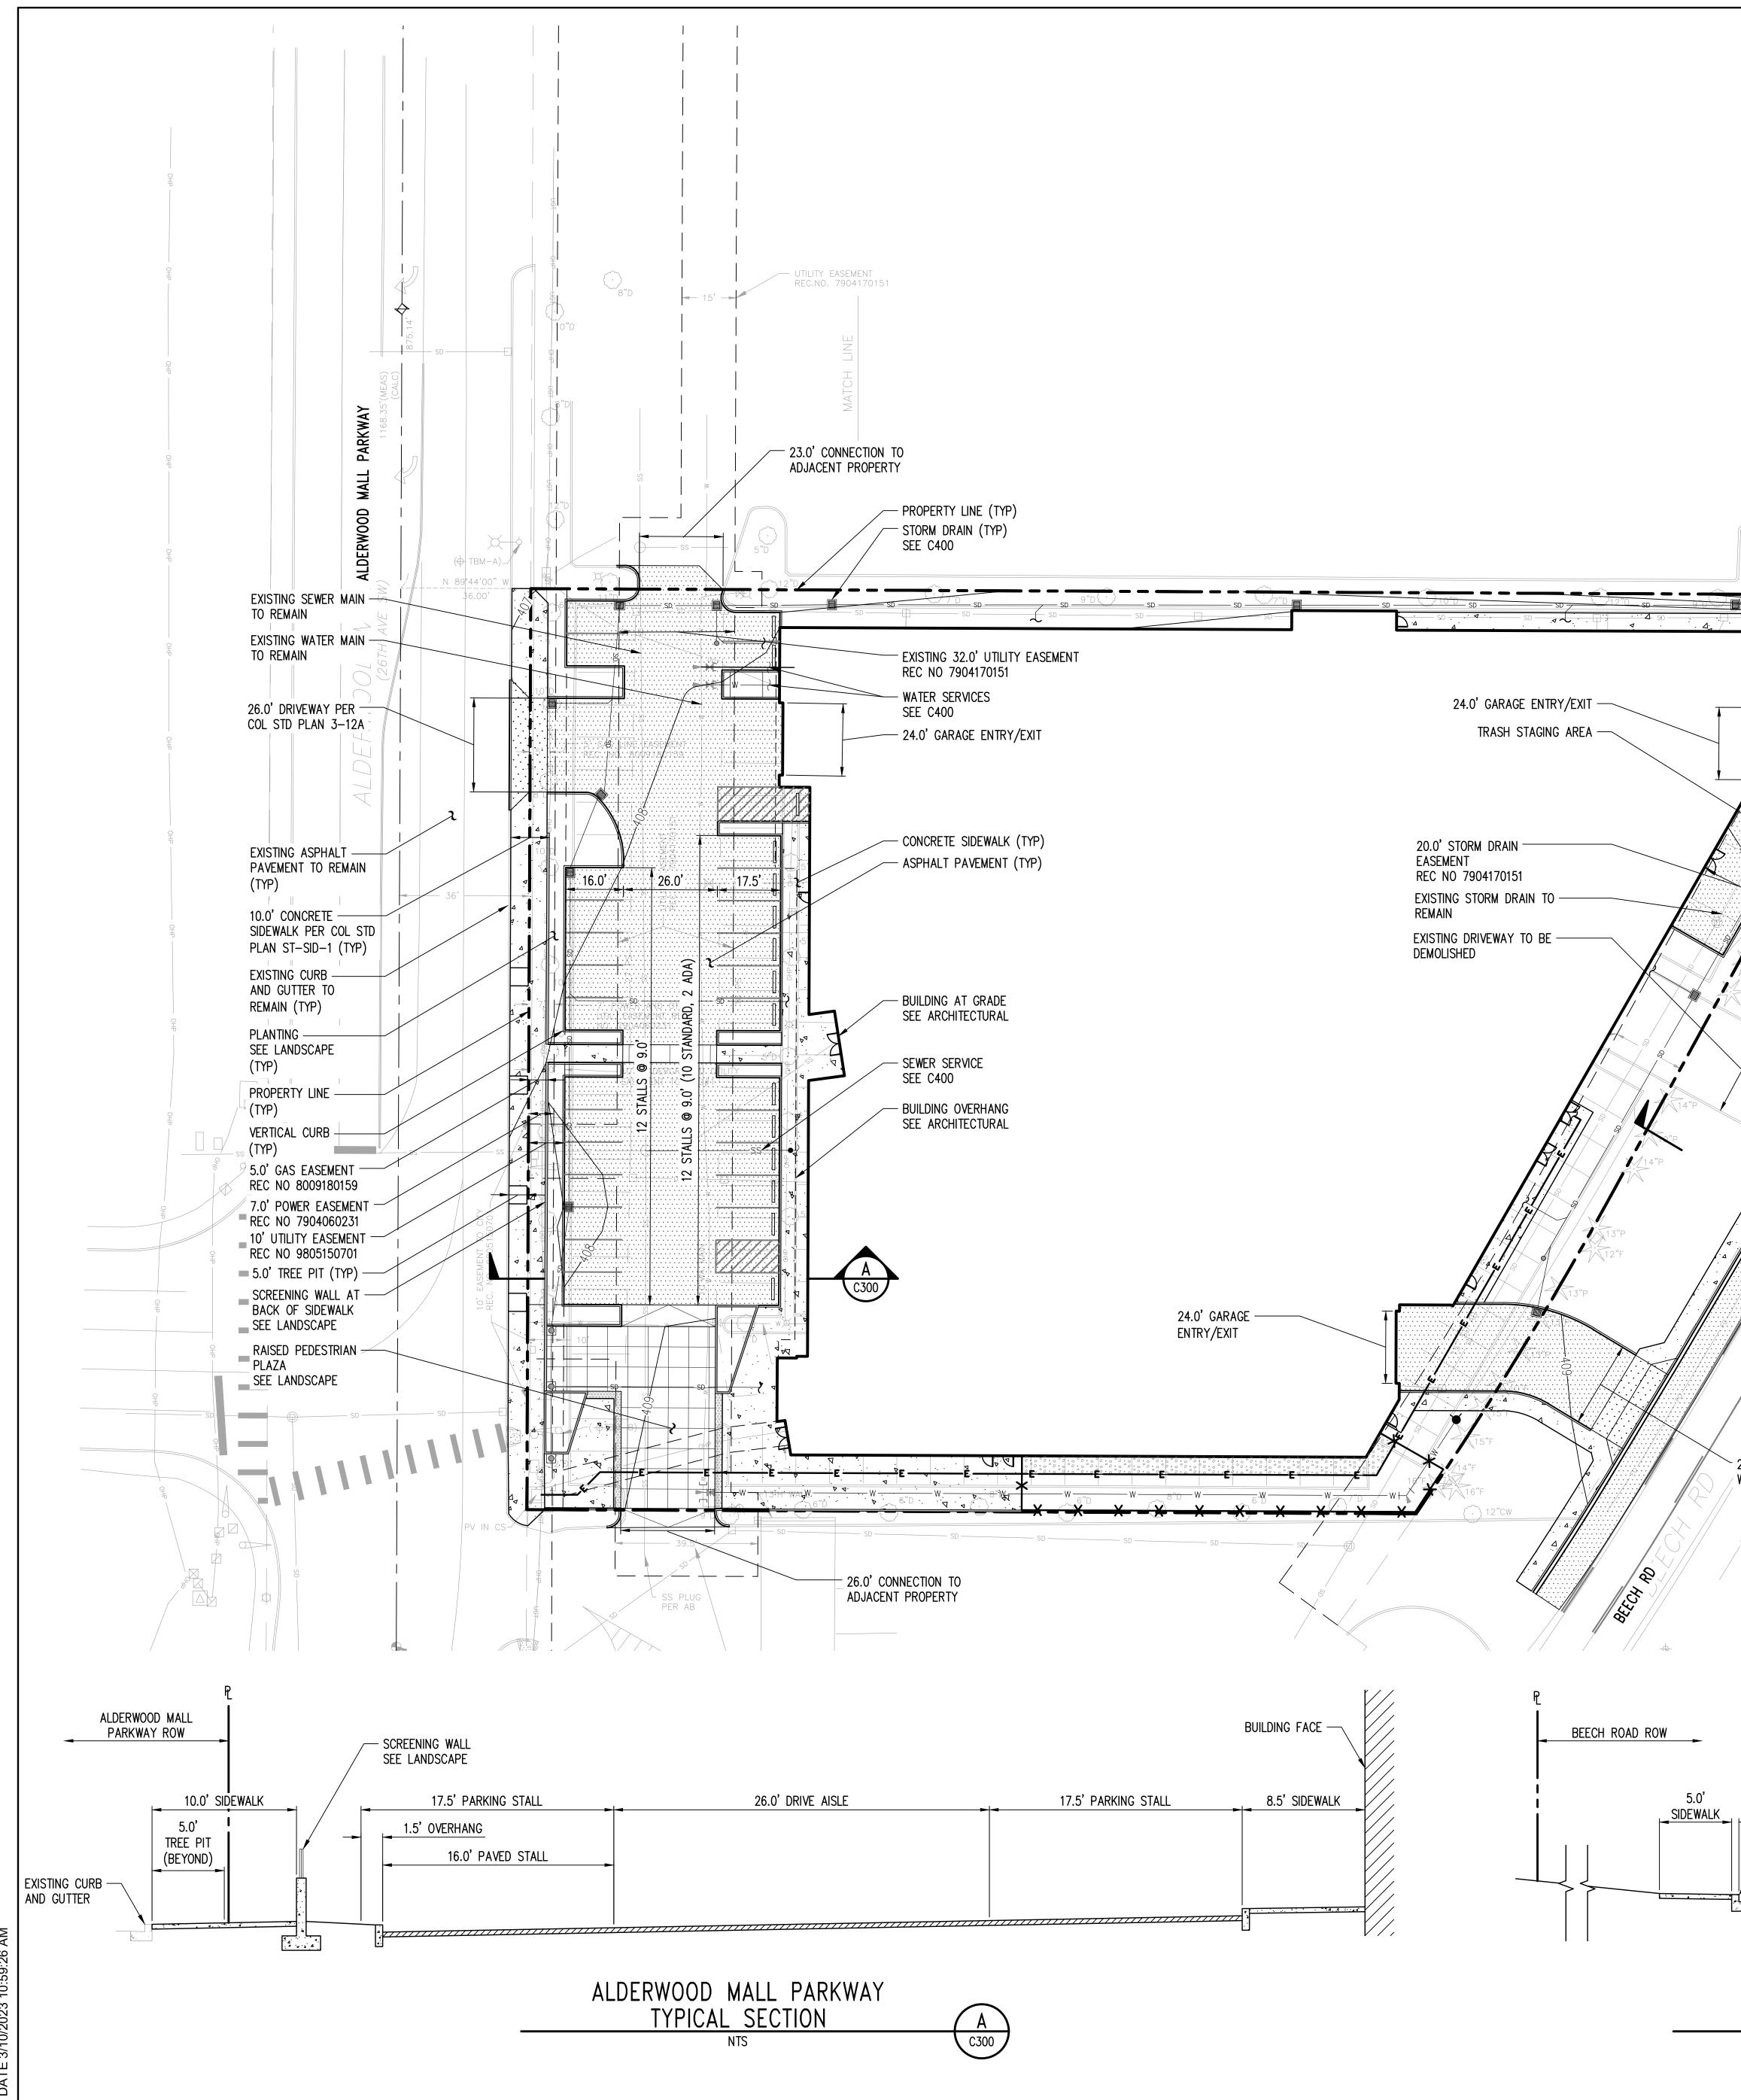
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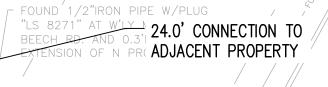
NOTES

- 1. REFER TO SHEET C400 FOR GRADING, STORM DRAIN, AND UTILITY DESI
- 2. REFER TO LANDSCAPE FOR PLANTING DESIGN.
- 3. ALL SURFACE IMPROVEMENTS WITHIN THE PROPOSED PROPERTY LINE ARE TO BE DEMOLISHED BY THE PROJECT.

LEGEND

NO PARŁ 6PM-6AI

		STREET CENTERLINE
		PROPOSED PROPERTY LINE
<u> </u>		EASEMENT LINE
		BUILDING WALL AT GRADE (SEE ARCHITECTURAL)
		BUILDING CANOPY (SEE ARCHITECTURAL)
		VERTICAL CURB
	— SD ———	STORM DRAIN (SEE C400)
W	— W ———	WATER SERVICE (SEE C400)
FS	—FS ———	FIRE SERVICE (SEE C400)
SS	—SS	SEWER SERVICE (SEE C400)
		CONCRETE SIDEWALK
		ASPHALT PAVEMENT
		CONCRETE PAVEMENT
,	$\begin{array}{cccc} \psi & \psi & \psi \\ \psi & \psi & \psi & \psi \\ \psi & \psi & \psi \end{array}$	PLANTING (SEE LANDSCAPE)



- PROPERTY LINE (TYP)

- 24.0' DRIVEWAY PER WSDOT STD F-80.10-04

- 5.0' CONCRETE SIDEWALK PER COL STD PLAN ST-SID-1 (TYP) - 9.5' SOUTHBOUND
- 11.0' SHARED LEFT TURN LANE

/ TRAVEL LANE

्ट EXISTING 9.5' NORTHBOUND TRAVEL LANE TO REMAIN


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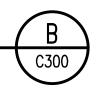
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~ 24.0' DRIVEWAY PER / WSDOT STD F-80.10-04

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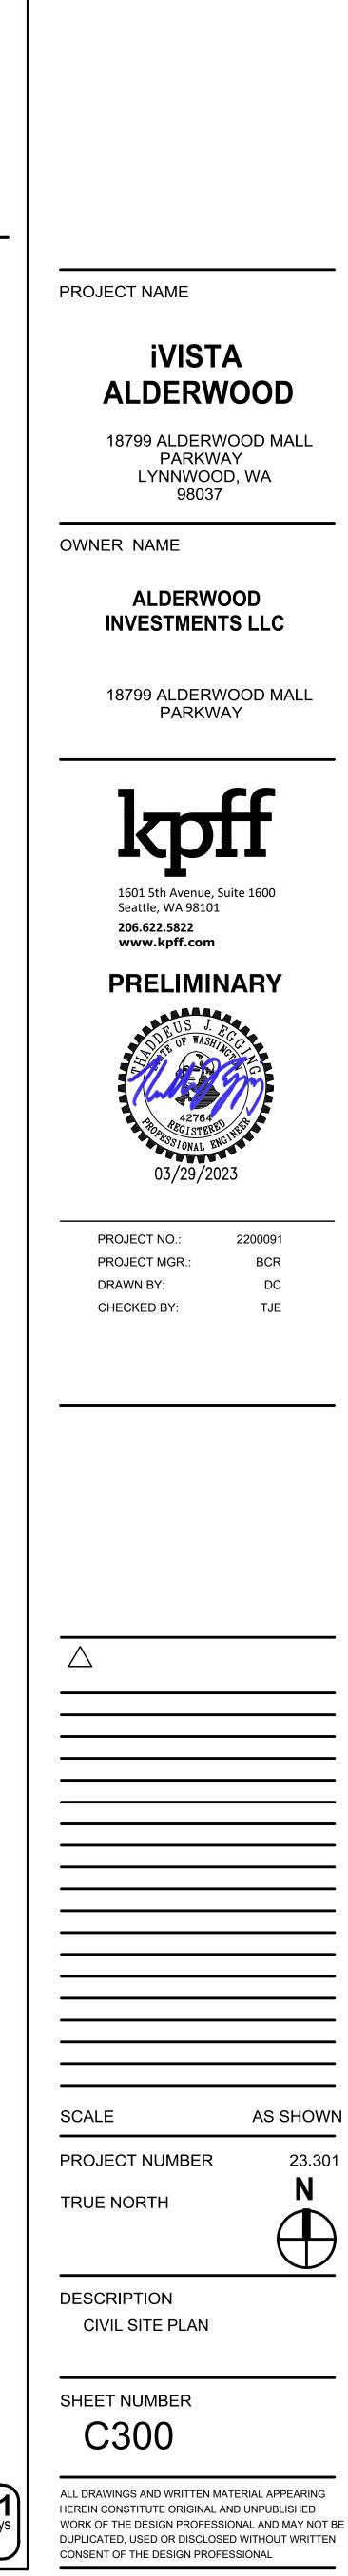



BEECH ROAD TYPICAL SECTION NTS



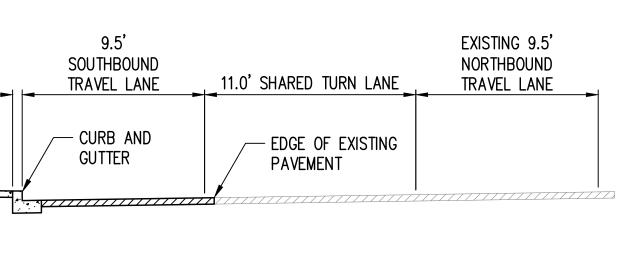



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2023 - 8:25pm bradyr \\kpff.com\Civi\2200001-2209999\2200091 Alderwood Tower\Design\CADD\Design\01 Schematic\ATWR-SD-C400-GRAD-STRM-UTIL.dwg



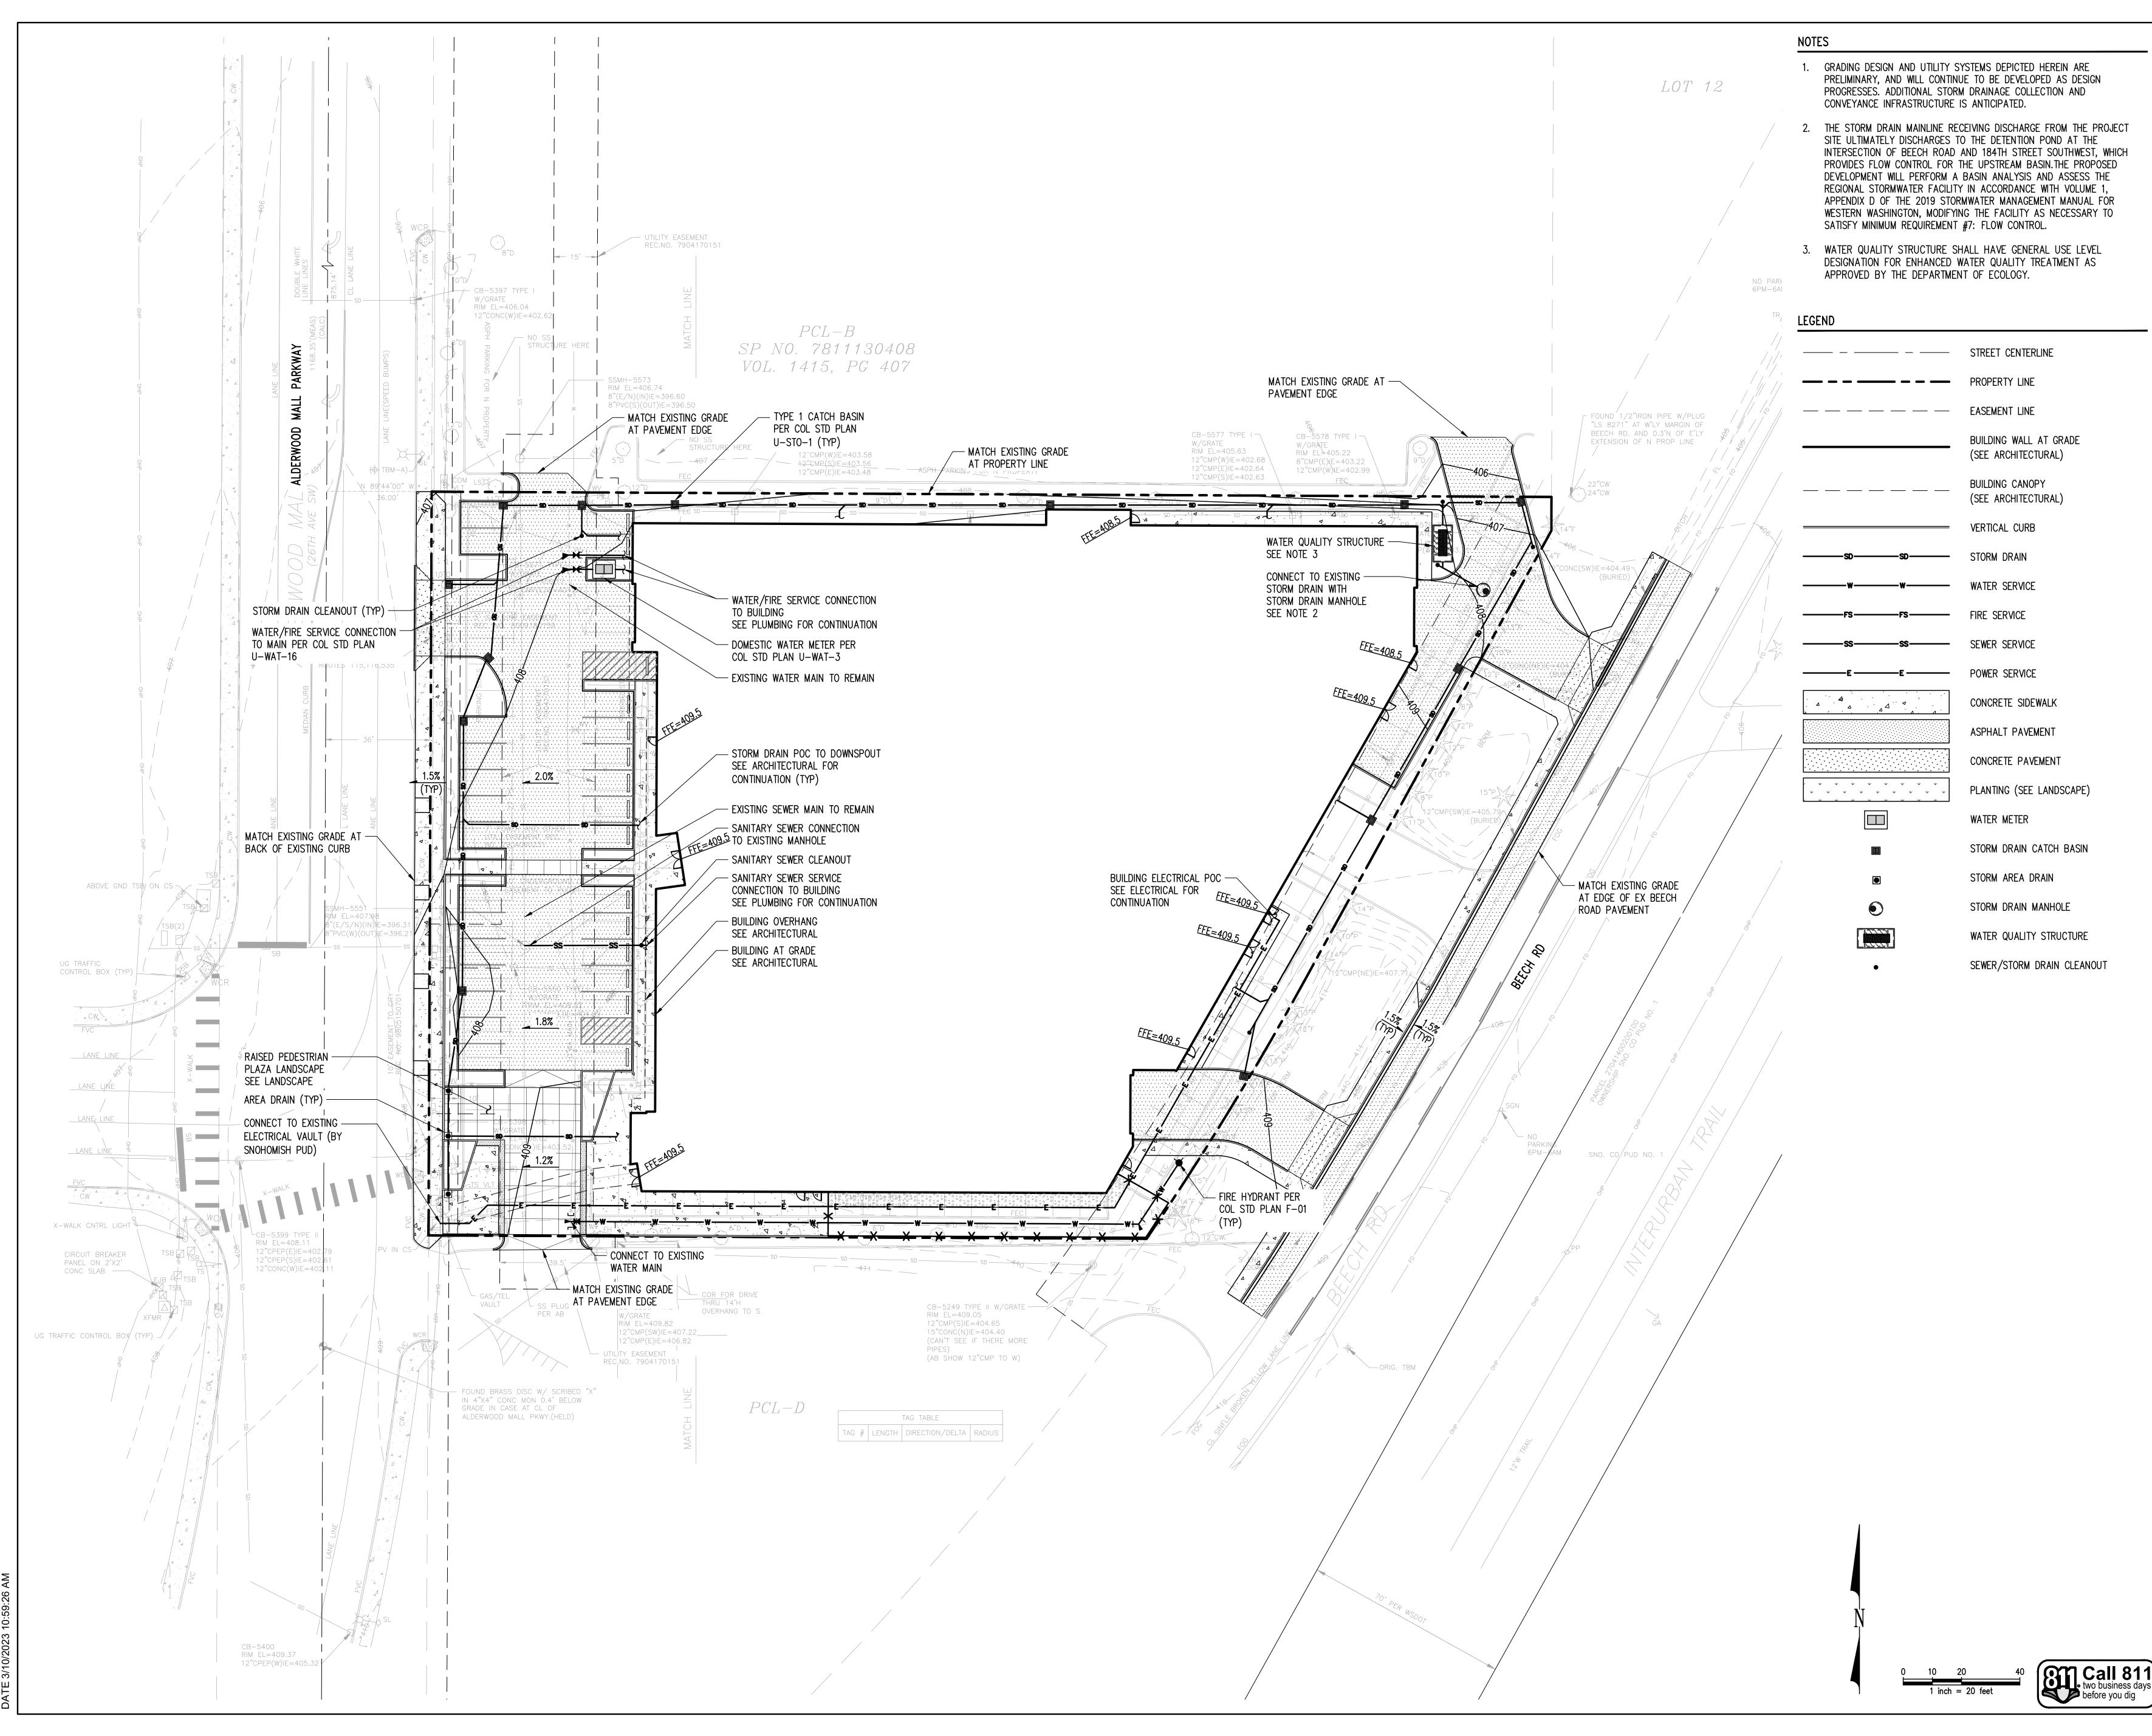

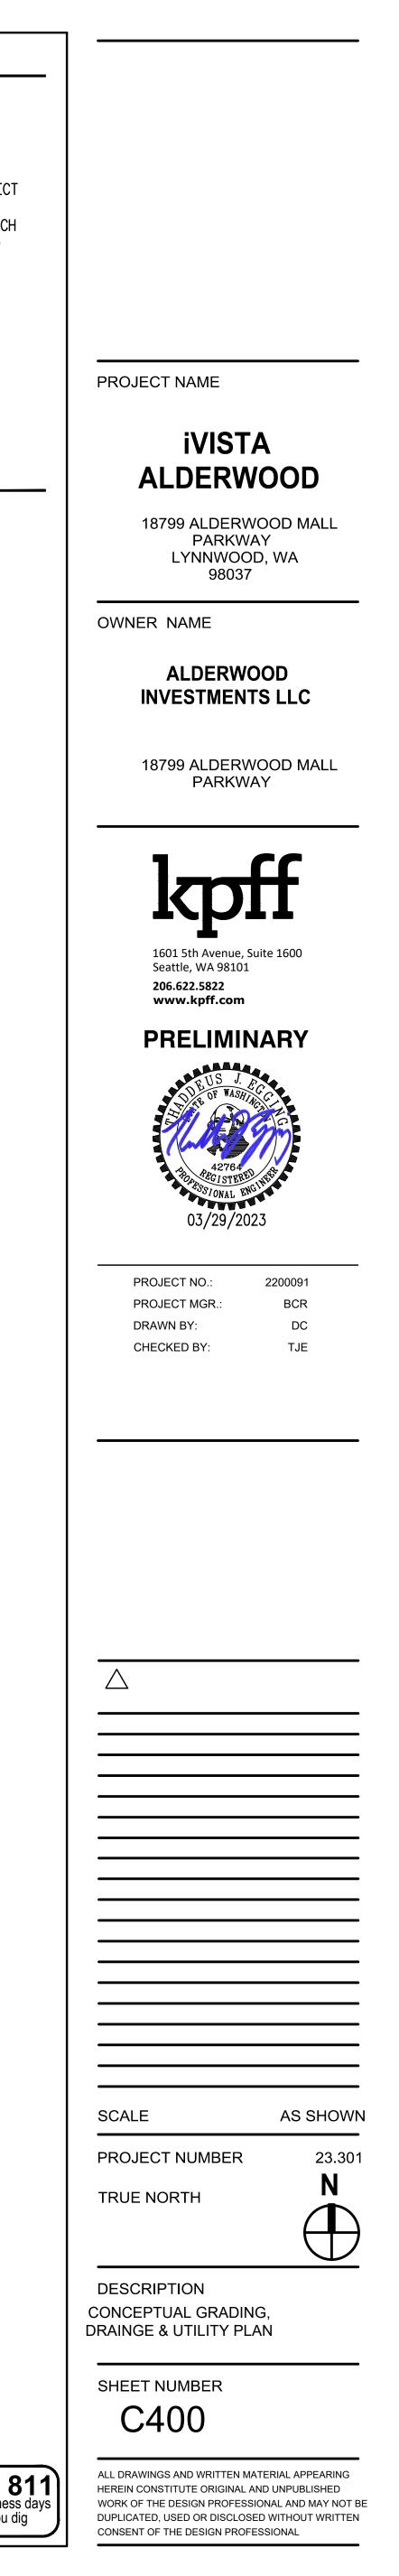

GRADE PLANE CALCULATION

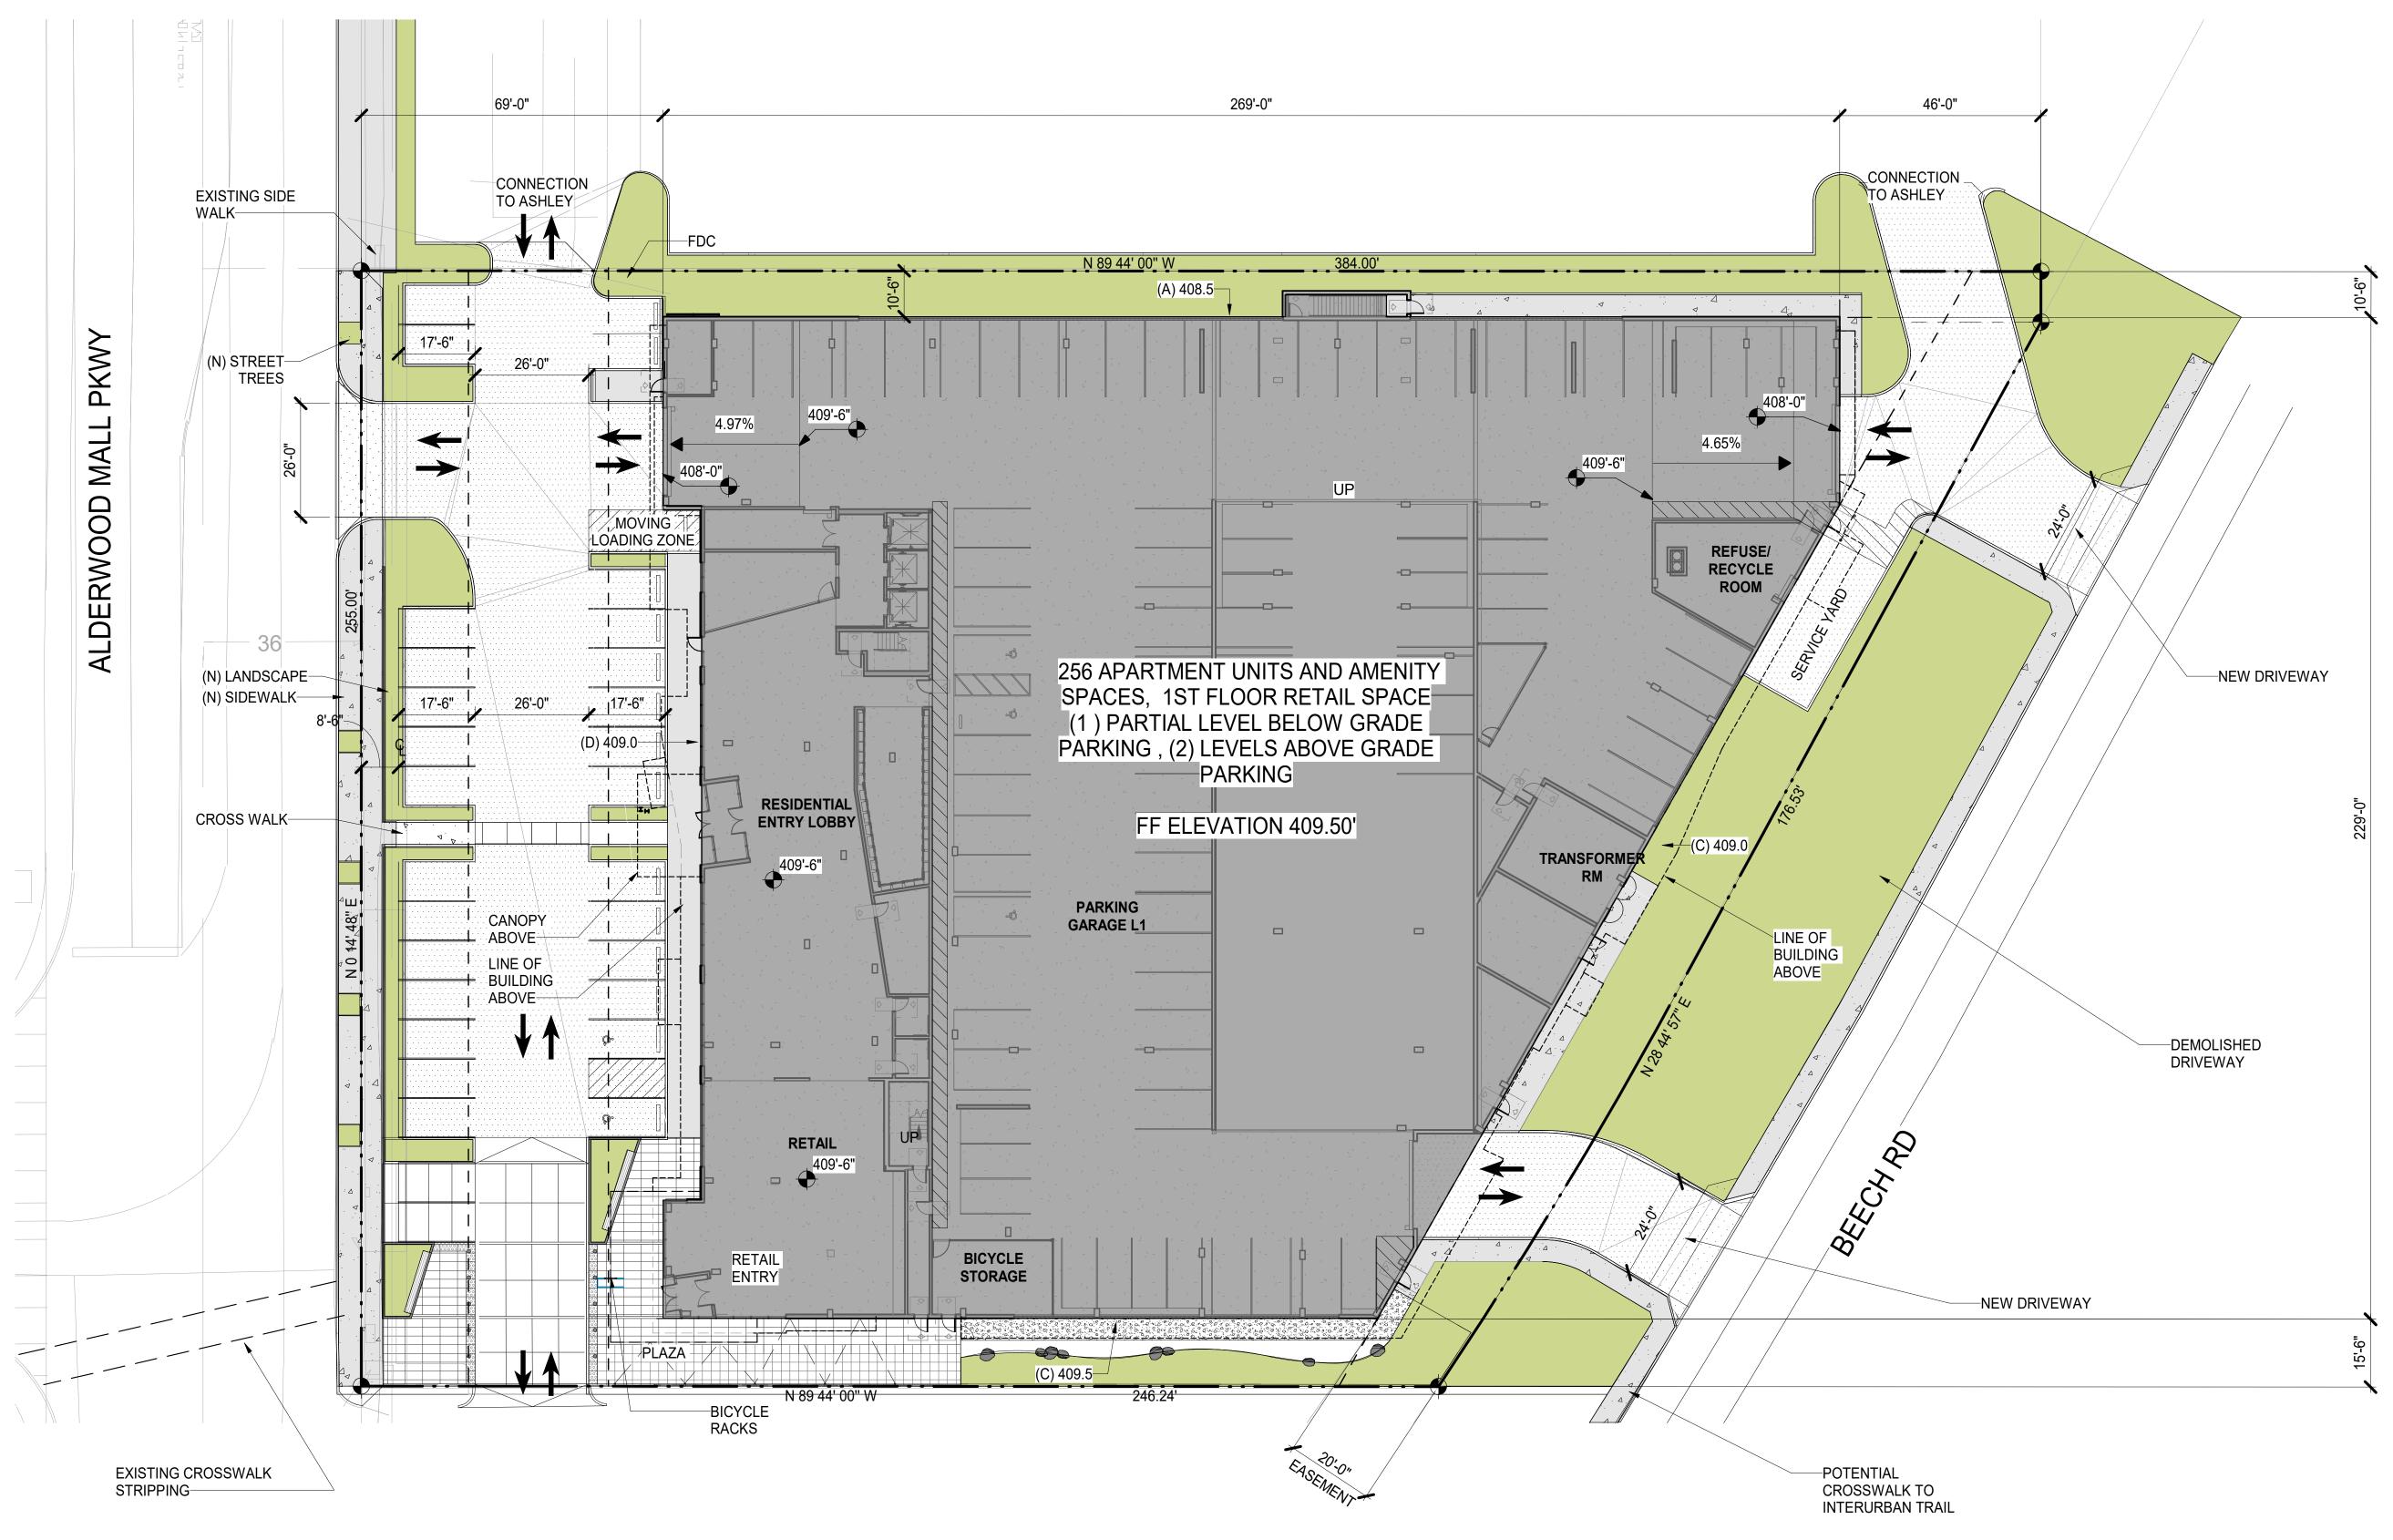GRADE PLANE

LOT GRADE MEANS THE AVERAGE OF THE FINISHED GROUND LEVEL AT THE CENTER OF ALL EXPOSED WALLS OF THE BUILDING. IN CASE WALLS ARE PARALLEL TO AND WITHIN FIVE FEET OF THE SIDEWALK, THE ABOVE GROUND LEVEL SHALL BE MEASURED AT THE SIDEWALK. (ORD. 2020 § 2, 1994; ORD. 190 ART. IV § 407, 1964) LOT GRADE CALCULATION: NORTH (A)= 408.5, EAST (B)= 409.00, SOUTH (C)=409.5, WEST (D)=409.0 408.5+ 409.00+409.5+409=1,636

1636/4= <u>409.00</u>

SHEET NOTES

- 1. REFER TO CIVIL, LANDSCAPE DWGS FOR MORE INFORMATION.
- 2. REFER TO SITE LIGHTING DWG FOR PARKING LOT, POOL AND LANDSCAPE LIGHTING DESIGN.
- 3. PROHIBIT SMOKING WITHIN 25 FEET OF BUILDING ENTRIES, OUTDOOR AIR INTAKES AND OPERABLE WINDOWS. PROVIDE NO SMOKING SIGNAGE WITHIN THESE AREAS. [CALGREEN 5.504.7]
- 4. AT HAZARDOUS VEHICULAR AREAS, DETECTABLE WARNING SURFACES SHALL BE YELLOW CONFORMING TO FS 33538 OF FEDERAL STANDARD 595C
- 5. ONLY APPROVED DSA-AC DETECTABLE WARNING PRODUCTS AND DIRECTIONAL SURFACES SHALL BE INSTALLED [CBC SEC 11B-705.3]

A1.01

KEYNOTES




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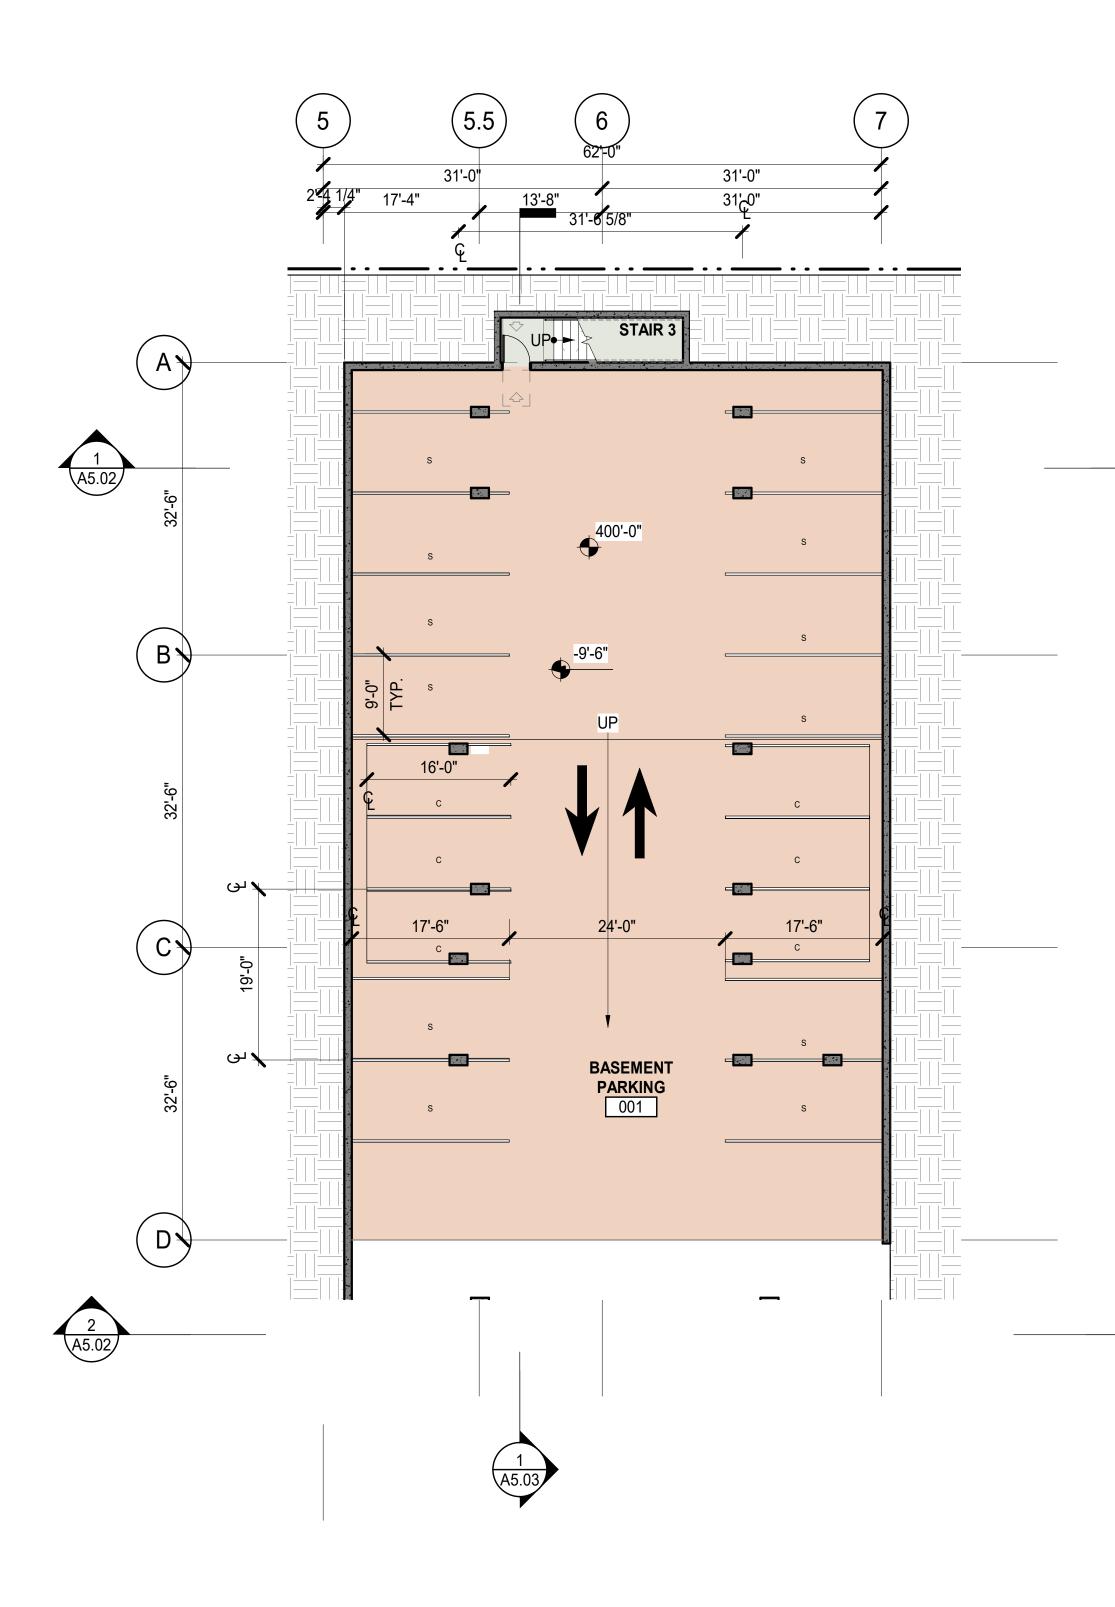
iVista@Alderwood

18799 ALDERWOOD MALL PARKWAY LYNNWOOD, WA 98037

OWNER NAME

ALDERWOOD INVESTMENTS LLC



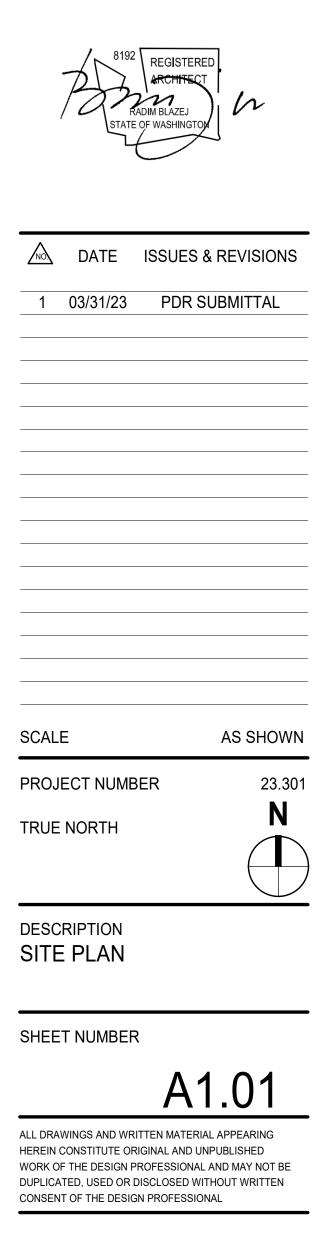

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- 4. SEE WINDOW SCHEDULE A0.21 FOR ALL WINDOW & EXTERIOR LOUVER SIZES.
- 5. ALL WINDOWS ARE LOCATED ON FLOOR PLANS A2.00 SERIES. 6. SEE ELEVATIONS ON A4.00 SERIES FOR ALL
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CONCRETE MASONRY UNIT WALL




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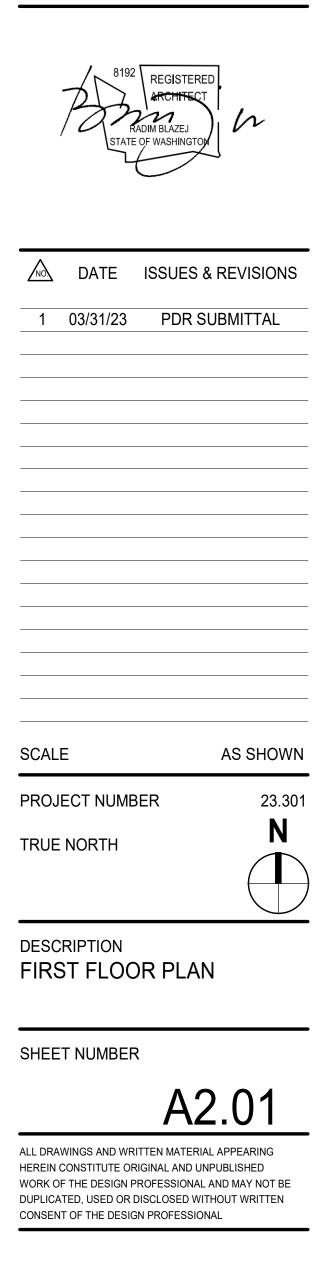
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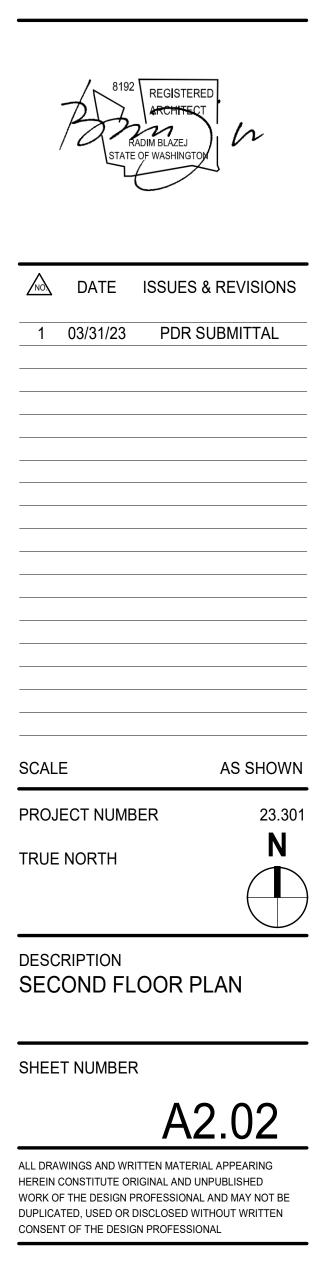
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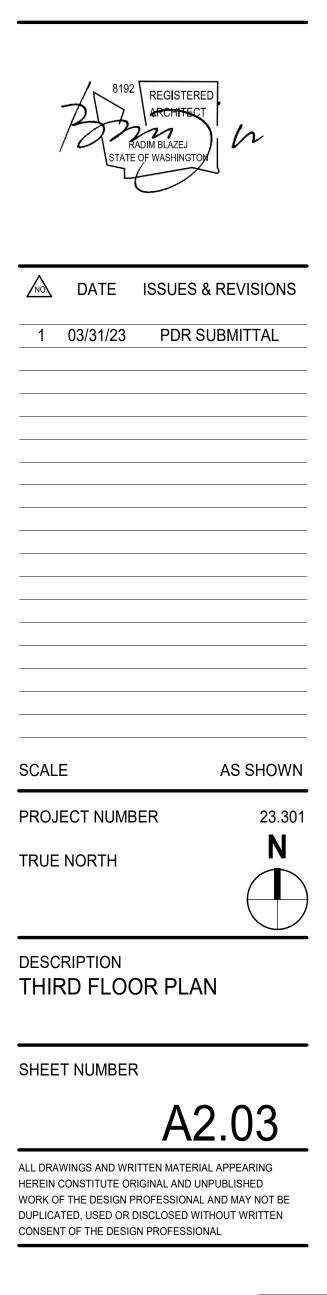
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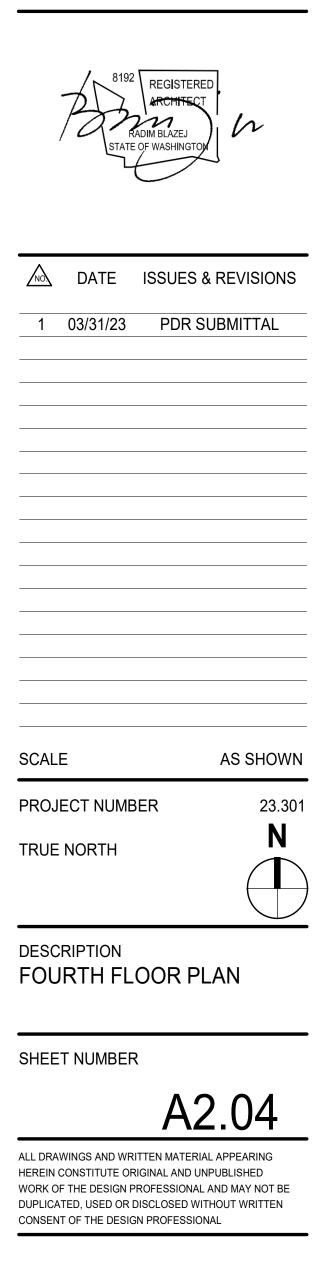
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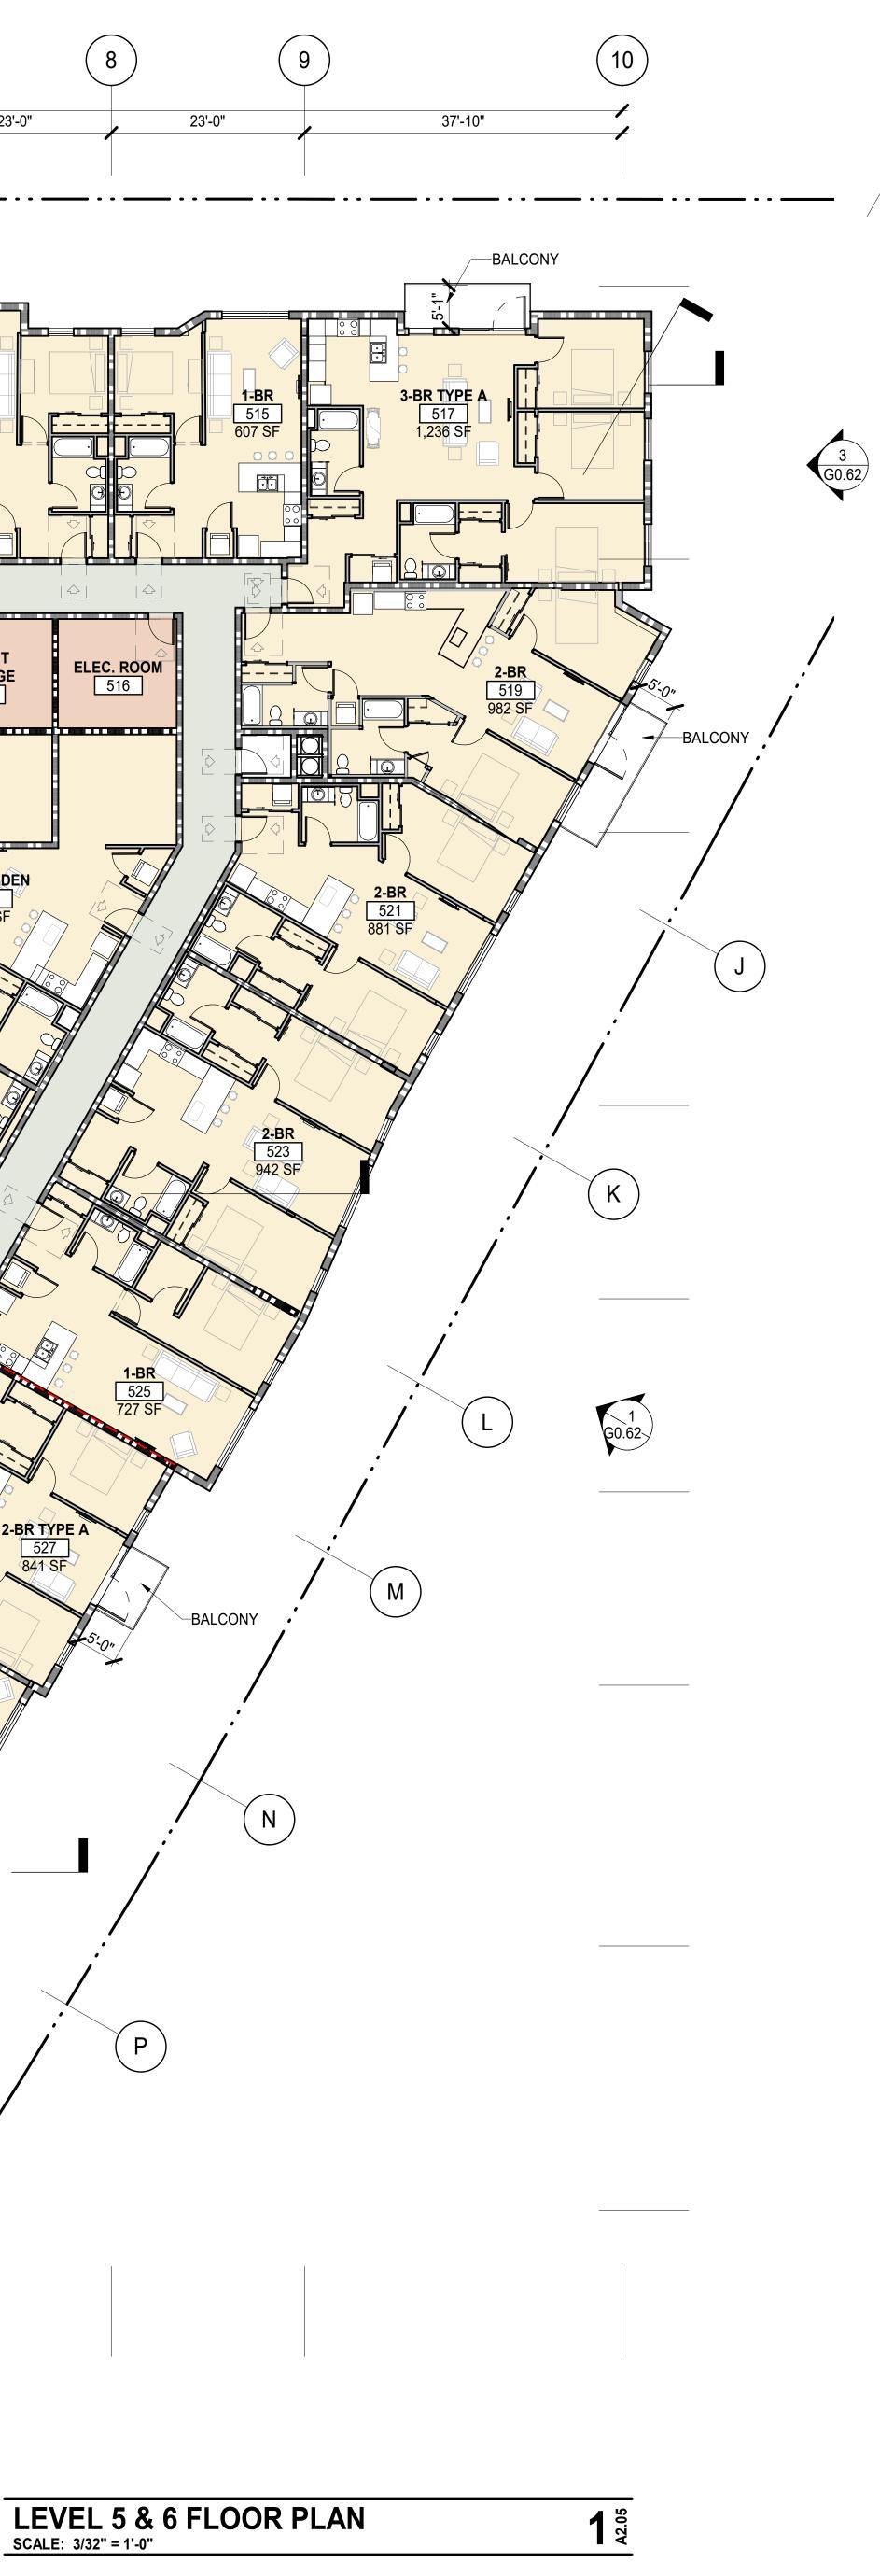
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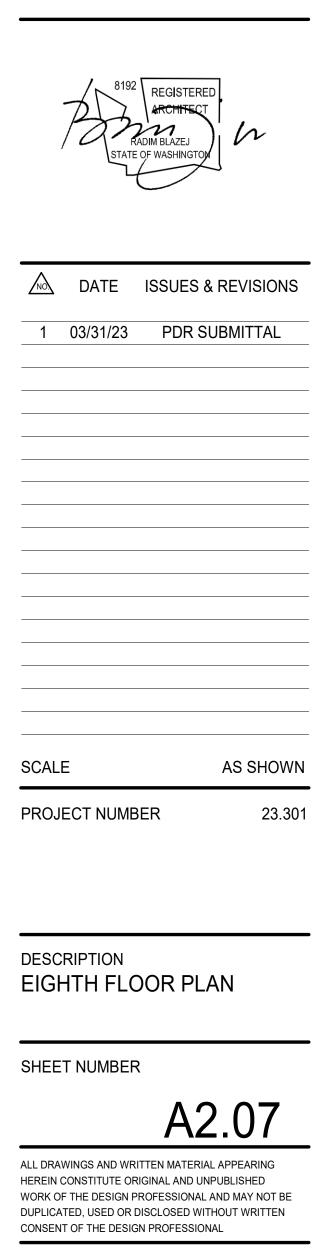
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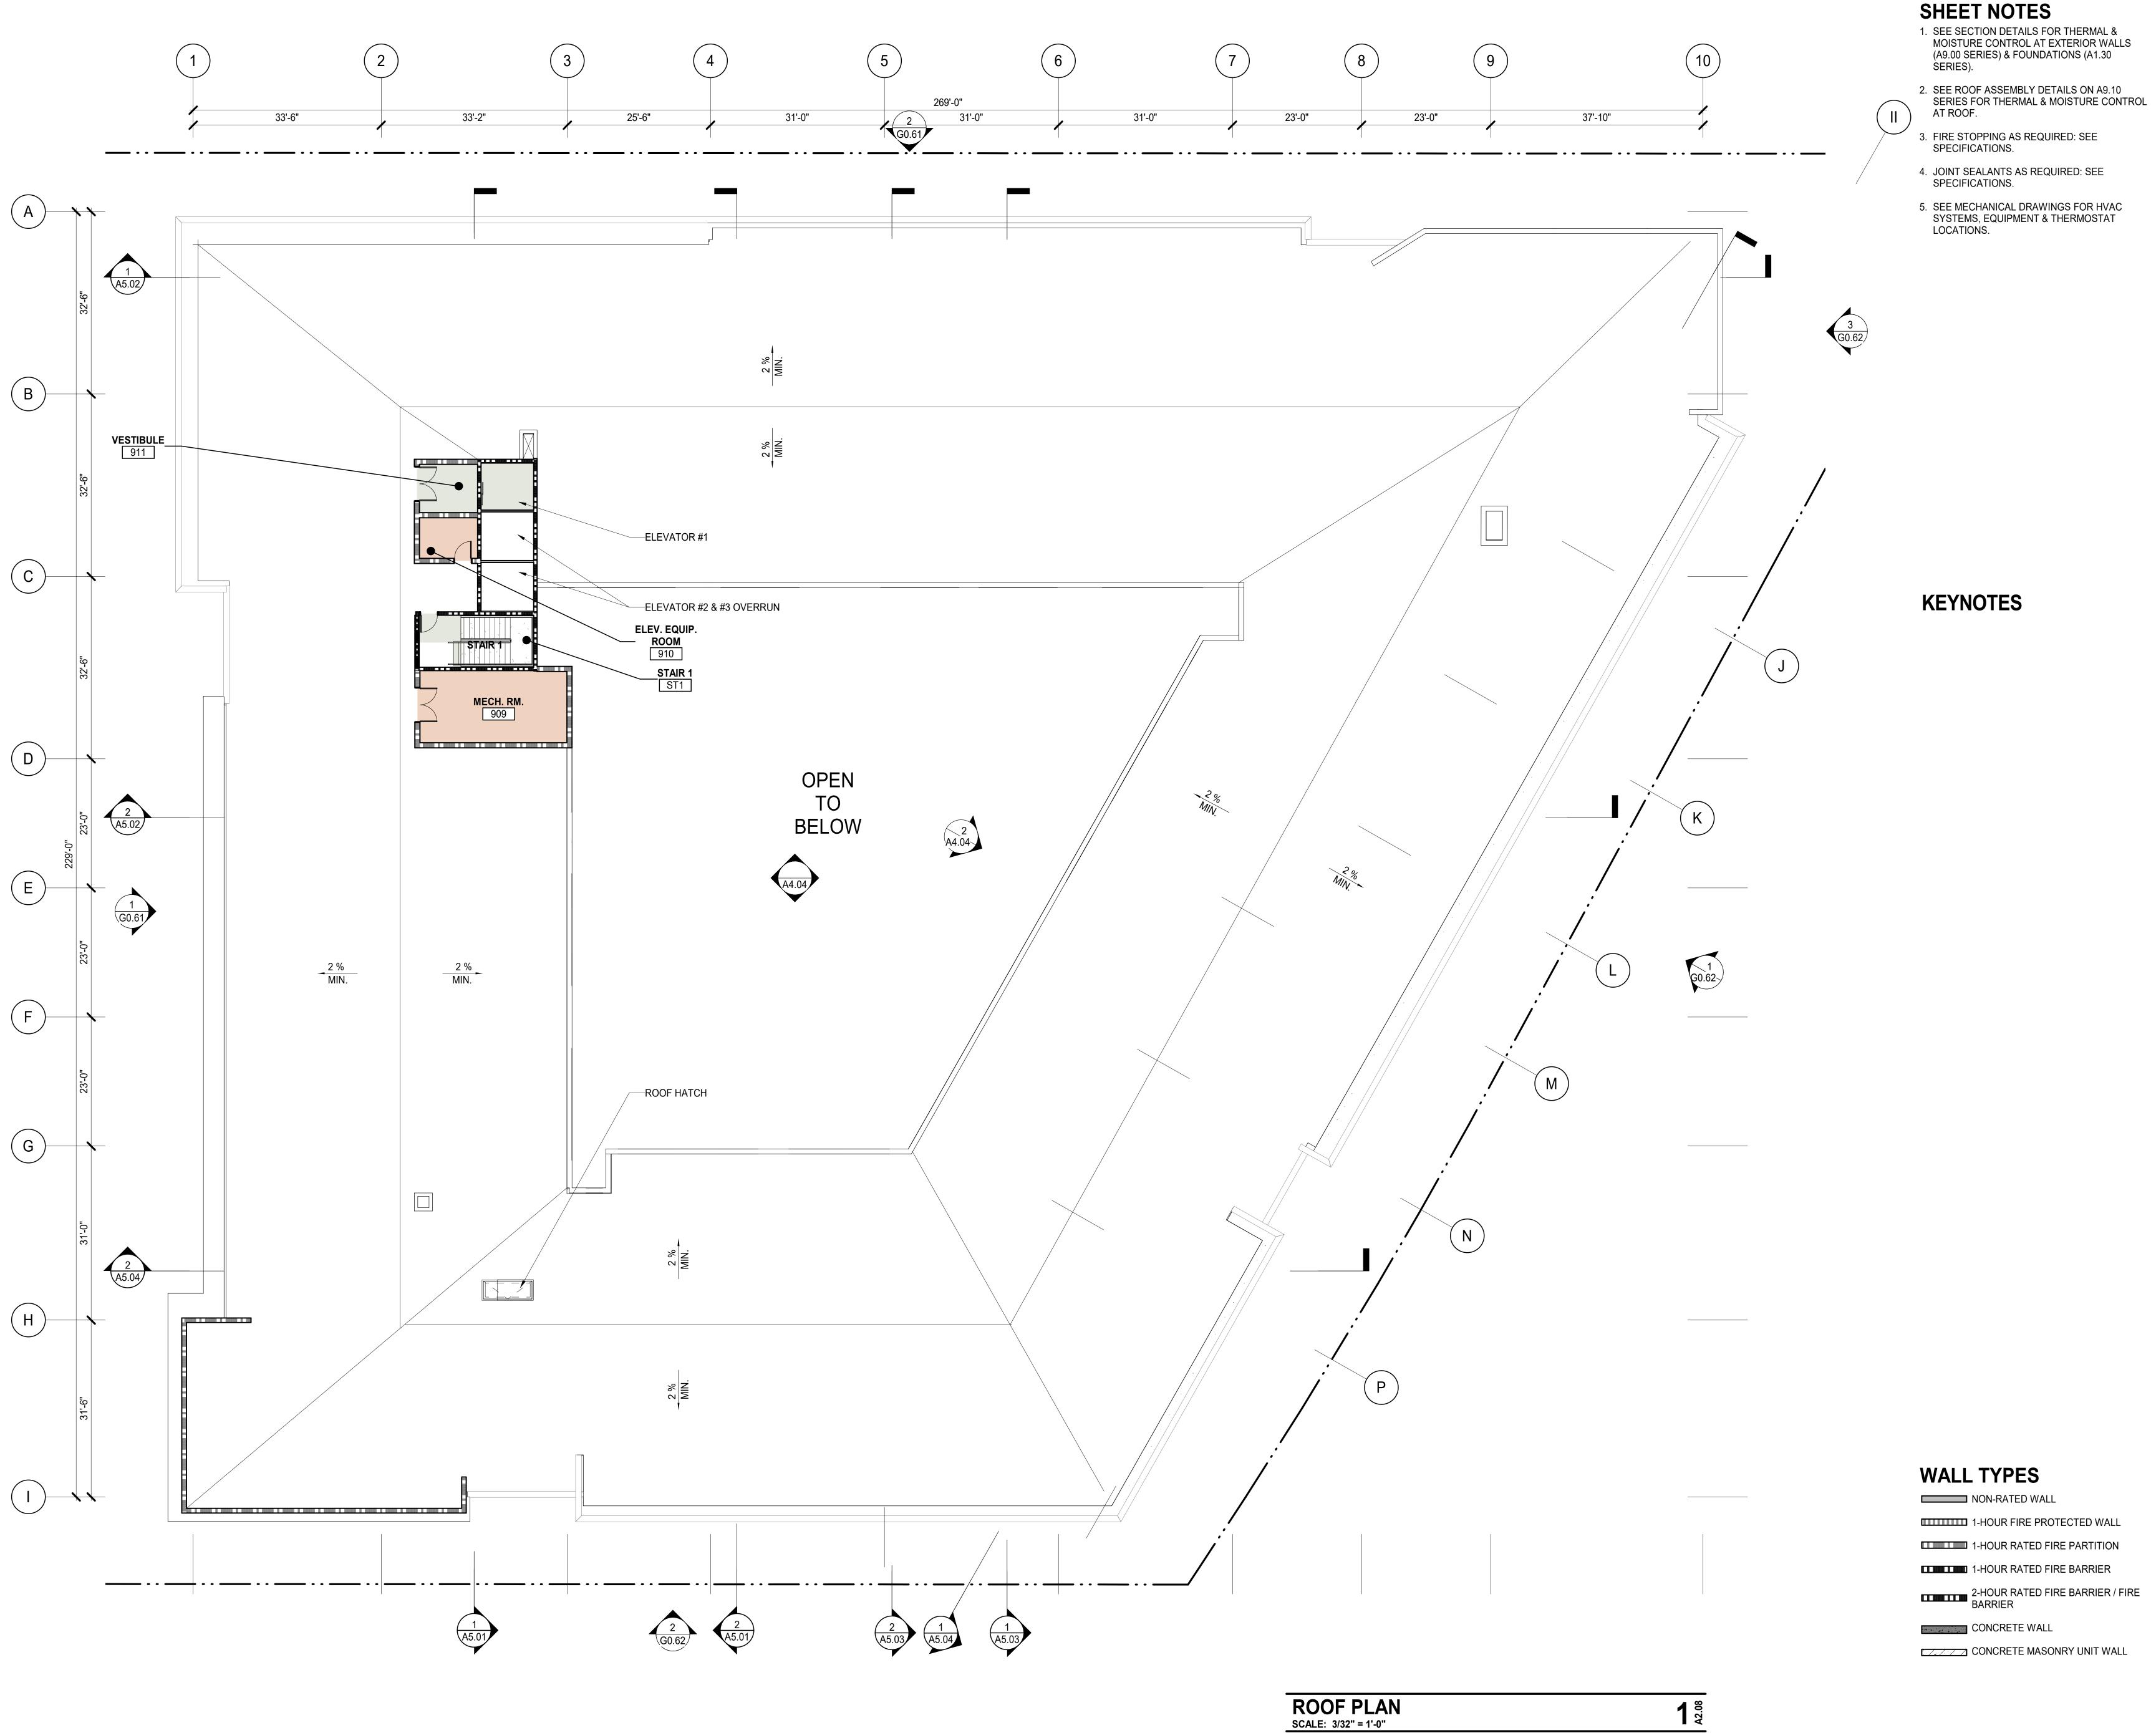
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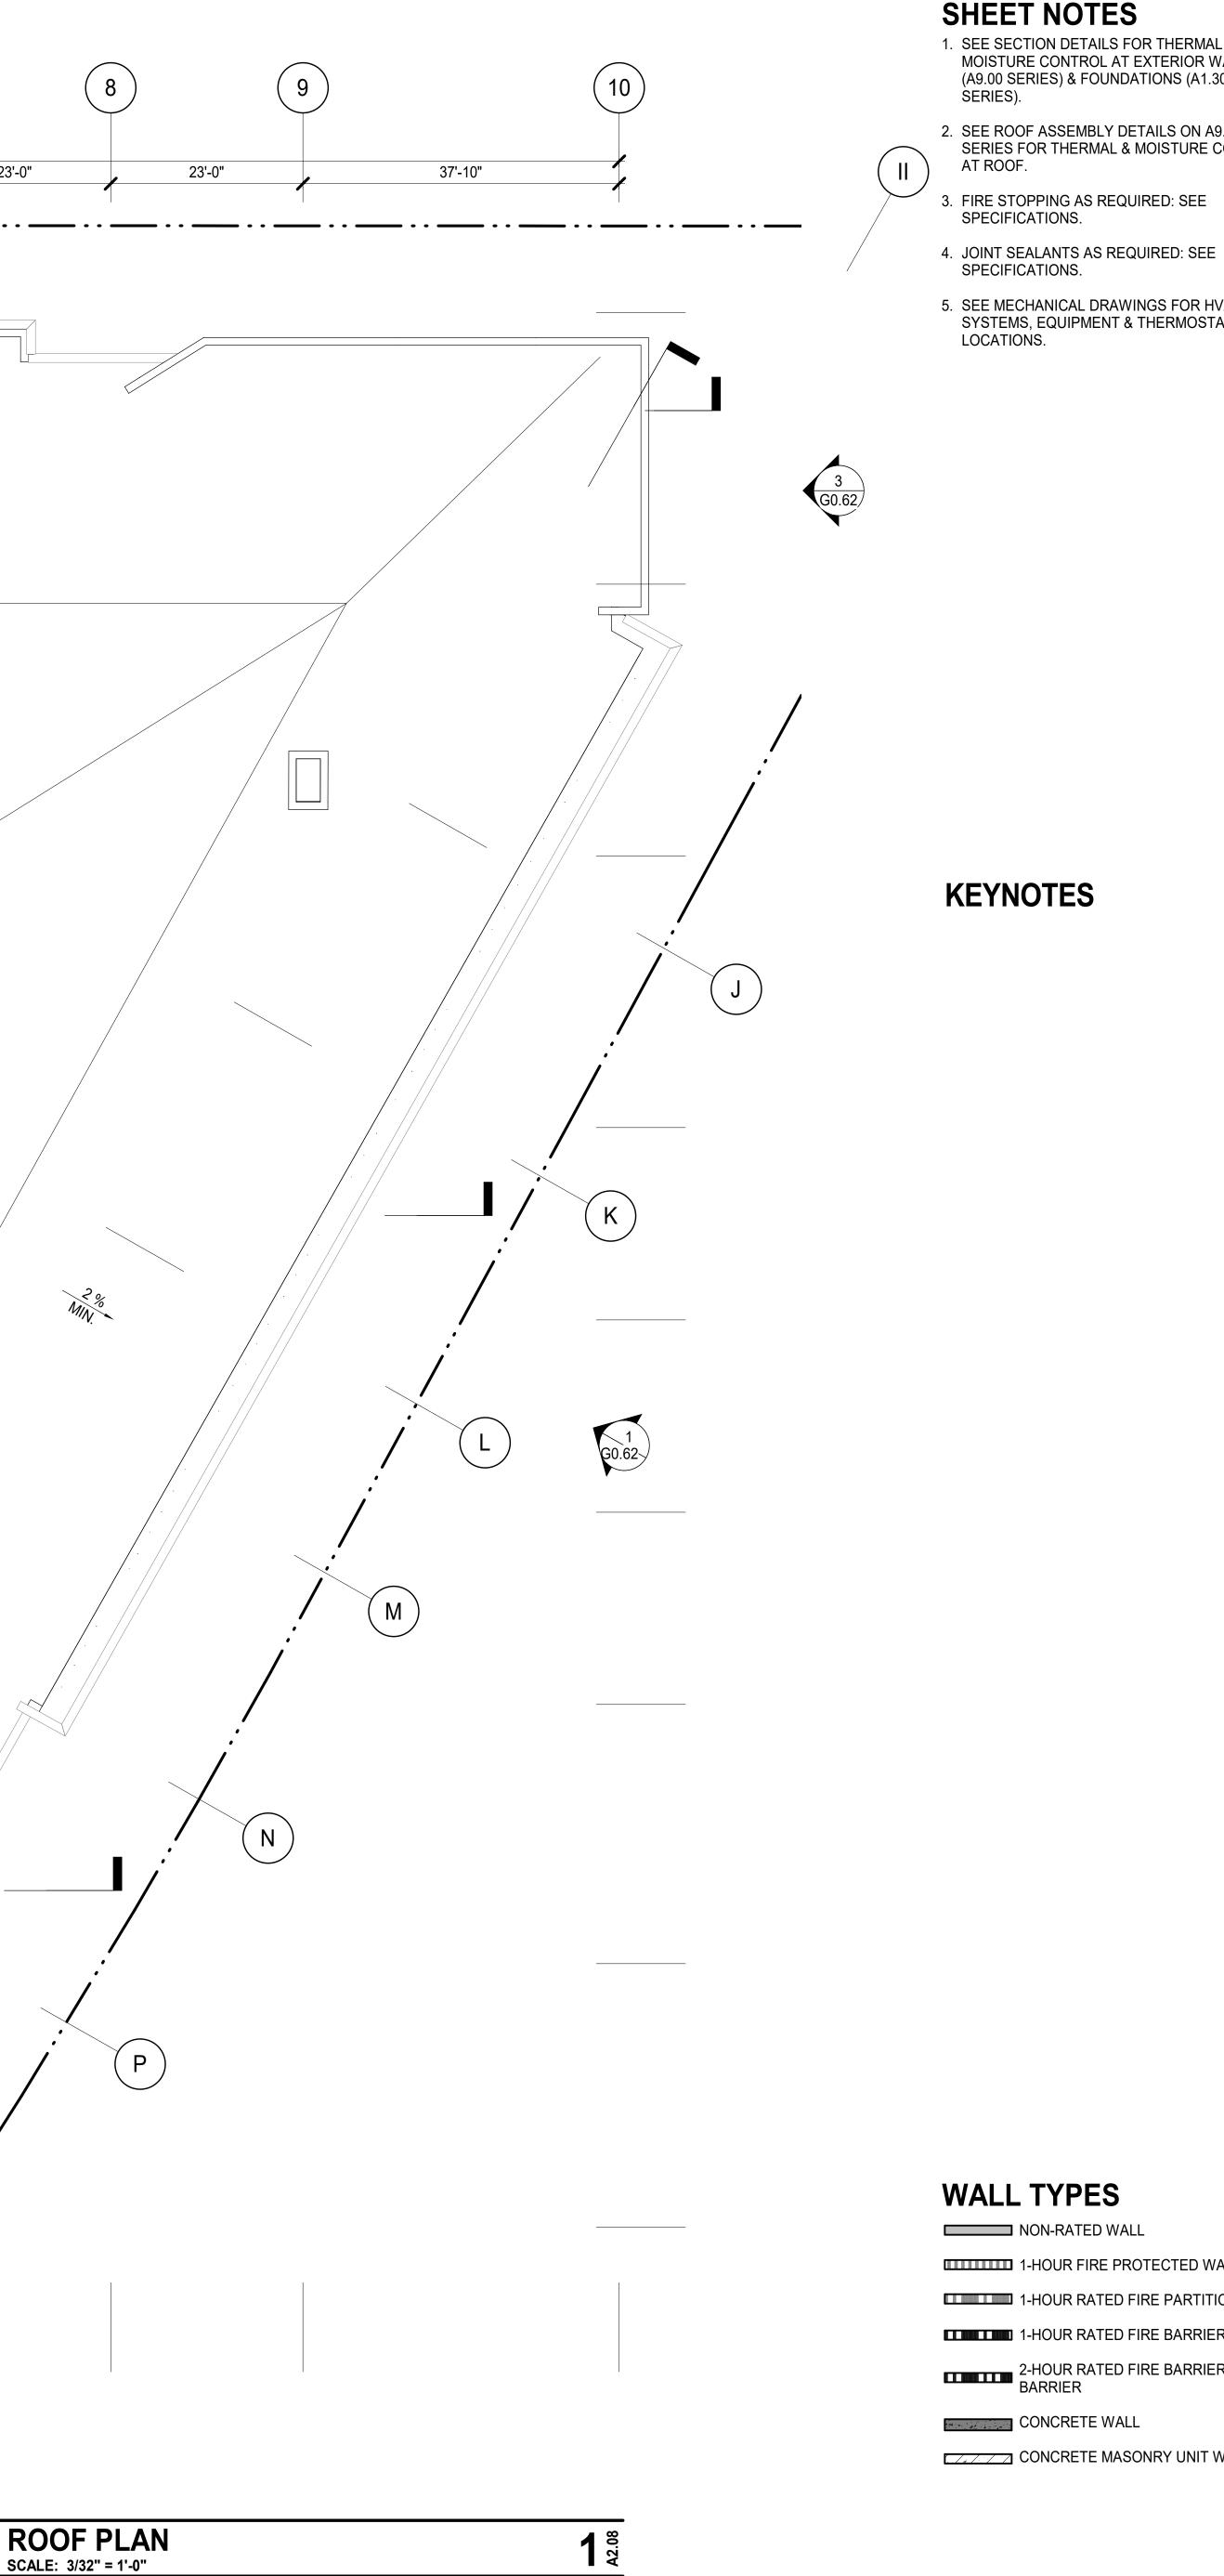
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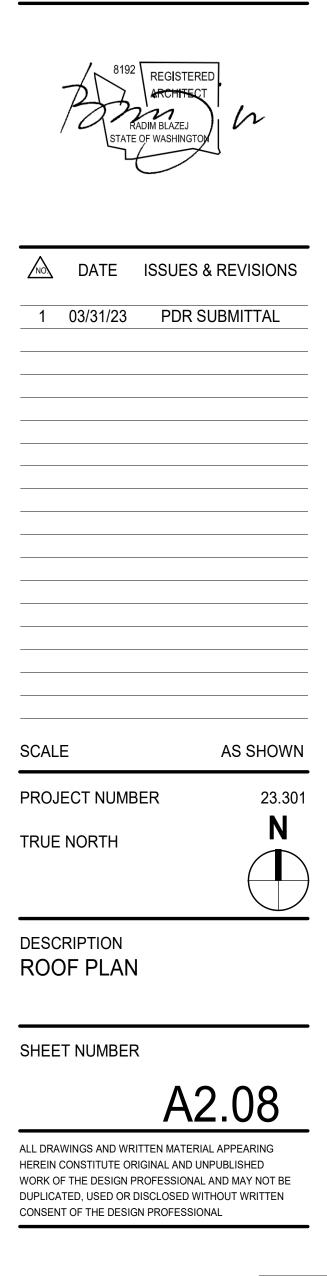
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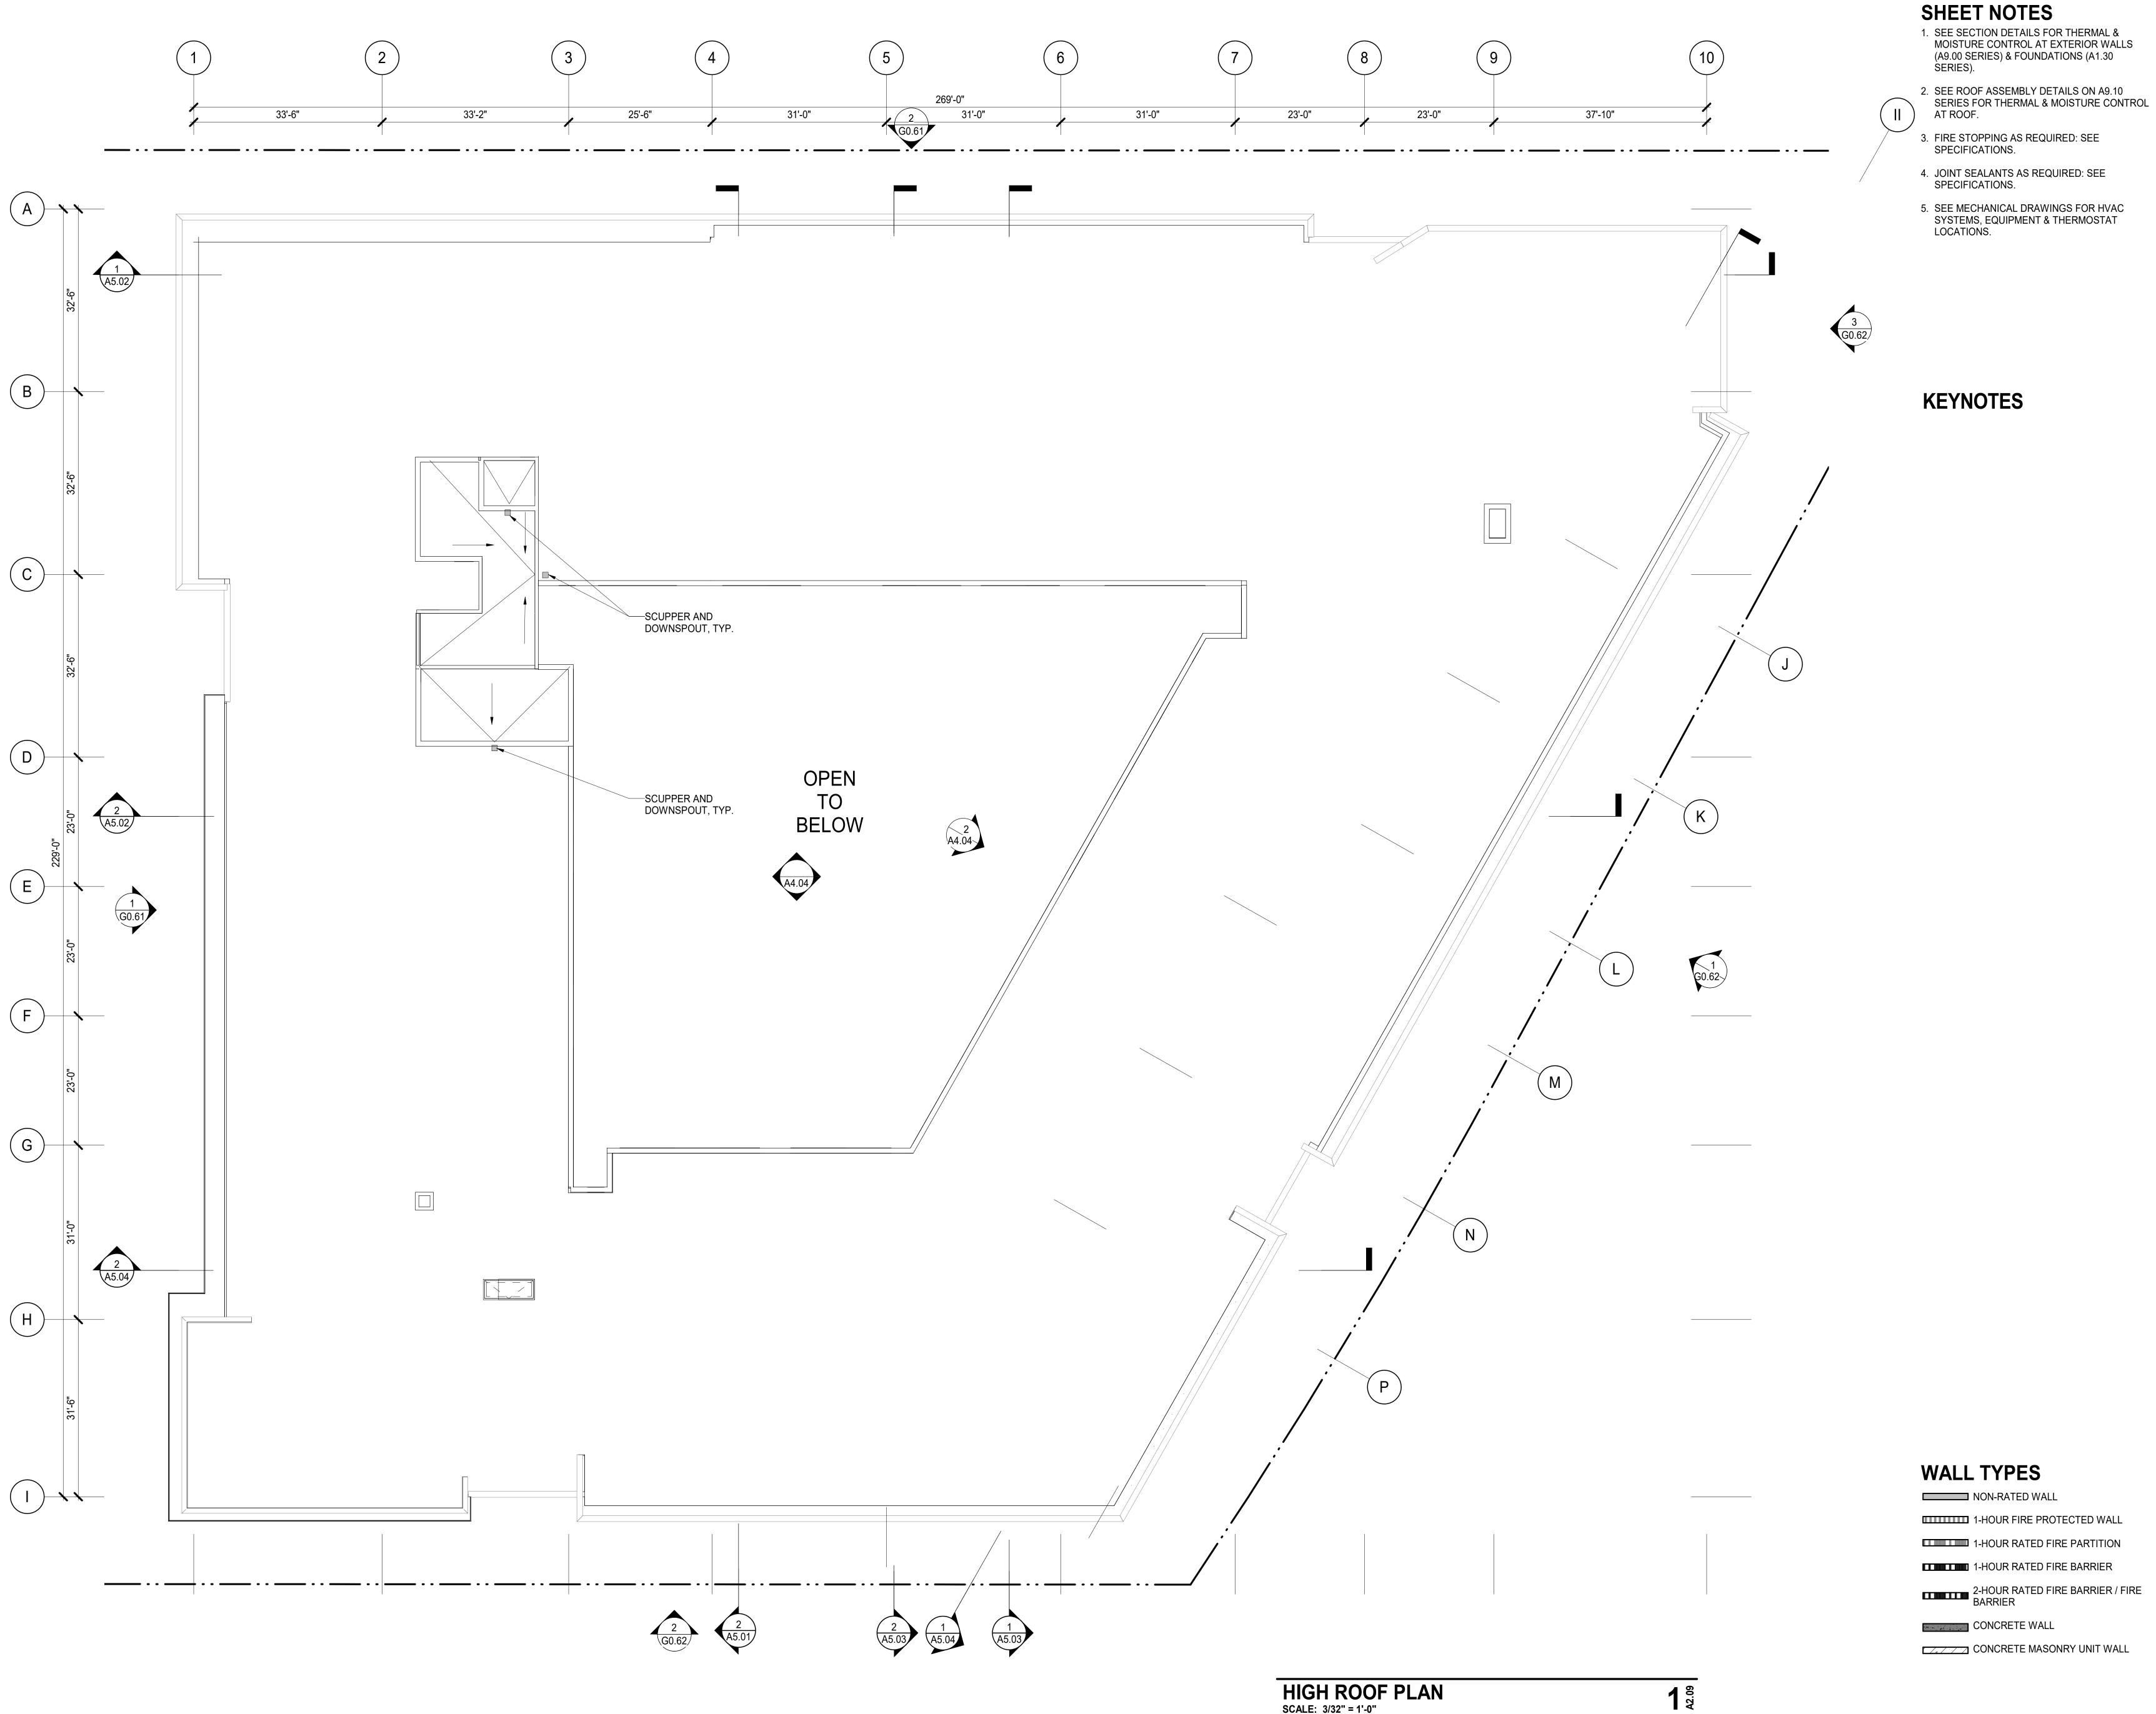
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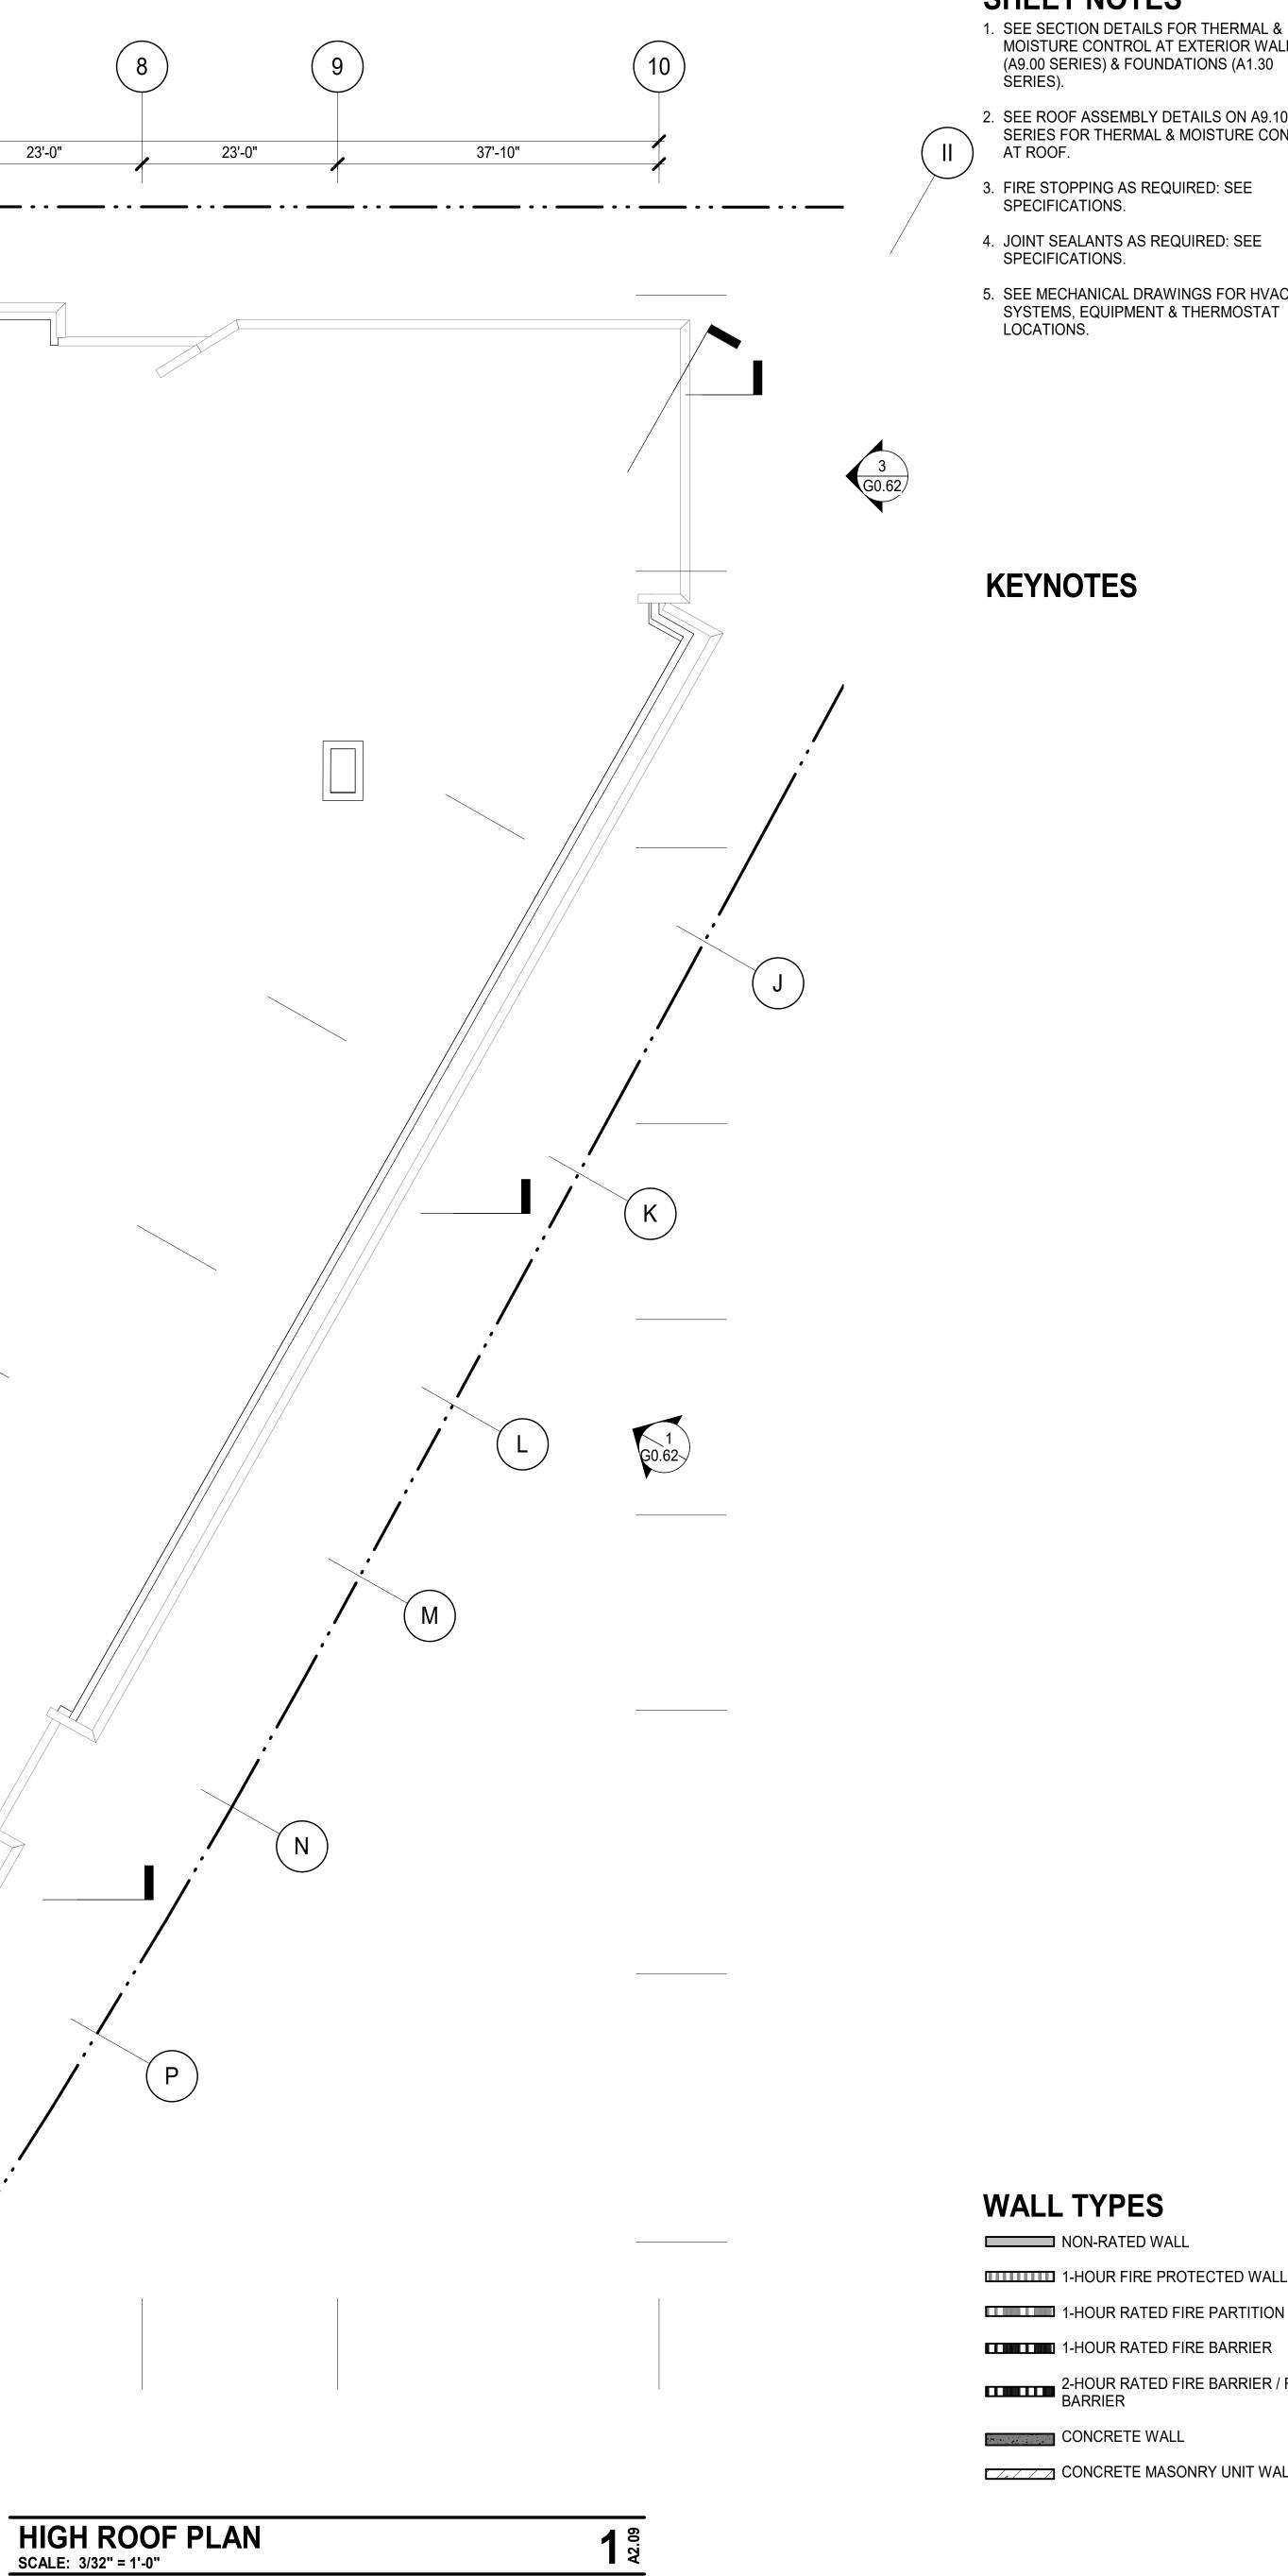
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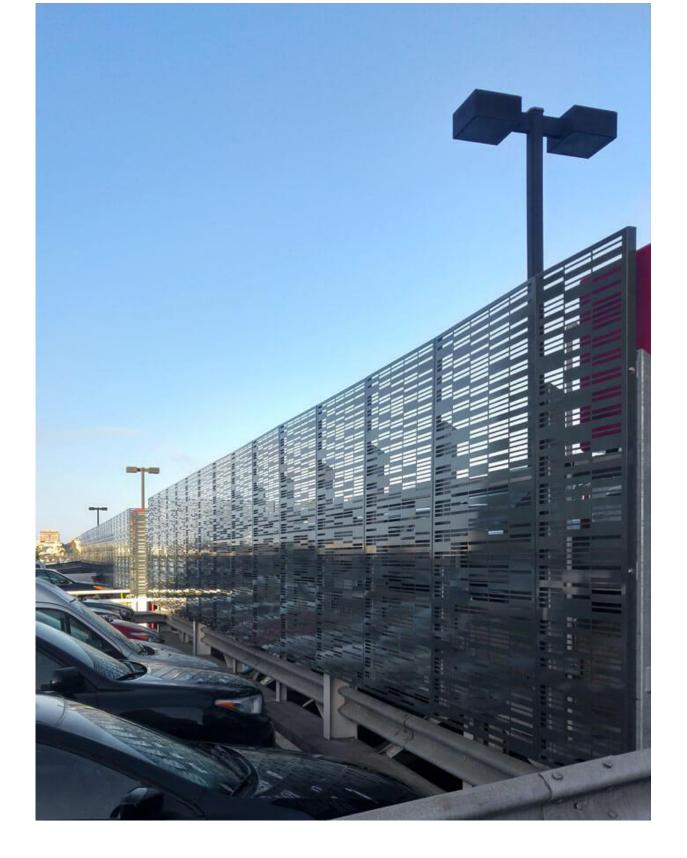
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NOTE: MTL-5 METAL SCREEN SIMILAR TO THE ABOVE. IMAGE FOR REFERENCE.

MTL-5 METAL SCREEN OPENING

RENDERING FOR REFERENCE



CONC-1 SITECAST CONCRETE - SMOOTH FINISH

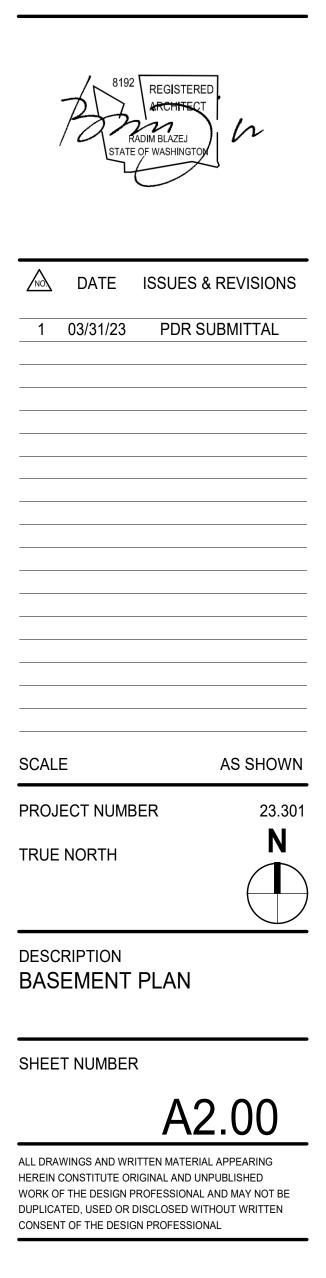

HPL-1 HIGH PRESSURE LAMINATED PANELS - WESTERN RED CEDAR



FCP-4 FIBER CEMENT PANEL - LIGHT GREY

TAG	FINISH MATERIAL	NOTES
CONC-1	SITE-CAST CONCRETE	SMOOTH FINISH
FCP-1	FIBER CEMENT PANEL	BEIGE
FCP-2	FIBER CEMENT PANEL	DARK BROWN
FCP-3	FIBER CEMENT PANEL	DARK GREY
FCP-4	FIBER CEMENT PANEL	LIGHT GREY
GL-1	RESIDENTIAL WINDOWS	VINYL - BLACK
GL-2	STOREFRONT GLAZING SYSTEM	DARK BRONZE METALLIC
HPL-1	HIGH PRESSURE LAMINATE PANELS	WESTERN RED CEDAR
MTL-1	STEEL CANOPY	COLOR: BLACK
MTL-2	BOLT-ON METAL BALCONIES & RAILING	COLOR: BLACK
MTL-3	GALV. METAL PARAPET FLASHING	COLOR TO MATCH ADJACENT SIDING
MTL-4	METAL SCUPPER AND DOWNSPOUTS	COLOR TO MATCH ADJACENT SIDING
MTL-5	METAL SCREEN OPENING AT GARAGE	

FINISH LEGEND - EXTERIOR





FCP-3 FIBER CEMENT PANEL - DARK GREY



FCP-2 FIBER CEMENT PANEL - DARK BROWN



FCP-1 FIBER CEMENT PANEL - BEIGE

AXIS 801 BLANCHARD ST, SUITE 200 SEATTLE, WA 98121 T 206.367.1382 F 206.367.1385 www.axisgfa.com


PROJECT NAME

iVista@Alderwood

18799 ALDERWOOD MALL PARKWAY LYNNWOOD, WA 98037

OWNER NAME

ALDERWOOD INVESTMENTS LLC

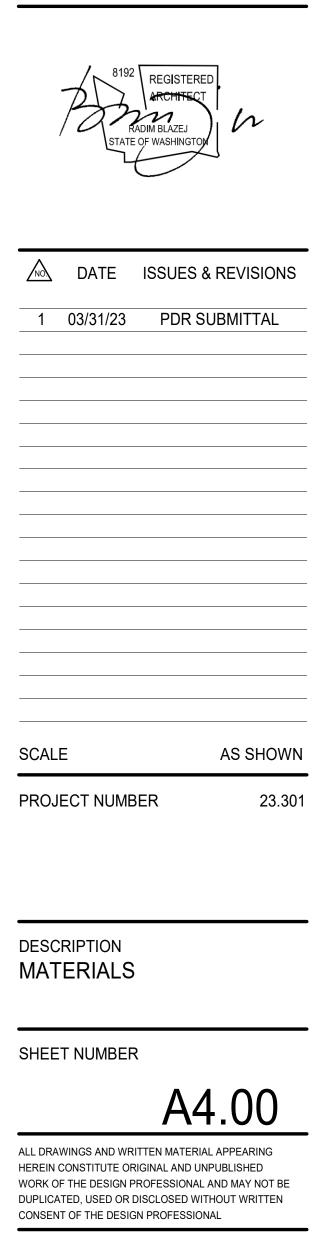



HPL-1

MTL-5

 $\overline{7}$





- 1. SEE WINDOW SCHEDULE A0.21 FOR ALL WINDOW SIZES.
- 2. SEE LOUVER SCHEDULE A0.21 FOR ALL EXTERIOR LOUVER SIZES.
- 3. ALL WINDOWS ARE LOCATED ON FLOOR
- PLANS A2.00 SERIES.
- 4. SEE ELEVATIONS ON A4.00 SERIES FOR ALL EXTERIOR FINISH MATERIALS.
- 5. ALL SIGNAGE REQUIRES SEPARATE PERMIT BY SIGN CONTRACTOR
- 6. SEE A9.01 FOR EXTERIOR PARTITION DETAILS.
- 7. SEE A9.20 SERIES FOR EXTERIOR WINDOW DETAILS.

KEYNOTES

TAG	FINISH MATERIAL	NOTES
CONC-1	SITE-CAST CONCRETE	SMOOTH FINISH
FCP-1	FIBER CEMENT PANEL	BEIGE
FCP-2	FIBER CEMENT PANEL	DARK BROWN
FCP-3	FIBER CEMENT PANEL	DARK GREY
FCP-4	FIBER CEMENT PANEL	LIGHT GREY
GL-1	RESIDENTIAL WINDOWS	VINYL - BLACK
GL-2	STOREFRONT GLAZING SYSTEM	DARK BRONZE METALLIC
HPL-1	HIGH PRESSURE LAMINATE PANELS	WESTERN RED CEDAR
MTL-1	STEEL CANOPY	COLOR: BLACK
MTL-2	BOLT-ON METAL BALCONIES & RAILING	COLOR: BLACK
MTL-3	GALV. METAL PARAPET FLASHING	COLOR TO MATCH ADJACENT SIDING
MTL-4	METAL SCUPPER AND DOWNSPOUTS	COLOR TO MATCH ADJACENT SIDING
MTL-5	METAL SCREEN OPENING AT GARAGE	

NORTH ELEVATION SCALE: 1/8" = 1'-0"



PROJECT NAME

iVista@Alderwood

18799 ALDERWOOD MALL PARKWAY LYNNWOOD, WA 98037

OWNER NAME

ALDERWOOD INVESTMENTS LLC

18799 ALDERWOOD MALL PARKWAY

	/ \	REGISTERED ARCHITECT DIM BLAZEJ OF WASHINGTON	Ъ
NO	DATE	ISSUES & F	REVISIONS
1	03/31/23	PDR SUE	BMITTAL
SCAL	E		AS SHOW
PROJ	ECT NUMB	ER	23.3
	RIPTION	_EVATIO	NS
SHEE	T NUMBER		

WORK OF THE DESIGN PROFESSIONAL AND MAY NOT BE DUPLICATED, USED OR DISCLOSED WITHOUT WRITTEN CONSENT OF THE DESIGN PROFESSIONAL





SHEET NOTES

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FCP-2	FIBER CEMENT PANEL	DARK BROWN
FCP-3	FIBER CEMENT PANEL	DARK GREY
FCP-4	FIBER CEMENT PANEL	LIGHT GREY
GL-1	RESIDENTIAL WINDOWS	VINYL - BLACK
GL-2	STOREFRONT GLAZING SYSTEM	DARK BRONZE METALLIC
HPL-1	HIGH PRESSURE LAMINATE PANELS	WESTERN RED CEDAR
MTL-1	STEEL CANOPY	COLOR: BLACK
MTL-2	BOLT-ON METAL BALCONIES & RAILING	COLOR: BLACK
MTL-3	GALV. METAL PARAPET FLASHING	COLOR TO MATCH ADJACENT SIDING
MTL-4	METAL SCUPPER AND DOWNSPOUTS	COLOR TO MATCH ADJACENT SIDING
MTL-5	METAL SCREEN OPENING AT GARAGE	



PROJECT NAME

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ALDERWOOD INVESTMENTS LLC





SCALE: 1/8" = 1'-0"



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- SIGN CONTRACTOR 6. SEE A9.01 FOR EXTERIOR PARTITION DETAILS.
- 7. SEE A9.20 SERIES FOR EXTERIOR WINDOW
- DETAILS.

KEYNOTES

TAG	FINISH MATERIAL	NOTE
CONC-1	SITE-CAST CONCRETE	SMOOTH F
FCP-1	FIBER CEMENT PANEL	BEIGE
FCP-2	FIBER CEMENT PANEL	DARK BR
FCP-3	FIBER CEMENT PANEL	DARK GI
FCP-4	FIBER CEMENT PANEL	LIGHT G
GL-1	RESIDENTIAL WINDOWS	VINYL - BI
GL-2	STOREFRONT GLAZING SYSTEM	DARK BRO METALI
HPL-1	HIGH PRESSURE LAMINATE PANELS	WESTERN CEDA
MTL-1	STEEL CANOPY	COLOR: B
MTL-2	BOLT-ON METAL BALCONIES & RAILING	COLOR: B
MTL-3	GALV. METAL PARAPET FLASHING	COLOR TO ADJACENT
MTL-4	METAL SCUPPER AND DOWNSPOUTS	COLOR TO
MTL-5	METAL SCREEN OPENING AT GARAGE	

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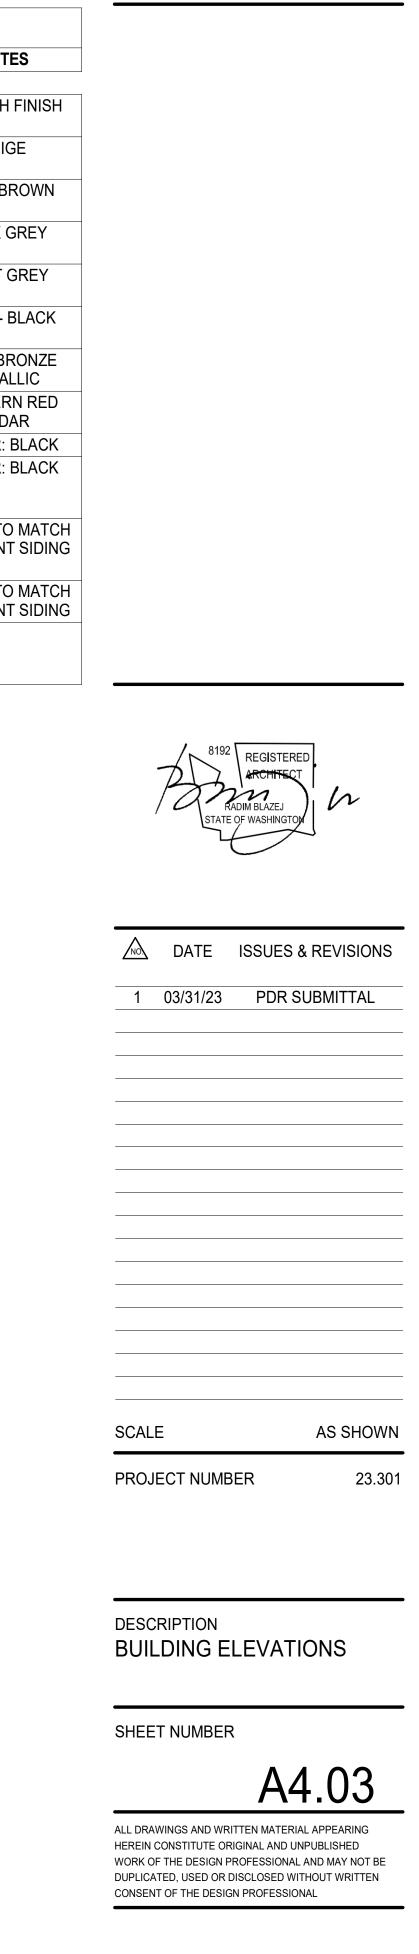
PROJECT NAME

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OWNER NAME

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SCALE: 1/8" = 1'-0"



34.04

SCALE: 1/8" = 1'-0"



- 1. SEE WINDOW SCHEDULE A0.21 FOR ALL WINDOW SIZES.
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FINISH MATERIAL	NOTES
SITE-CAST CONCRETE	SMOOTH FI
FIBER CEMENT PANEL	BEIGE
FIBER CEMENT PANEL	DARK BRO
FIBER CEMENT PANEL	DARK GR
FIBER CEMENT PANEL	LIGHT GR
RESIDENTIAL WINDOWS	VINYL - BLA
STOREFRONT GLAZING SYSTEM	DARK BRO METALLI
HIGH PRESSURE LAMINATE PANELS	WESTERN I CEDAR
STEEL CANOPY	COLOR: BL
BOLT-ON METAL BALCONIES & RAILING	COLOR: BL
GALV. METAL PARAPET FLASHING	COLOR TO M ADJACENT S
METAL SCUPPER AND DOWNSPOUTS	COLOR TO M ADJACENT S
METAL SCREEN OPENING AT GARAGE	
	SITE-CAST CONCRETE FIBER CEMENT PANEL FIBER CEMENT PANEL FIBER CEMENT PANEL FIBER CEMENT PANEL FIBER CEMENT PANEL RESIDENTIAL WINDOWS STOREFRONT GLAZING SYSTEM HIGH PRESSURE LAMINATE PANELS STEEL CANOPY BOLT-ON METAL BALCONIES & RAILING GALV. METAL BALCONIES & RAILING METAL SCUPPER AND DOWNSPOUTS

COURTYARD - NORTH ELEVATION

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PROJECT NAME


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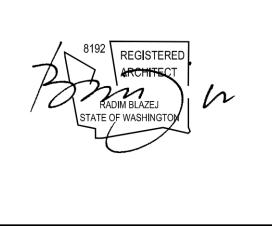
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OWNER NAME

ALDERWOOD INVESTMENTS LLC

18799 ALDERWOOD MALL PARKWAY




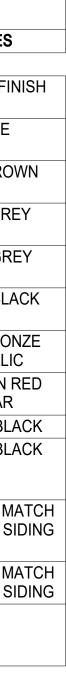


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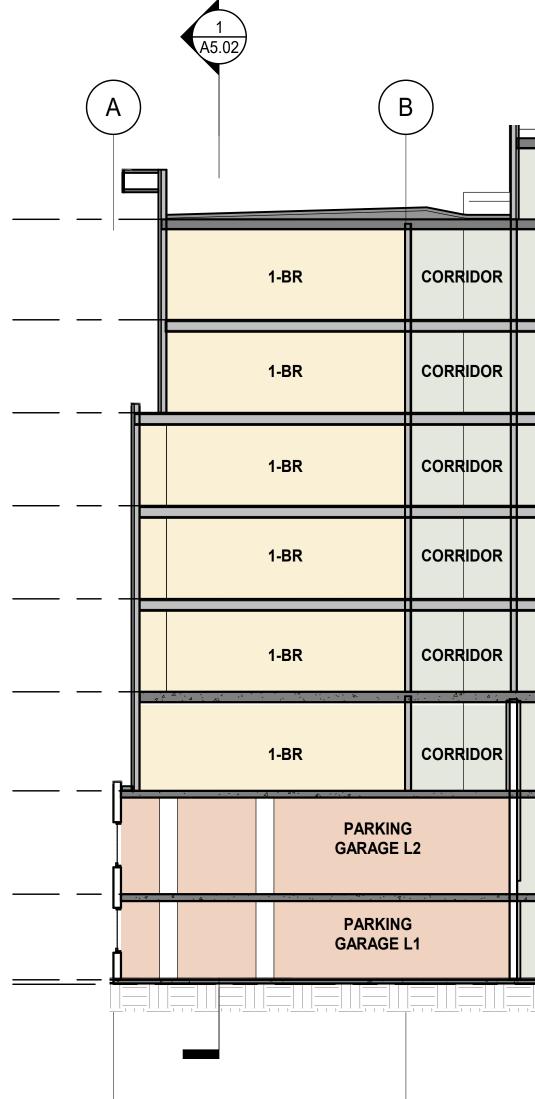
AS SHOWN PROJECT NUMBER 23.301 DESCRIPTION **BUILDING ELEVATIONS**

SHEET NUMBER

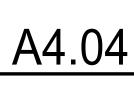

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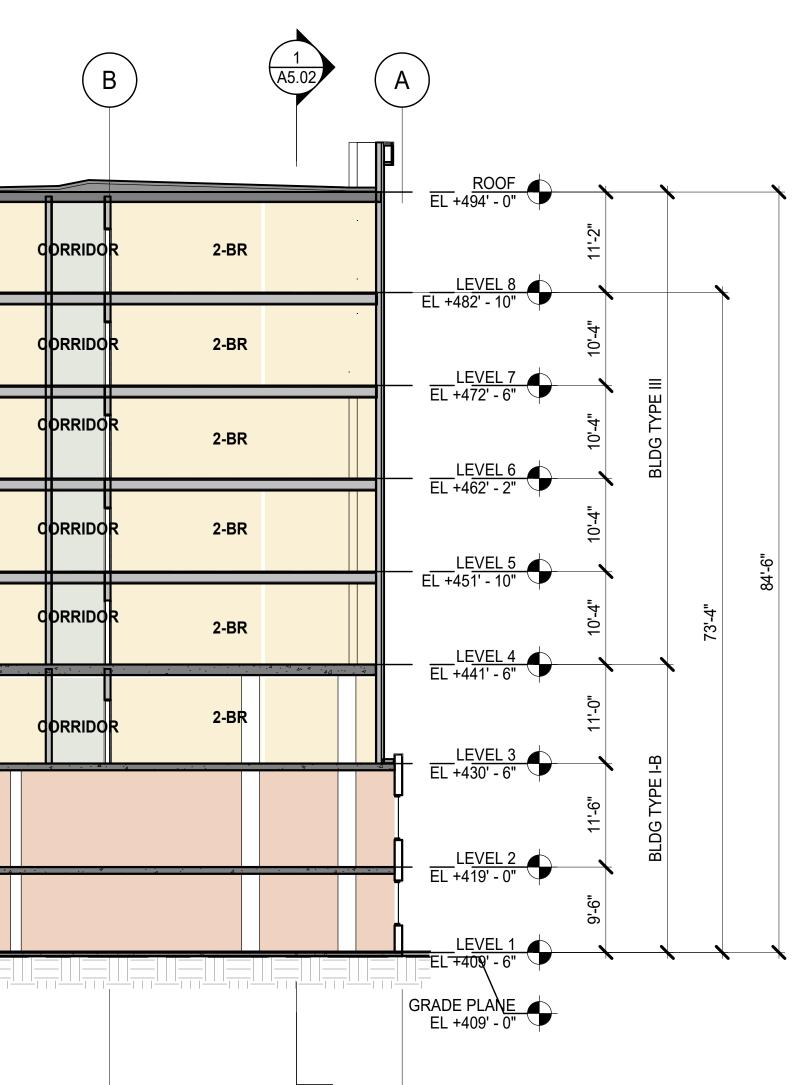


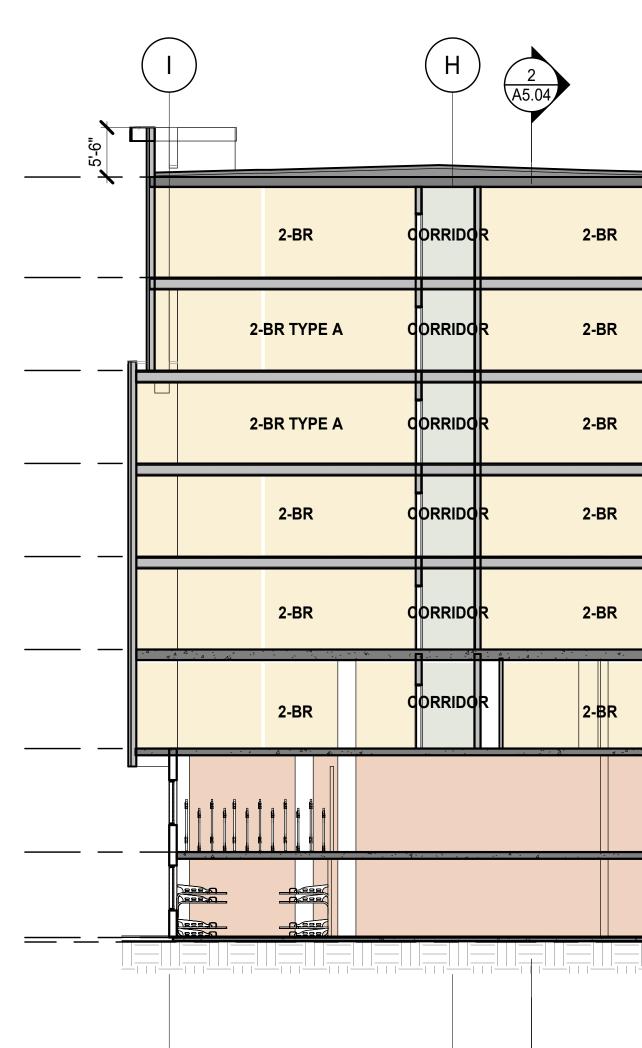

	G F	E	2 A5.02 D	(C
	┃				
R					1-BR
R					1-BR
R					1-BR
R					1-BR
R					1-BR
R		OUTDOOR AMENINTY			1-BR
		PARKII GARAGE	IG		
		PARKII GARAGE	NG E L1		

Section BB SCALE: 3/32" = 1'-0"

ELEV. EQUIP. ROOM C	STAIR 1	2 A5.02 MECH. RM.	E	G	
		2-BR	2-BR	2-BR	
		2-BR	2-BR	2-BR	
		2-BR	2-BR	2-BR	
		2-BR	2-BR	2-BR	E
		2-BR	2-BR	2-BR	E
				2-BR	- E
			FITNESS ROOM		
			PACKAGE	RESIDENTIAL ENTRY LOBBY	




SHEET NOTES

- 1. SEE WINDOW SCHEDULE A0.21 FOR ALL WINDOW SIZES.
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- 7. SEE A9.20 SERIES FOR EXTERIOR WINDOW DETAILS.

KEYNOTES

2⁵⁰

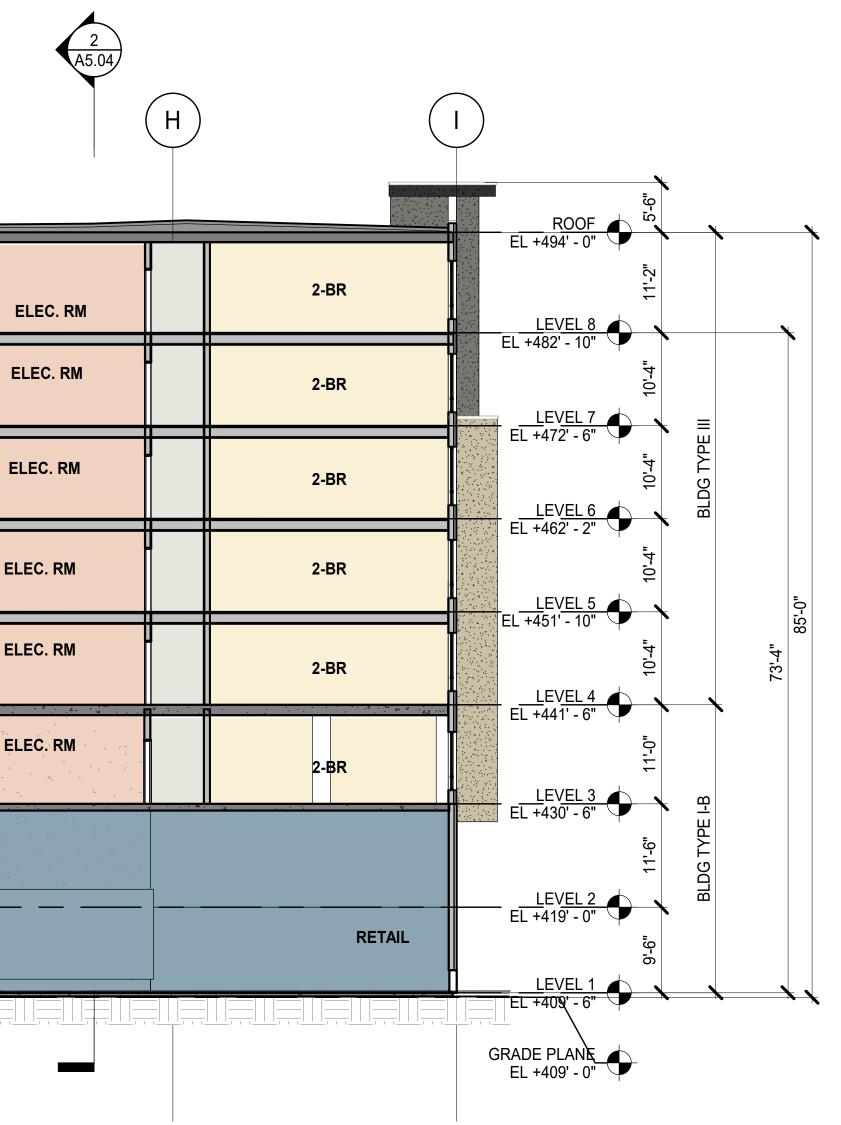



PROJECT NAME

iVista@Alderwood

18799 ALDERWOOD MALL PARKWAY LYNNWOOD, WA 98037

OWNER NAME


ALDERWOOD INVESTMENTS LLC

18799 ALDERWOOD MALL PARKWAY

Part	
	ES & REVISIONS
1 03/31/23 PE	OR SUBMITTAL
SCALE	AS SHOWN
PROJECT NUMBER	23.301
DESCRIPTION BUILDING SECT	IONS
SHEET NUMBER	
A	45.01
ALL DRAWINGS AND WRITTEN MA HEREIN CONSTITUTE ORIGINAL A WORK OF THE DESIGN PROFESS DUPLICATED, USED OR DISCLOSI	ND UNPUBLISHED

CONSENT OF THE DESIGN PROFESSIONAL

	1 A5.01	3 4	A5

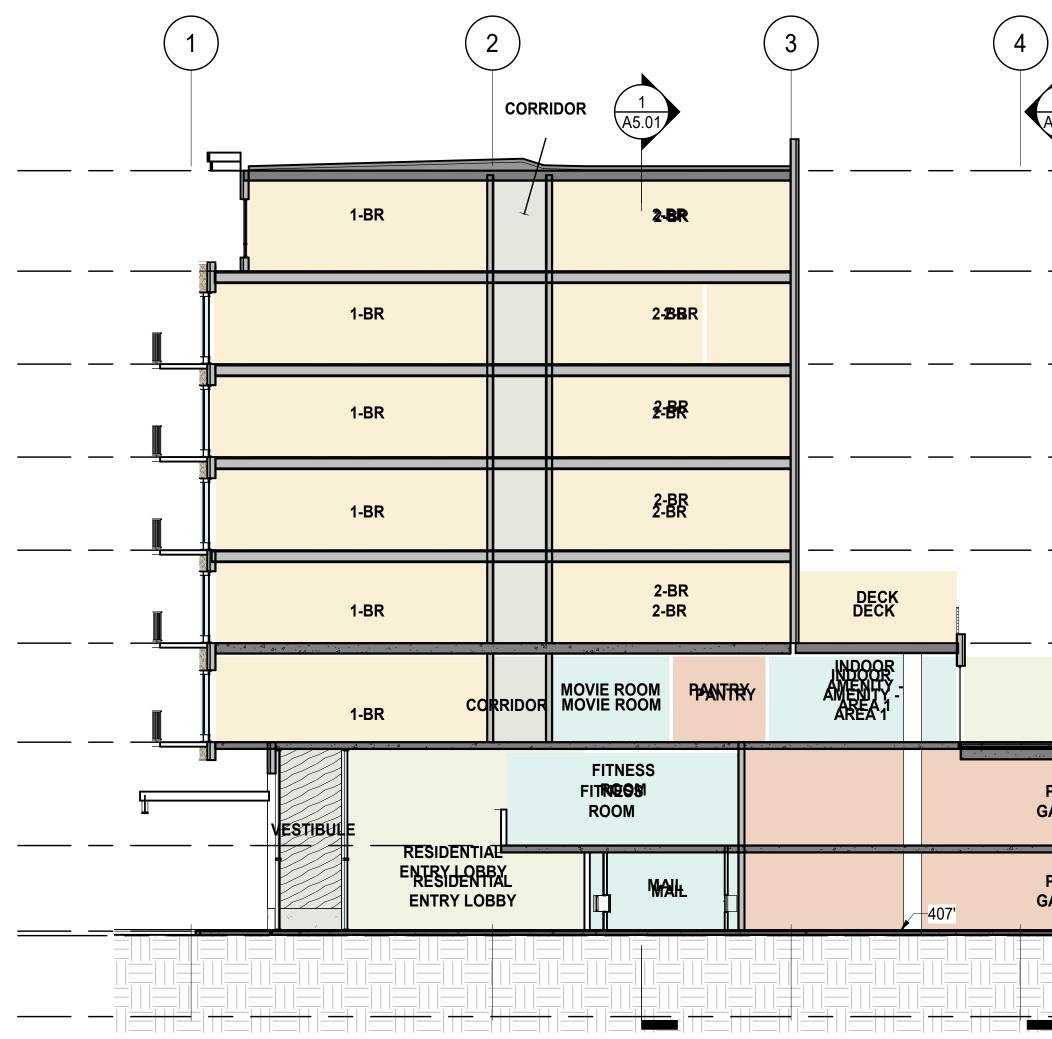


2 A5.01 (4.5) (5)	2 A5.03 A5.03			3) (
		2-BR	1-BR	1-BR
2-BR	2-BR	2-BR	1-BR	1-BR
		2-BR	1-BR	1-BR
2-BR	2-BR	2-BR	1-BR	
2-BR		2-BR	1-BR	
2-BR		2-BR		1-BR
				PARKING GARAGE L2
				PARKING GARAGE L1
		BASEMENT PARKING		

Section 1 SCALE: 3/32" = 1'-0"

) (4.5) (5) (2) (4.5) $(2)(4.5)$ (2) (4.5) (2) (4.5) (2) (4.5) (2) (4.5) (2) (4.5) (2) (4.5) (2) (4.5) (2) (4.5) (2) (4.5)	5.5 1 A5.03	6	7)	8
+ <u>−</u> <u>−</u> <u>−</u> <u>−</u>			2-BR 2-BR	CORRIDOR	2-BR
			2-BR 2-BR		2-BR
			2-BR 2-BR	CORRIDOR	2-BR
			2-BR 2-BR	CORRIDOR	2-BR
			2-BR 2-BR	CORRIDOR	2-BR
OUTDOOR AMENINTY	1-2"	-6	2-BR 2-BR	CORRIDOR	2-BR
PARKING GARAGE L2		<u></u>	50 	ELEC. ROOM	PARKING GARAGE L2
PARKING GARAGE L1			BL	JILDING MAINT.	PARKING GARAGE L1


Section 2 SCALE: 3/32" = 1'-0"

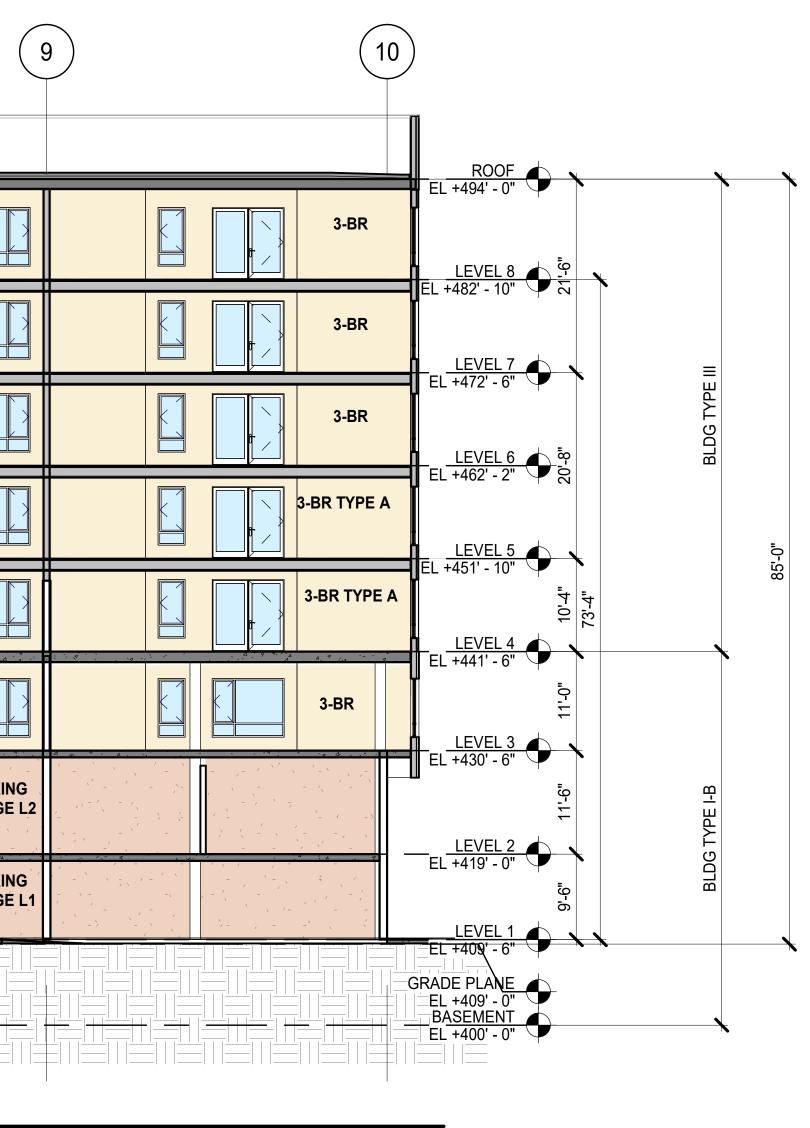

SHEET NOTES

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KEYNOTES

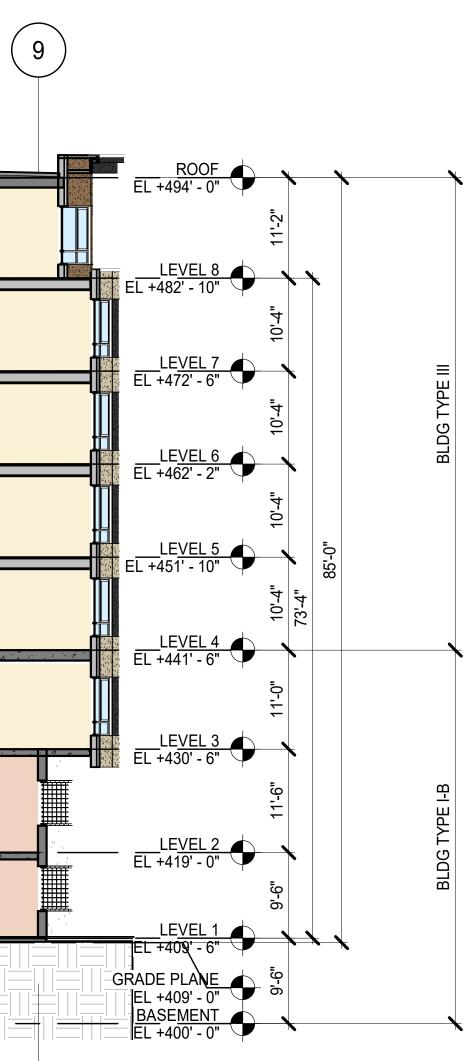

25.02




PROJECT NAME


iVista@Alderwood

18799 ALDERWOOD MALL PARKWAY LYNNWOOD, WA 98037

OWNER NAME

ALDERWOOD INVESTMENTS LLC

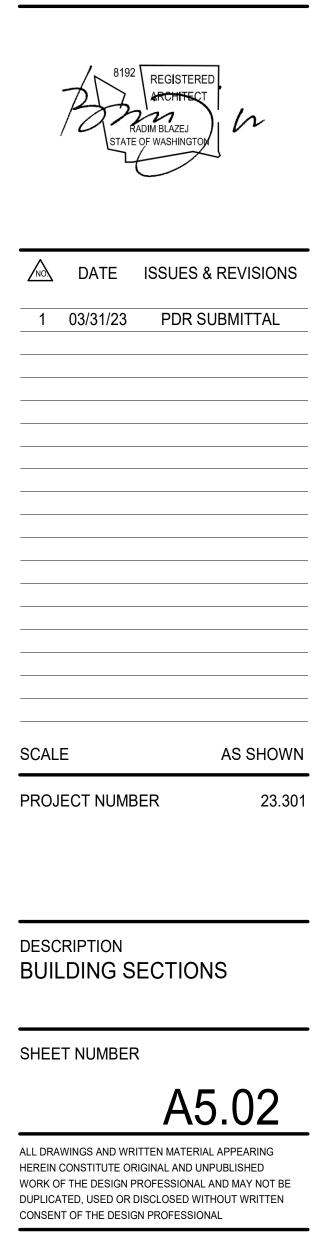

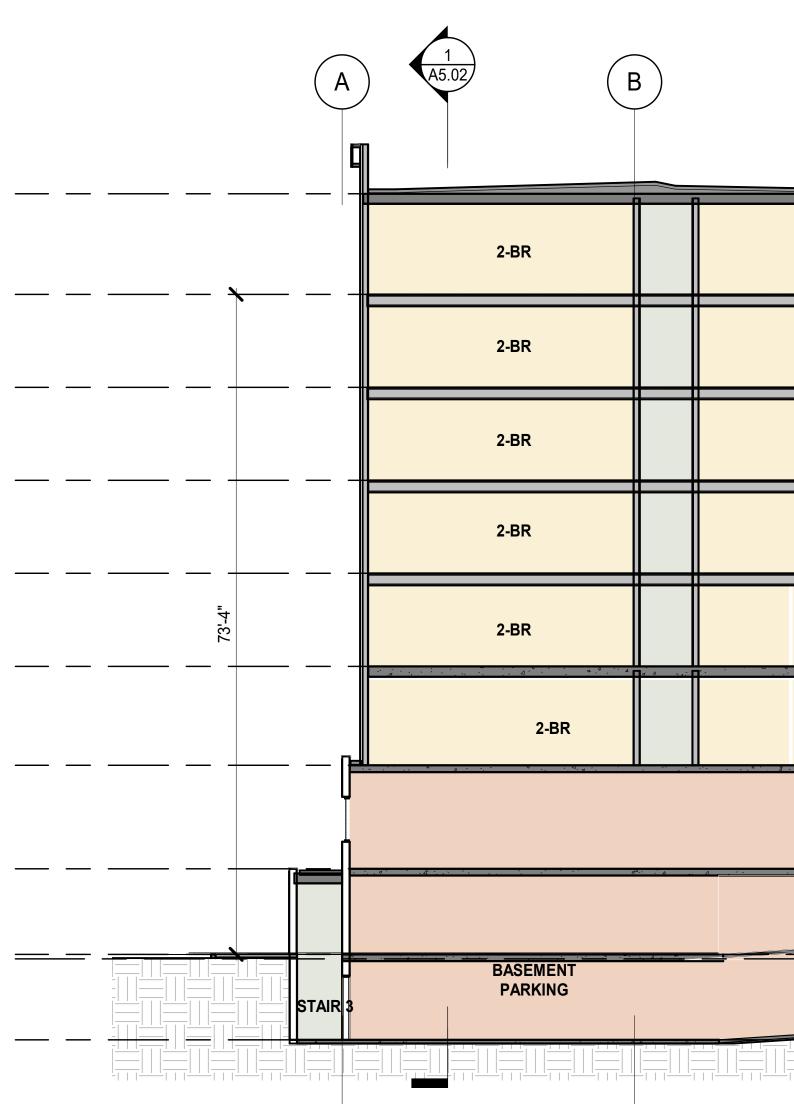

	1	E	3)	
	2-BR			
 ~ 4 × * * * * *	2-BR	نې خون نو خون		
	2-BR			
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1-BR	₩ ┃ ♪ ♪		1-BR	1-BR W DEN
1-BR	₩ ┃ ۩			1-BR W DEN
1-BR	u 		1-BR	1-BR W DEN
1-BR	OUTDO AMENI		1-BR	1-BR W DEN
7'-7 3/8"	6.61%			
	6.59%			

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		-


	(C) D A 5.02 E F G	
1-BR		1-BR W D TYPE A
1-BR		1-BR W D TYPE A
1-BR		1-BR W D
1-BR		1-BR W D
1-BR		1-BR W D
1-BR	OUTDOOR AMENINTY	1-BR W D
<u>, , , , , , , , , , , , , , , , , , , </u>	PARKING GARAGE L2	
	PARKING GARAGE L1	

. $\begin{pmatrix} 2\\ A5.04 \end{pmatrix}$ ■ <u>ROOF</u> EL +494' - 0")EN LEVEL 8 EL +482' - 10" DEN 1-BR LEVEL 7 . +472' - 6")EN LEVEL 6 +462' - 2")EN LEVEL 5 +451' - 10" DEN **d**ORRIDO LEVEL 4 - +441' - 6" DEN dorriddr 1-BR EL +430' - 6" ш LEVEL 2 EL +419' - 0" EL +409' - 6" GRADE PLANE EL +409' - 0" $\frac{1}{-1} + \frac{1}{1} + \frac{1$ **9**8

Section DD SCALE: 3/32" = 1'-0"

SHEET NOTES

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KEYNOTES

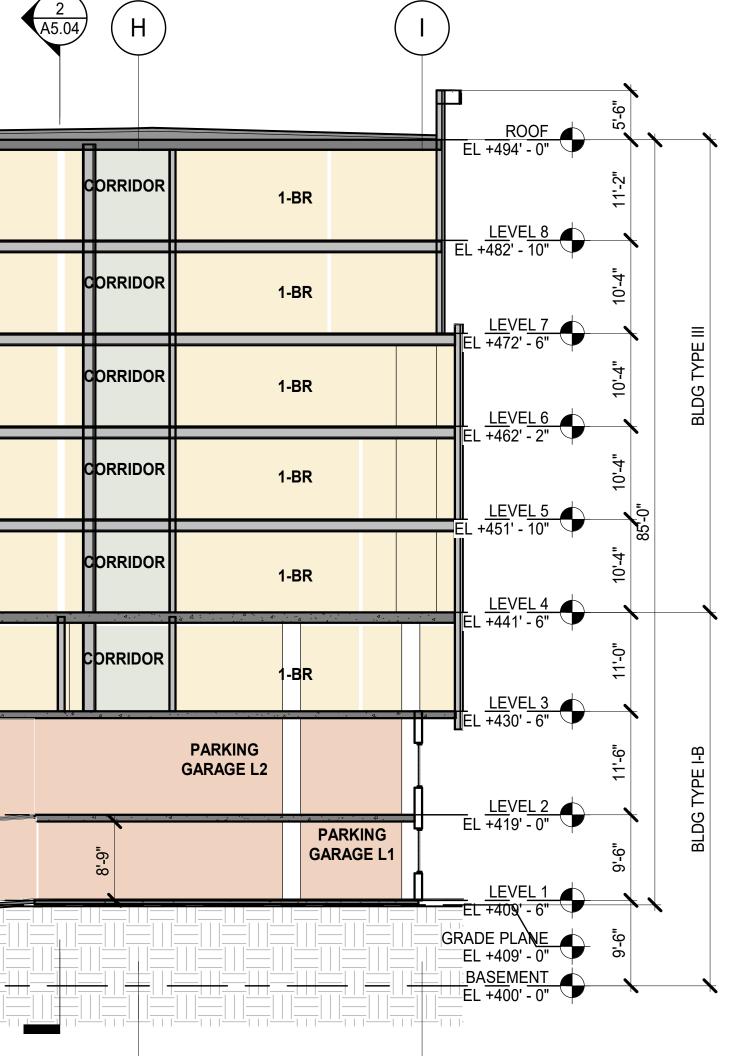Section CC SCALE: 3/32" = 1'-0"

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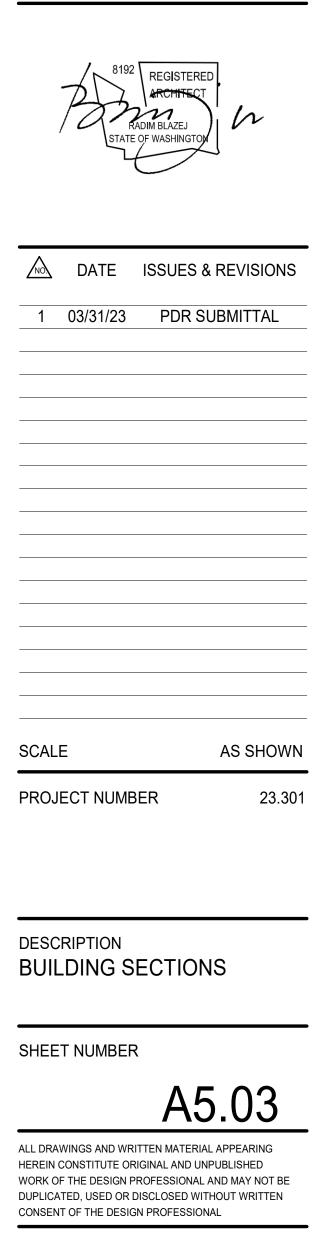
PROJECT NAME

iVista@Alderwood


18799 ALDERWOOD MALL PARKWAY LYNNWOOD, WA 98037

OWNER NAME

ALDERWOOD **INVESTMENTS LLC**





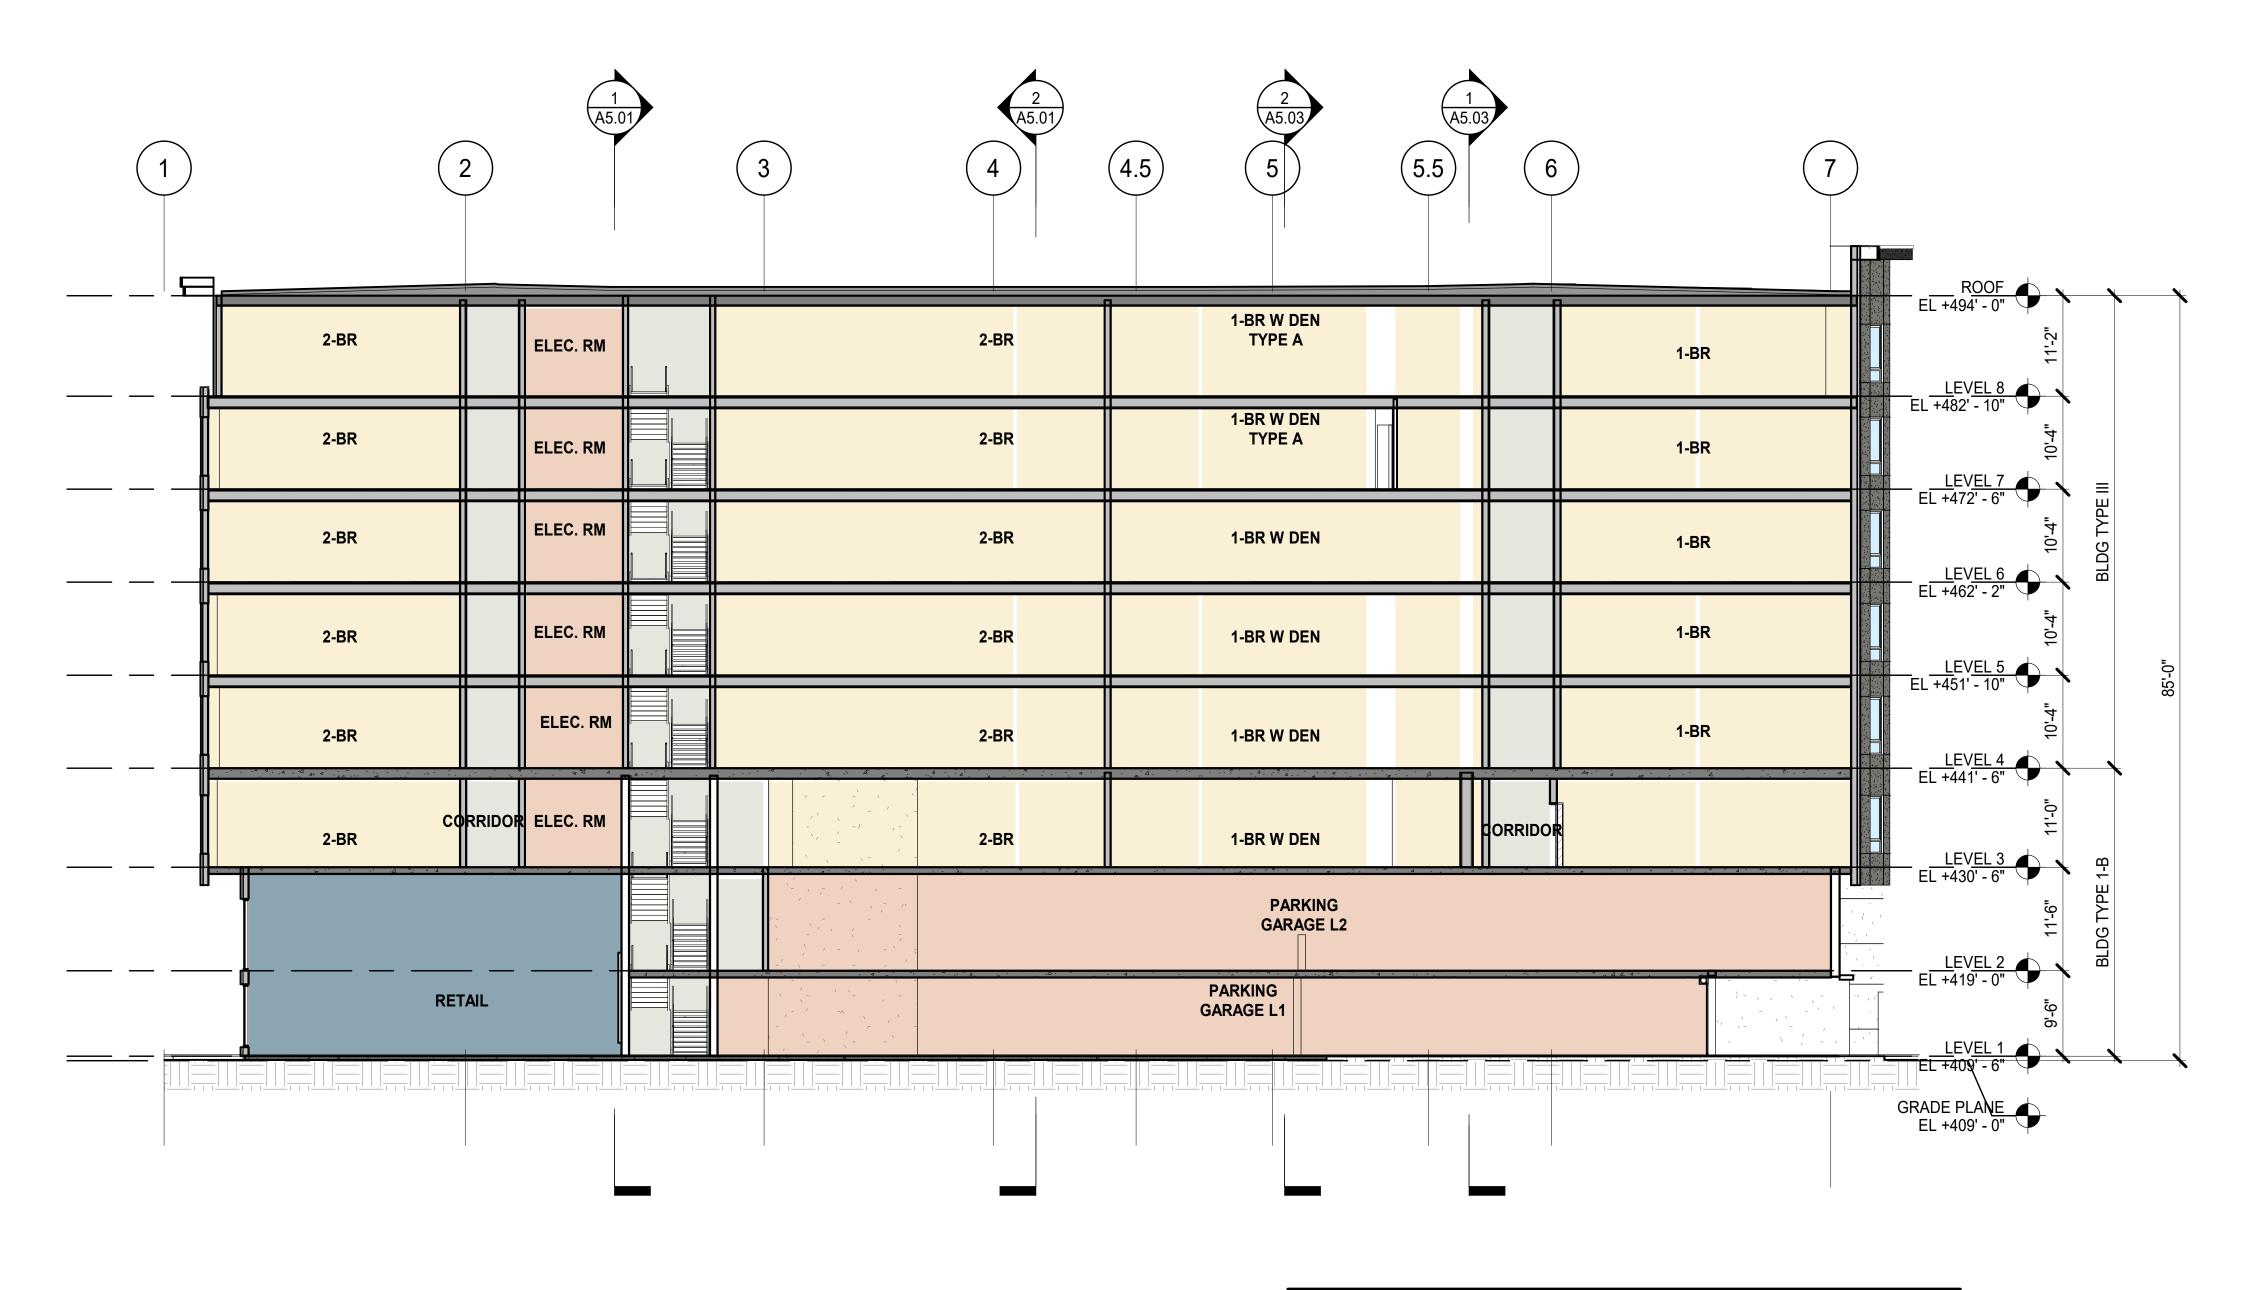

Section EE SCALE: 3/32" = 1'-0"

Section 3 SCALE: 3/32" = 1'-0"

SHEET NOTES

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KEYNOTES

35.04




PROJECT NAME


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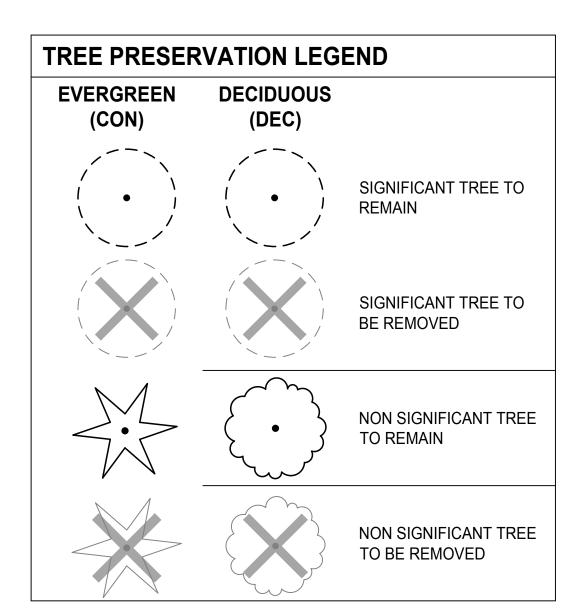
OWNER NAME

ALDERWOOD INVESTMENTS LLC



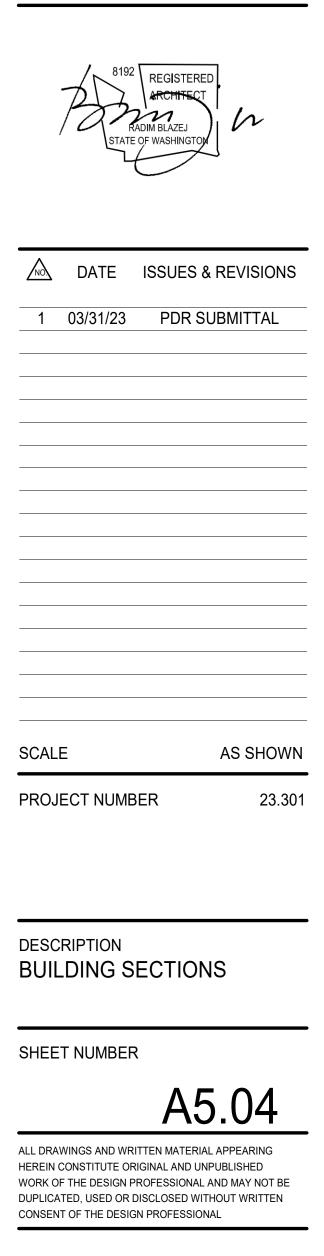

()

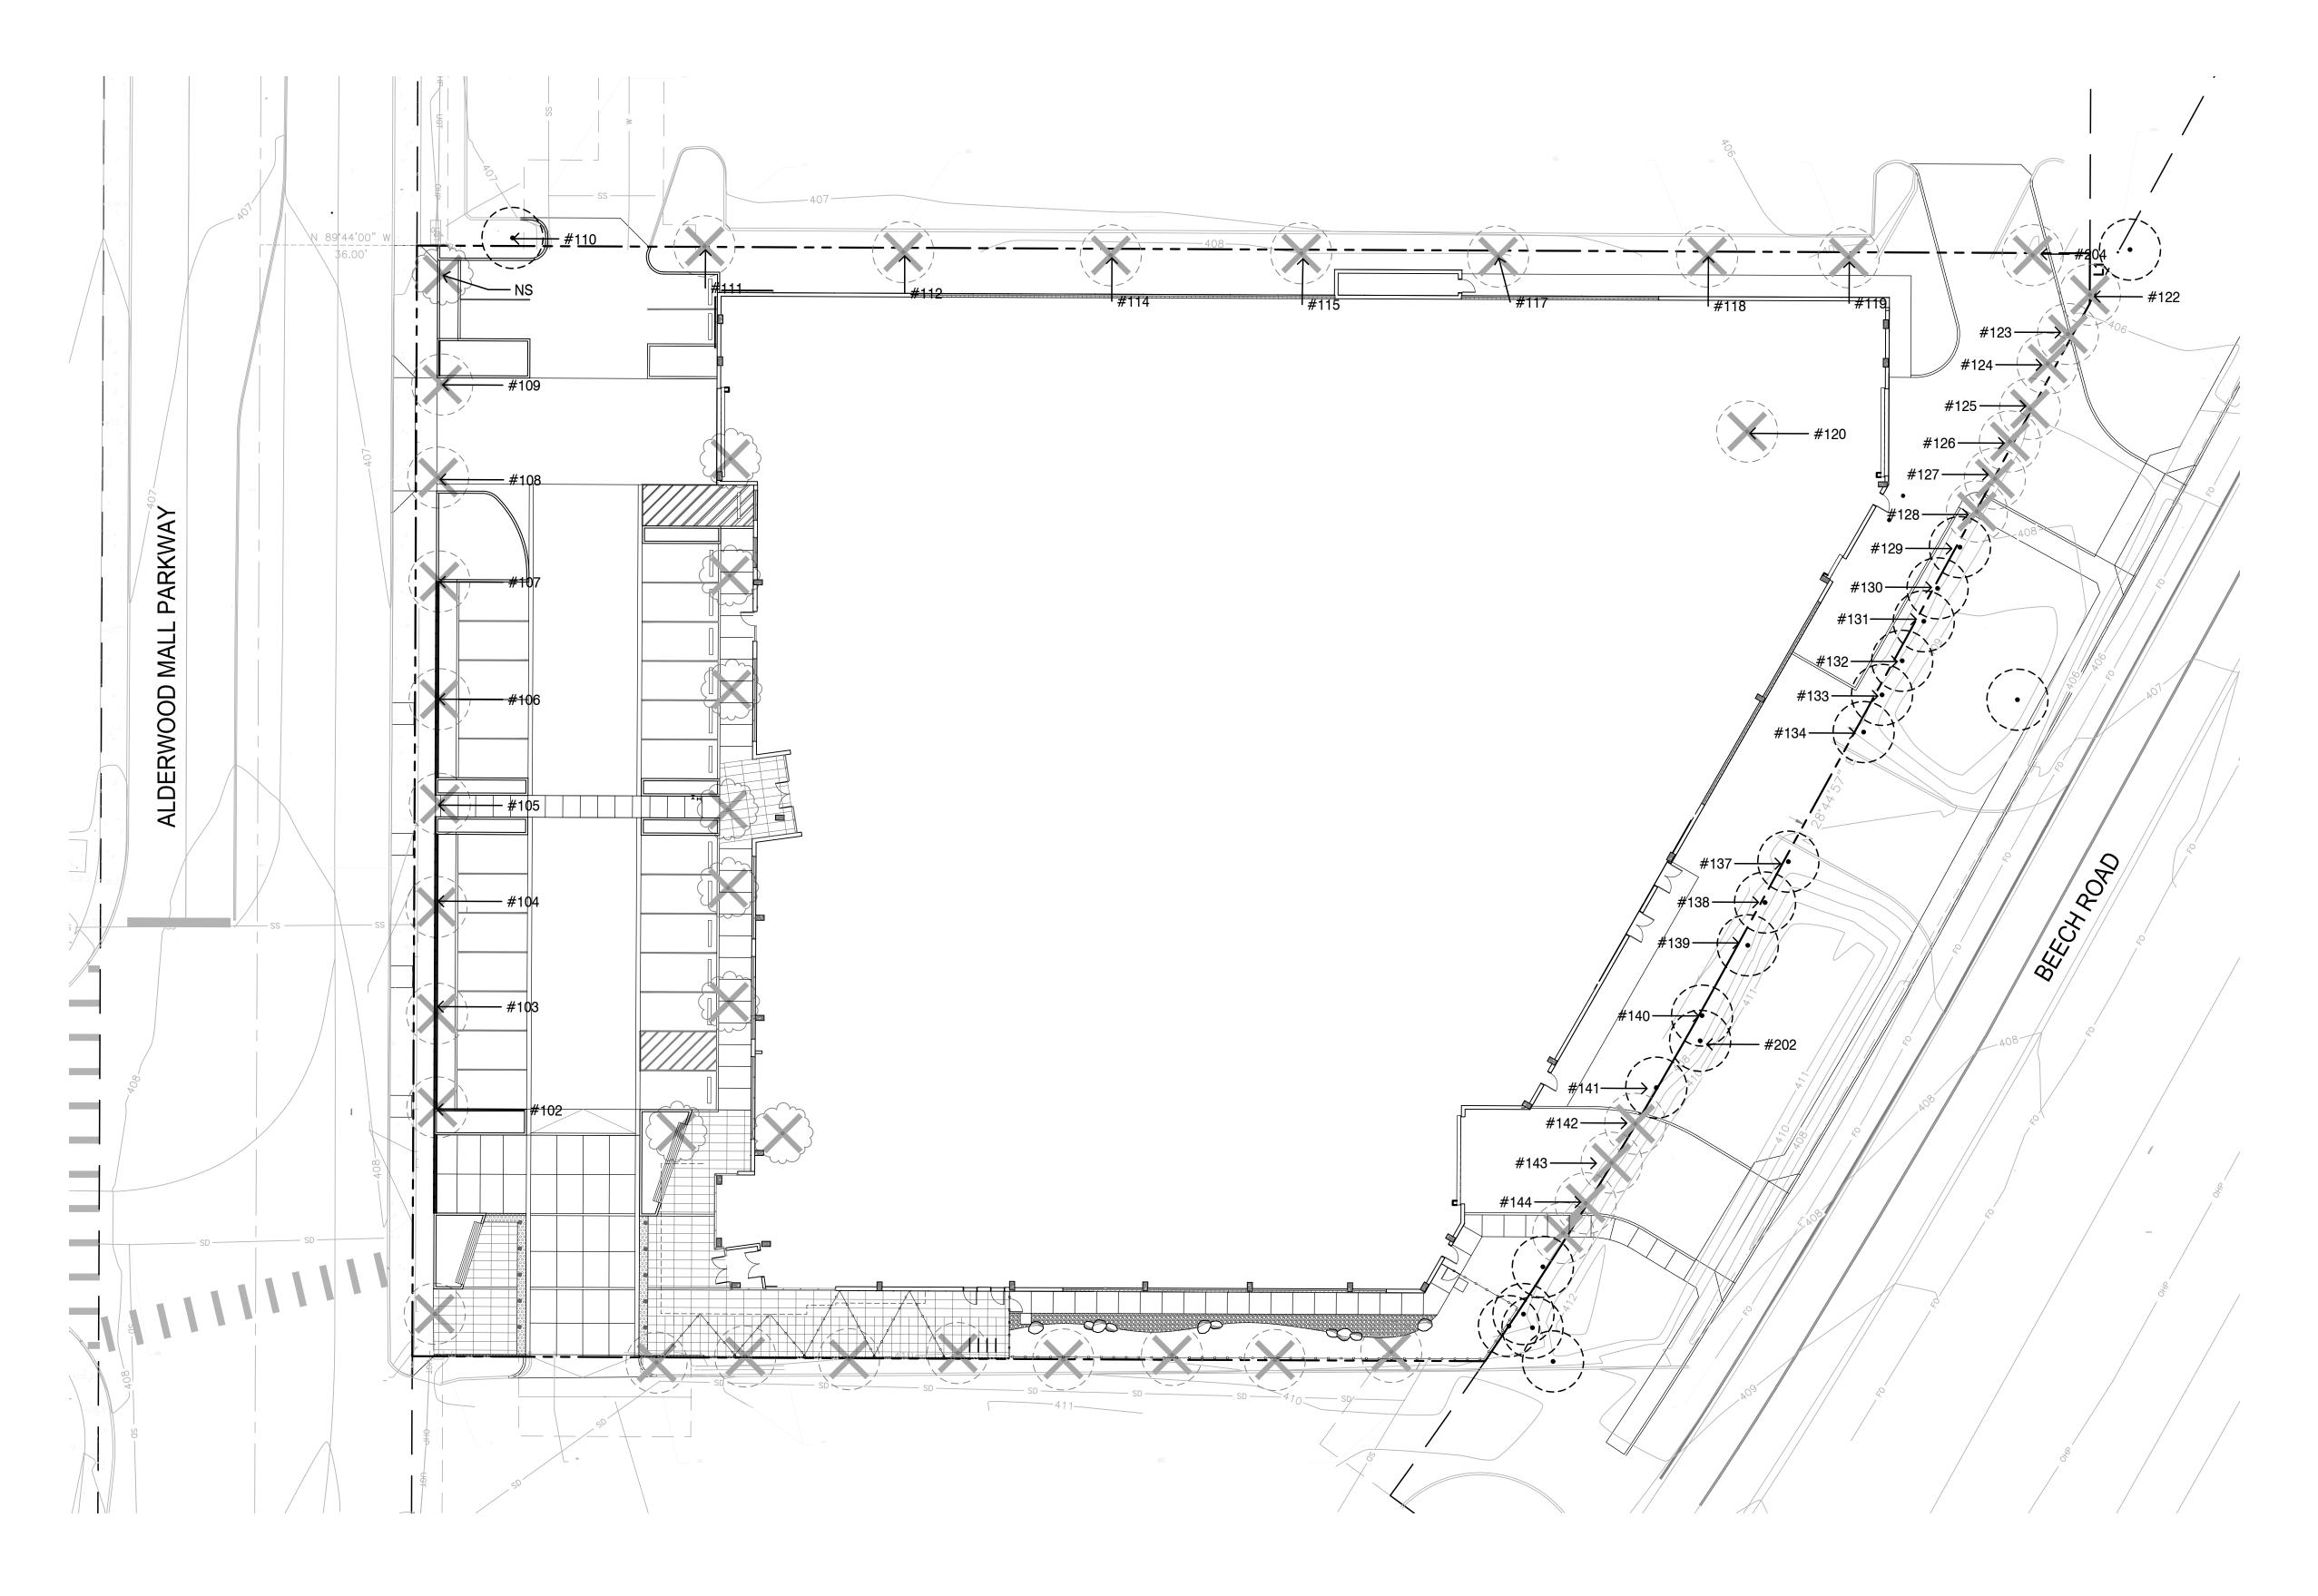

DATA FROM ARBORIST REPORT

133	SCOTCH PINE, 10"
134	SCOTCH PINE, 12"
135	MAPLE, 6"
136	MAPLE, 14"
137	SCOTCH PINE, 13"
138	SCOTCH PINE, 10"
139	SCOTCH PINE, 14"
140	SCOTCH PINE, 12"
141	SCOTCH PINE, 12"
142	SCOTCH PINE, 12"
143	SCOTCH PINE, 12"
144	DOUGLAS FIR, 11"
145	DOUGLAS FIR, 14"
146	DOUGLAS FIR, 14"
147	DOUGLAS FIR, 12"
148	DOUGLAS FIR, 15"
149	MAPLE, 6"
150	MAPLE, 6"
151	MAPLE, 7"
152	MAPLE, 9"
153	MAPLE, 9"
154	MAPLE, 7"
155	MAPLE, 7"
156	MAPLE, 8"
157	MAPLE, 8"
201	MAPLE, 7,6,6,4"
202	DOUGLAS FIR 11"

202 DOUGLAS FIR, 11"203 WESTERN WHITE PINE, 15"204 MAPLE, 8"

PROJECT NAME


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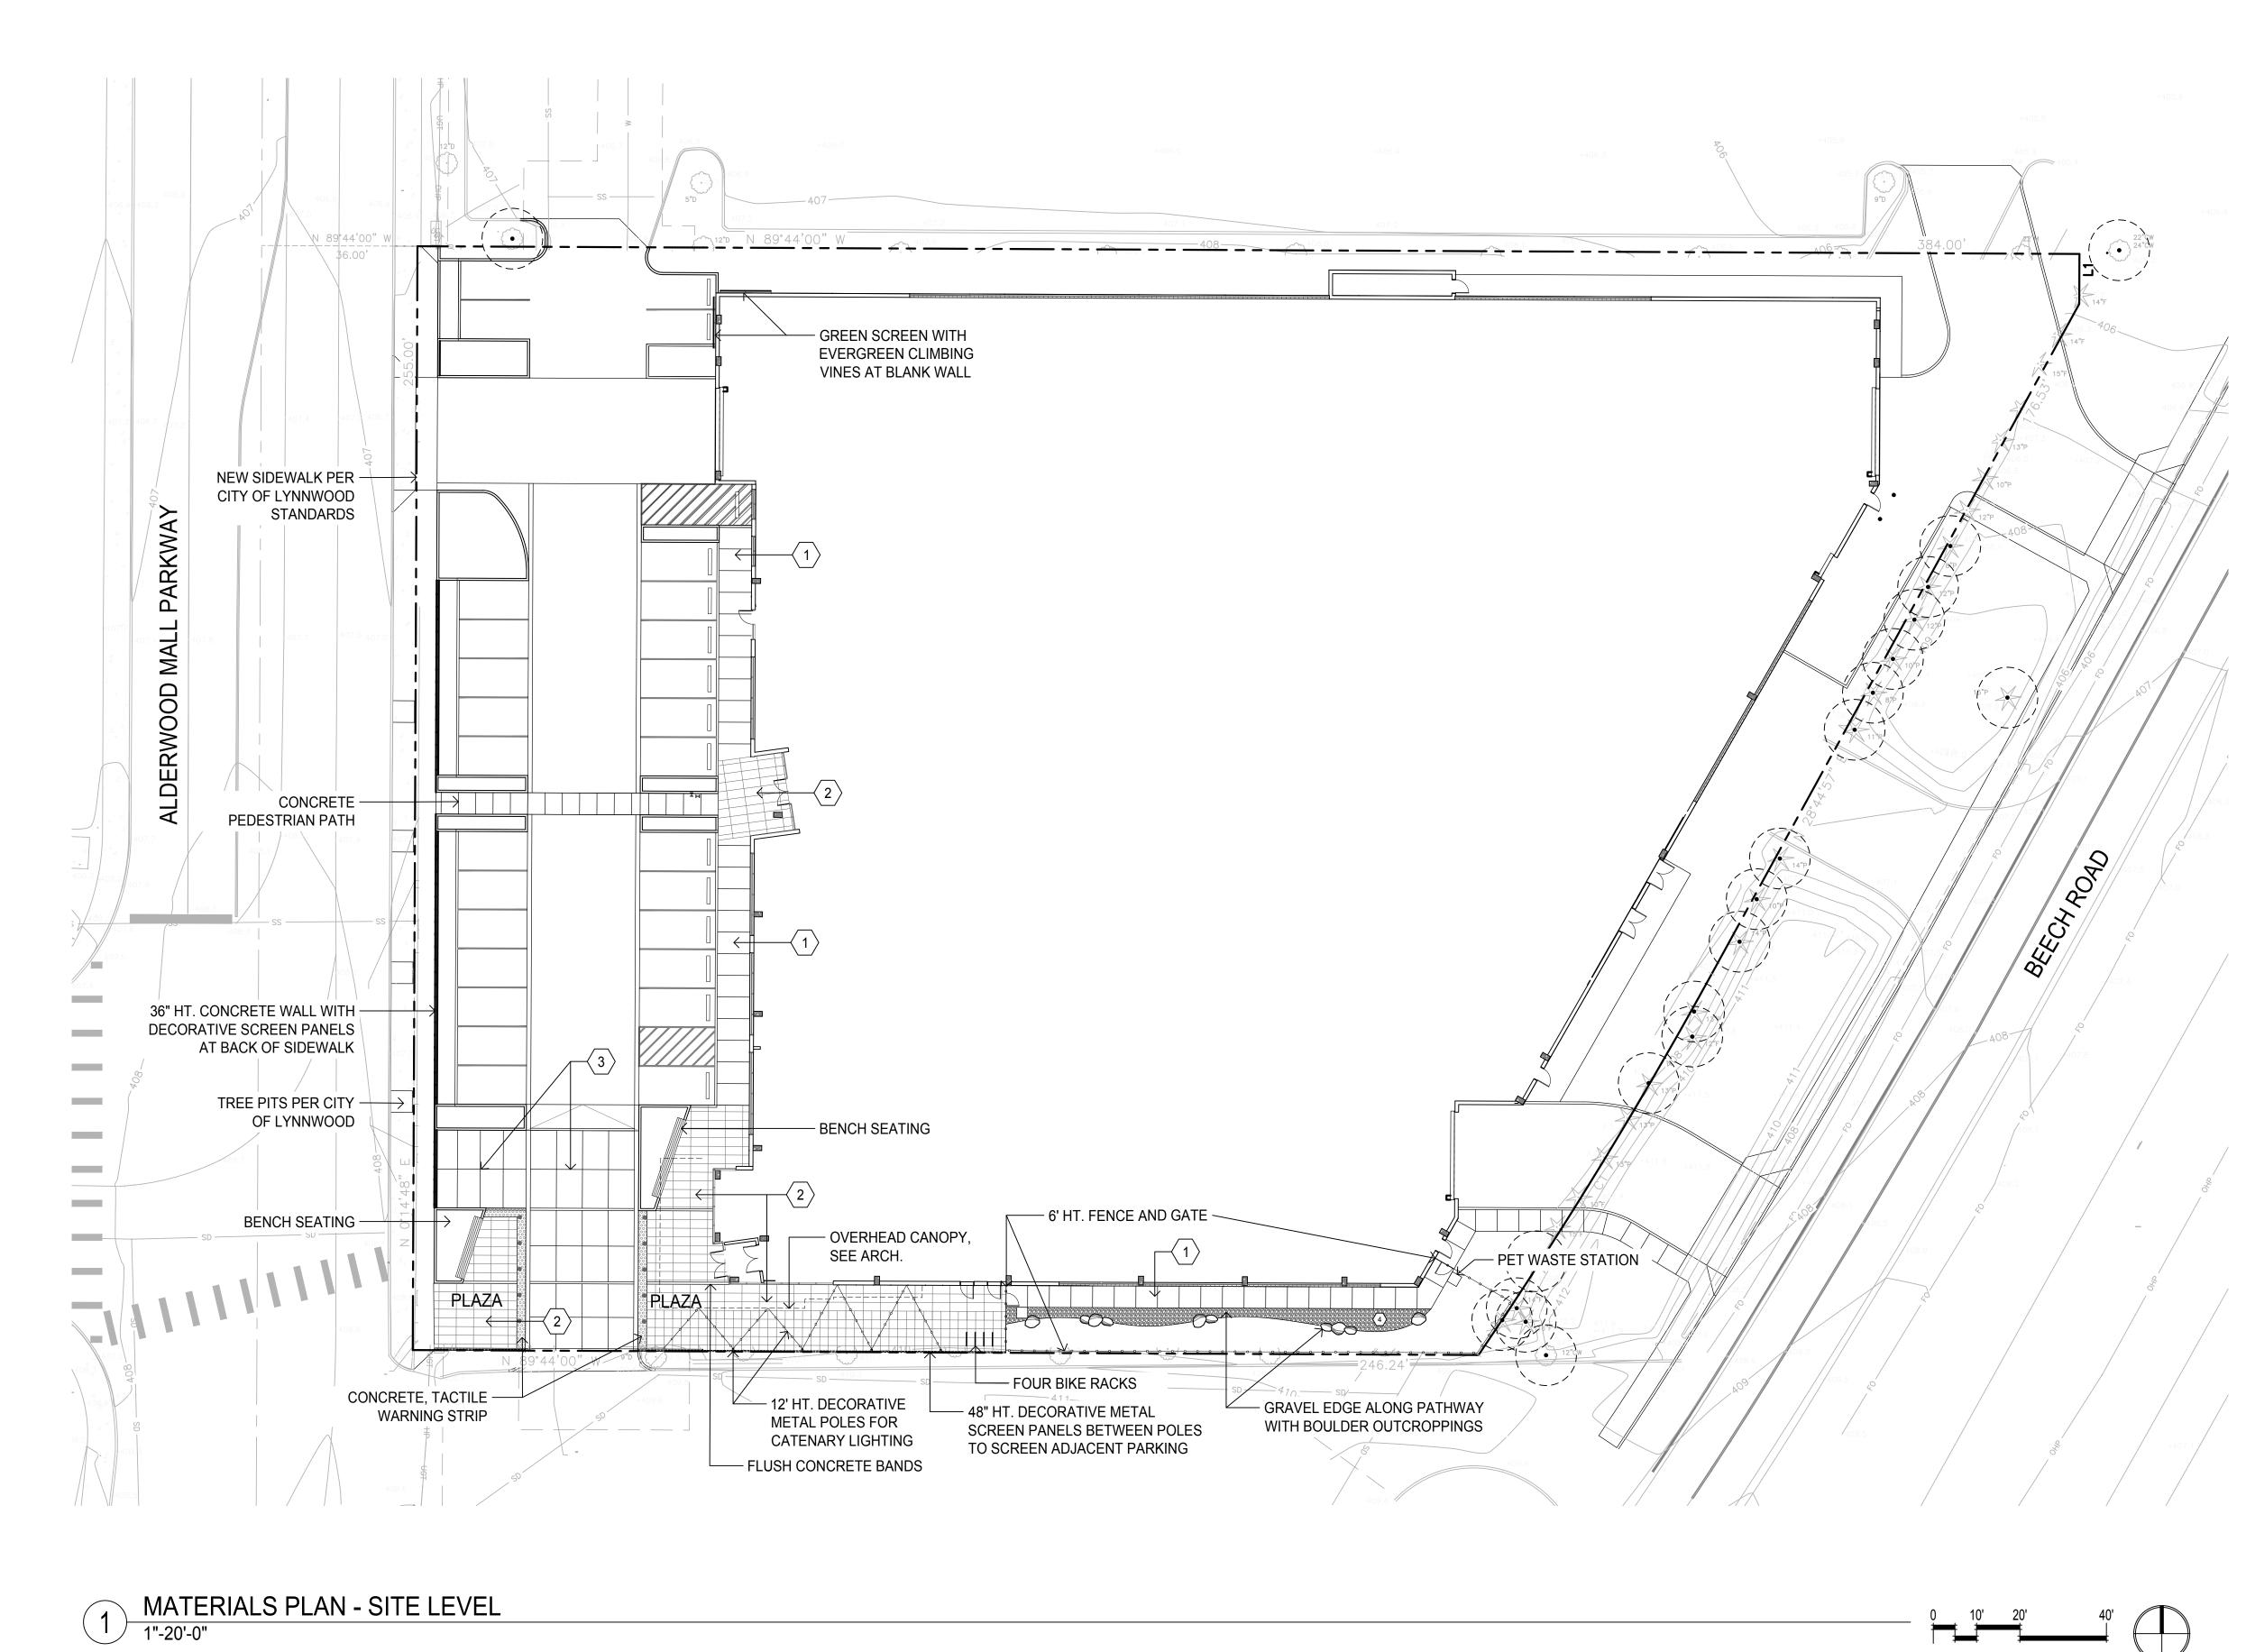
OWNER NAME

ALDERWOOD INVESTMENTS LLC

18799 ALDERWOOD MALL PARKWAY



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SCALE	AS SHOWN
PROJECT NUMBER	2023-02iVISTA
DESCRIPTION	
	RVATION PLAN
SHEET NUMBER	
SHEET NOWBER	
	L1.01
ALL DRAWINGS AND WRITTE HEREIN CONSTITUTE ORIGIN	
WORK OF THE DESIGN PROF DUPLICATED, USED OR DISC	ESSIONAL AND MAY NOT BE
CONSENT OF THE DESIGN PI	

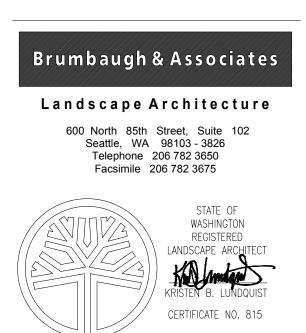

PAVING / M	ATERI	ALS LEGEND - SITE LEVEL
SYMBOL	QTY	DESCRIPTION
		C.I.P. CONCRETE PAVING - NATURAL, SAWCUT JOINTS
2		C.I.P. CONCRETE ACCENT PAVING, CADMAN TOPCAST 30 WITH DARK GRAY INTEGRAL COLOR, SAWCUT OR TOOLED JOINTS.
3		CONCRETE PAVING WITH DARK GRAY INTEGRAL COLOR, BROOM FINISH
4		GRAVEL: 1" WASHED RIVER ROCK, 4" DEPTH, PERFORATED ALUMINUM EDGING
٠	10	BOLLARD, SEE LIGHTING PLANS
IIII	4	BIKE RACK, STAINLESS STEEL ARC BY HUNTCO
	2	BENCH, MONOLINE BENCH TOPPER BY SITE PIECES
	2	PET WASTE STATION
		CATENARY LIGHTING - SEE LIGHTING DRAWINGS

PROJECT NAME


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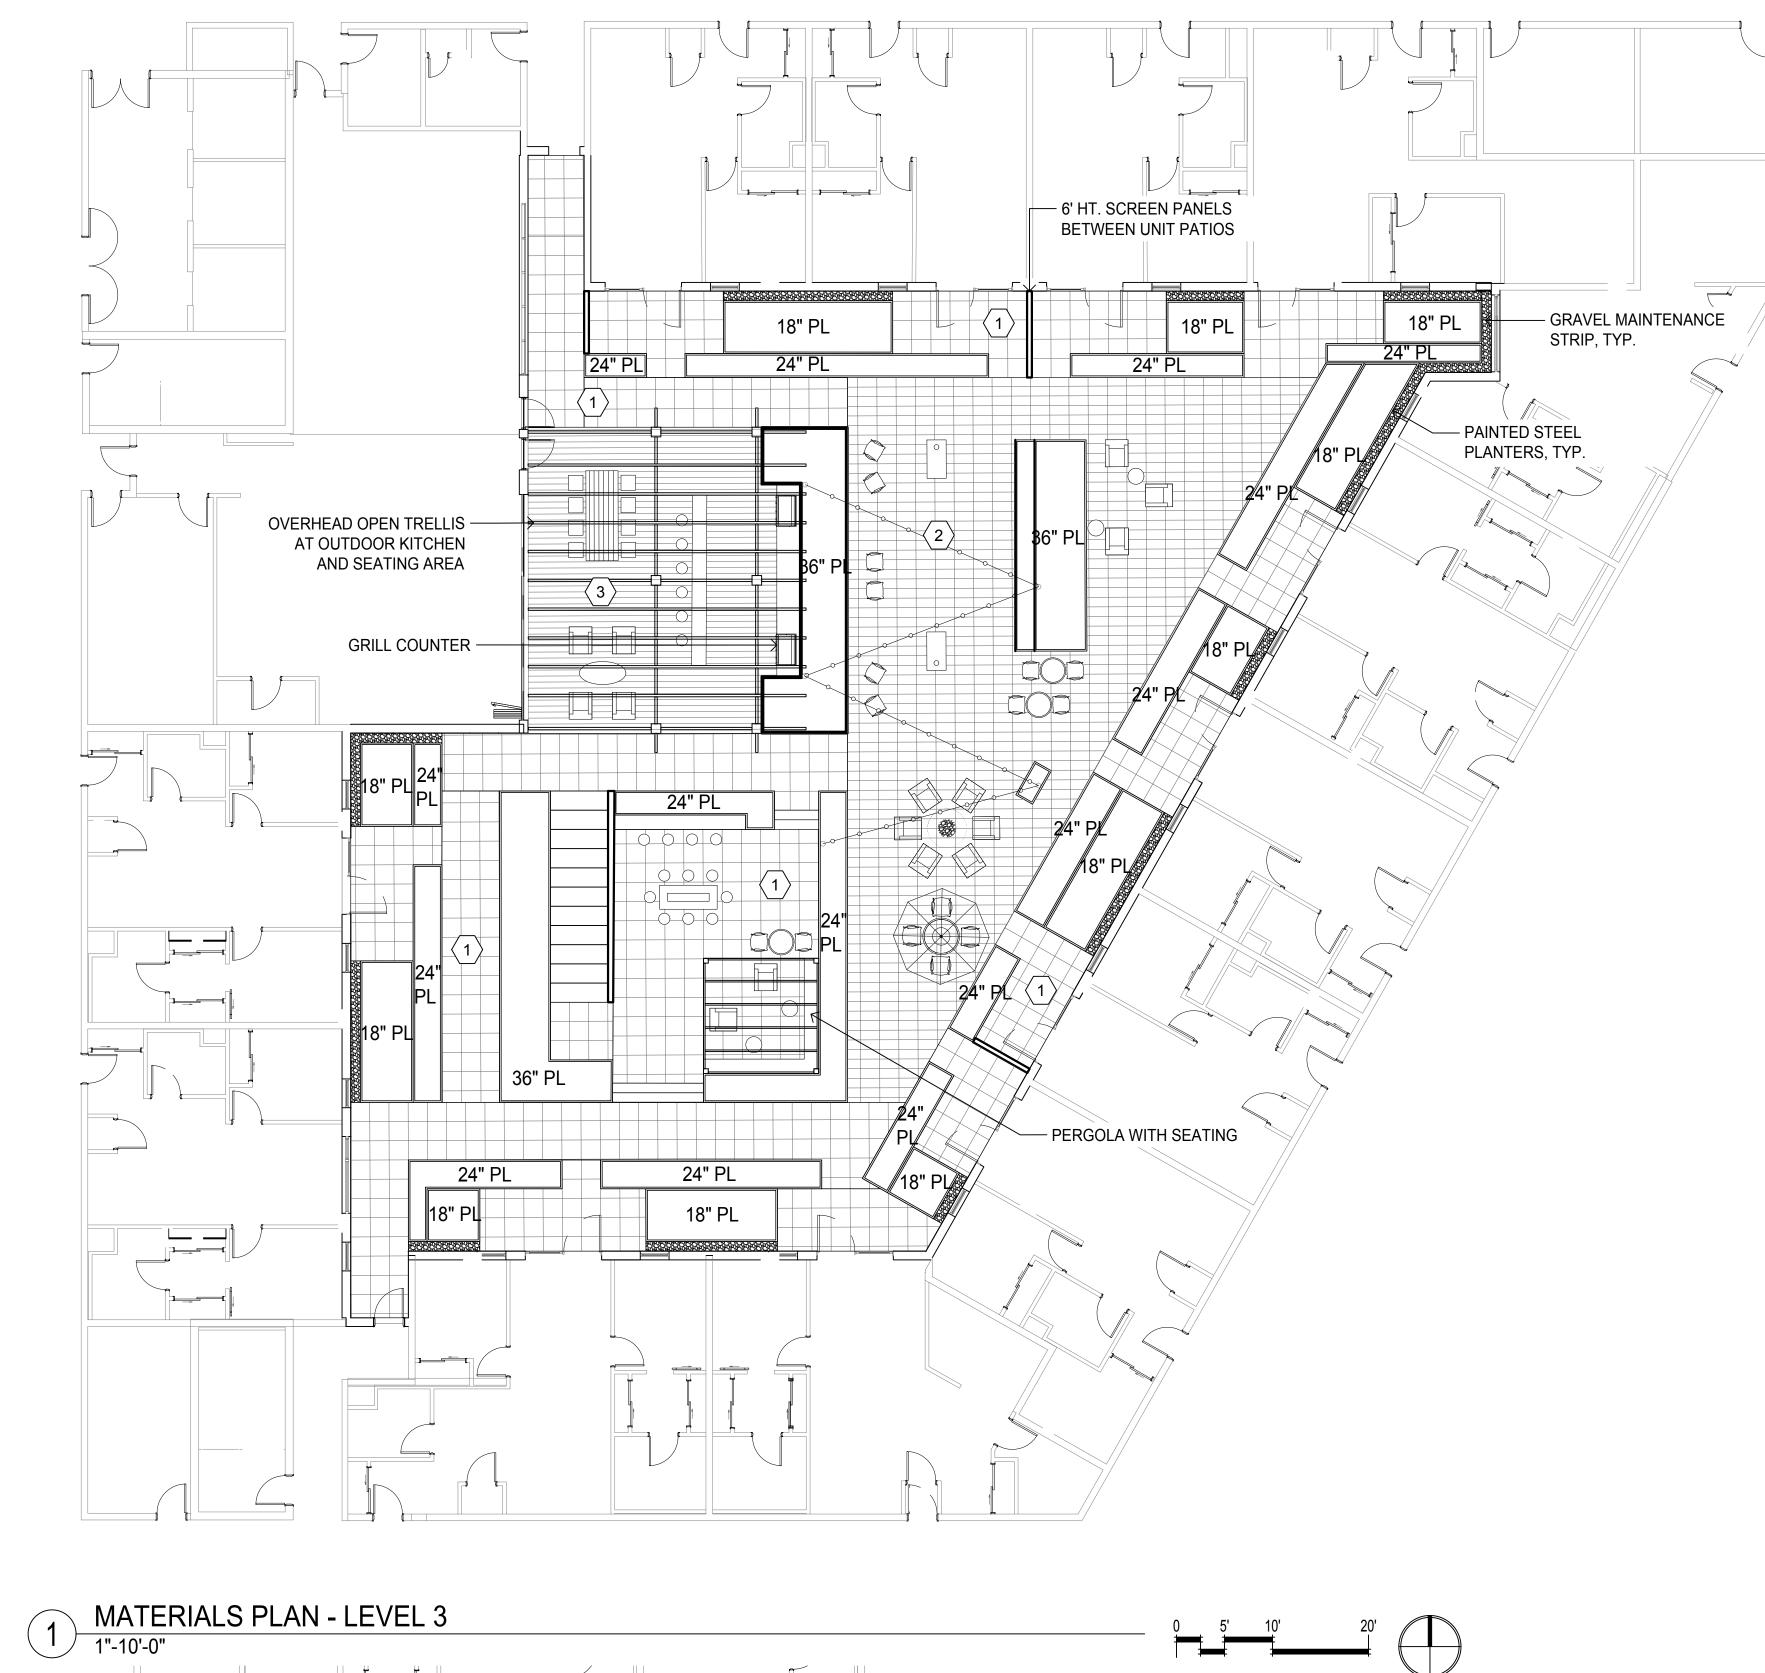
ALDERWOOD INVESTMENTS LLC

18799 ALDERWOOD MALL PARKWAY




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SCALE	AS SHOWN
PROJECT NUMBER	2023-02iVISTA
DESCRIPTION MATERIALS PLAN SITE LEVEL	N -
SHEET NUMBER	
L	3.01
ALL DRAWINGS AND WRITTEN MAT HEREIN CONSTITUTE ORIGINAL AN WORK OF THE DESIGN PROFESSIC DUPLICATED, USED OR DISCLOSEI	ID UNPUBLISHED NAL AND MAY NOT BE

CONSENT OF THE DESIGN PROFESSIONAL

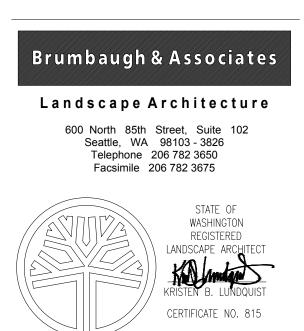



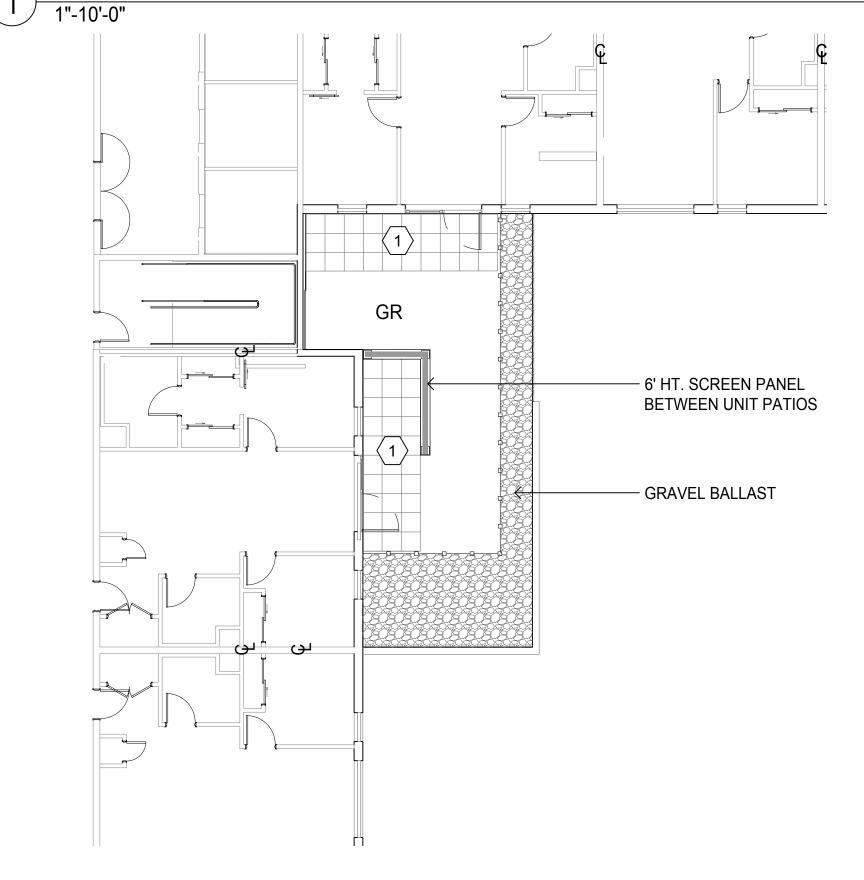

0 5' 10'

(|)

2 MATERIALS PLAN - LEVEL 4

PAVING / M	ATERIALS LEGEND - LEVEL 3
SYMBOL	DESCRIPTION
	24" x 24" MODULAR CONCRETE PAVER, PEDESTAL SET
	12" x 24" MODULAR CONCRETE PAVER, PEDESTAL SET
3	WOOD DECKING BY THERMORY, JOIST SYSTEM ON PEDESTALS
	OUTDOOR BBQ GRILL
۲	FIRE PIT
	FIRE TABLE
XX" PL	STEEL PLANTER WITH HEIGHT INDICATED
GR	GREEN ROOF

PROJECT NAME


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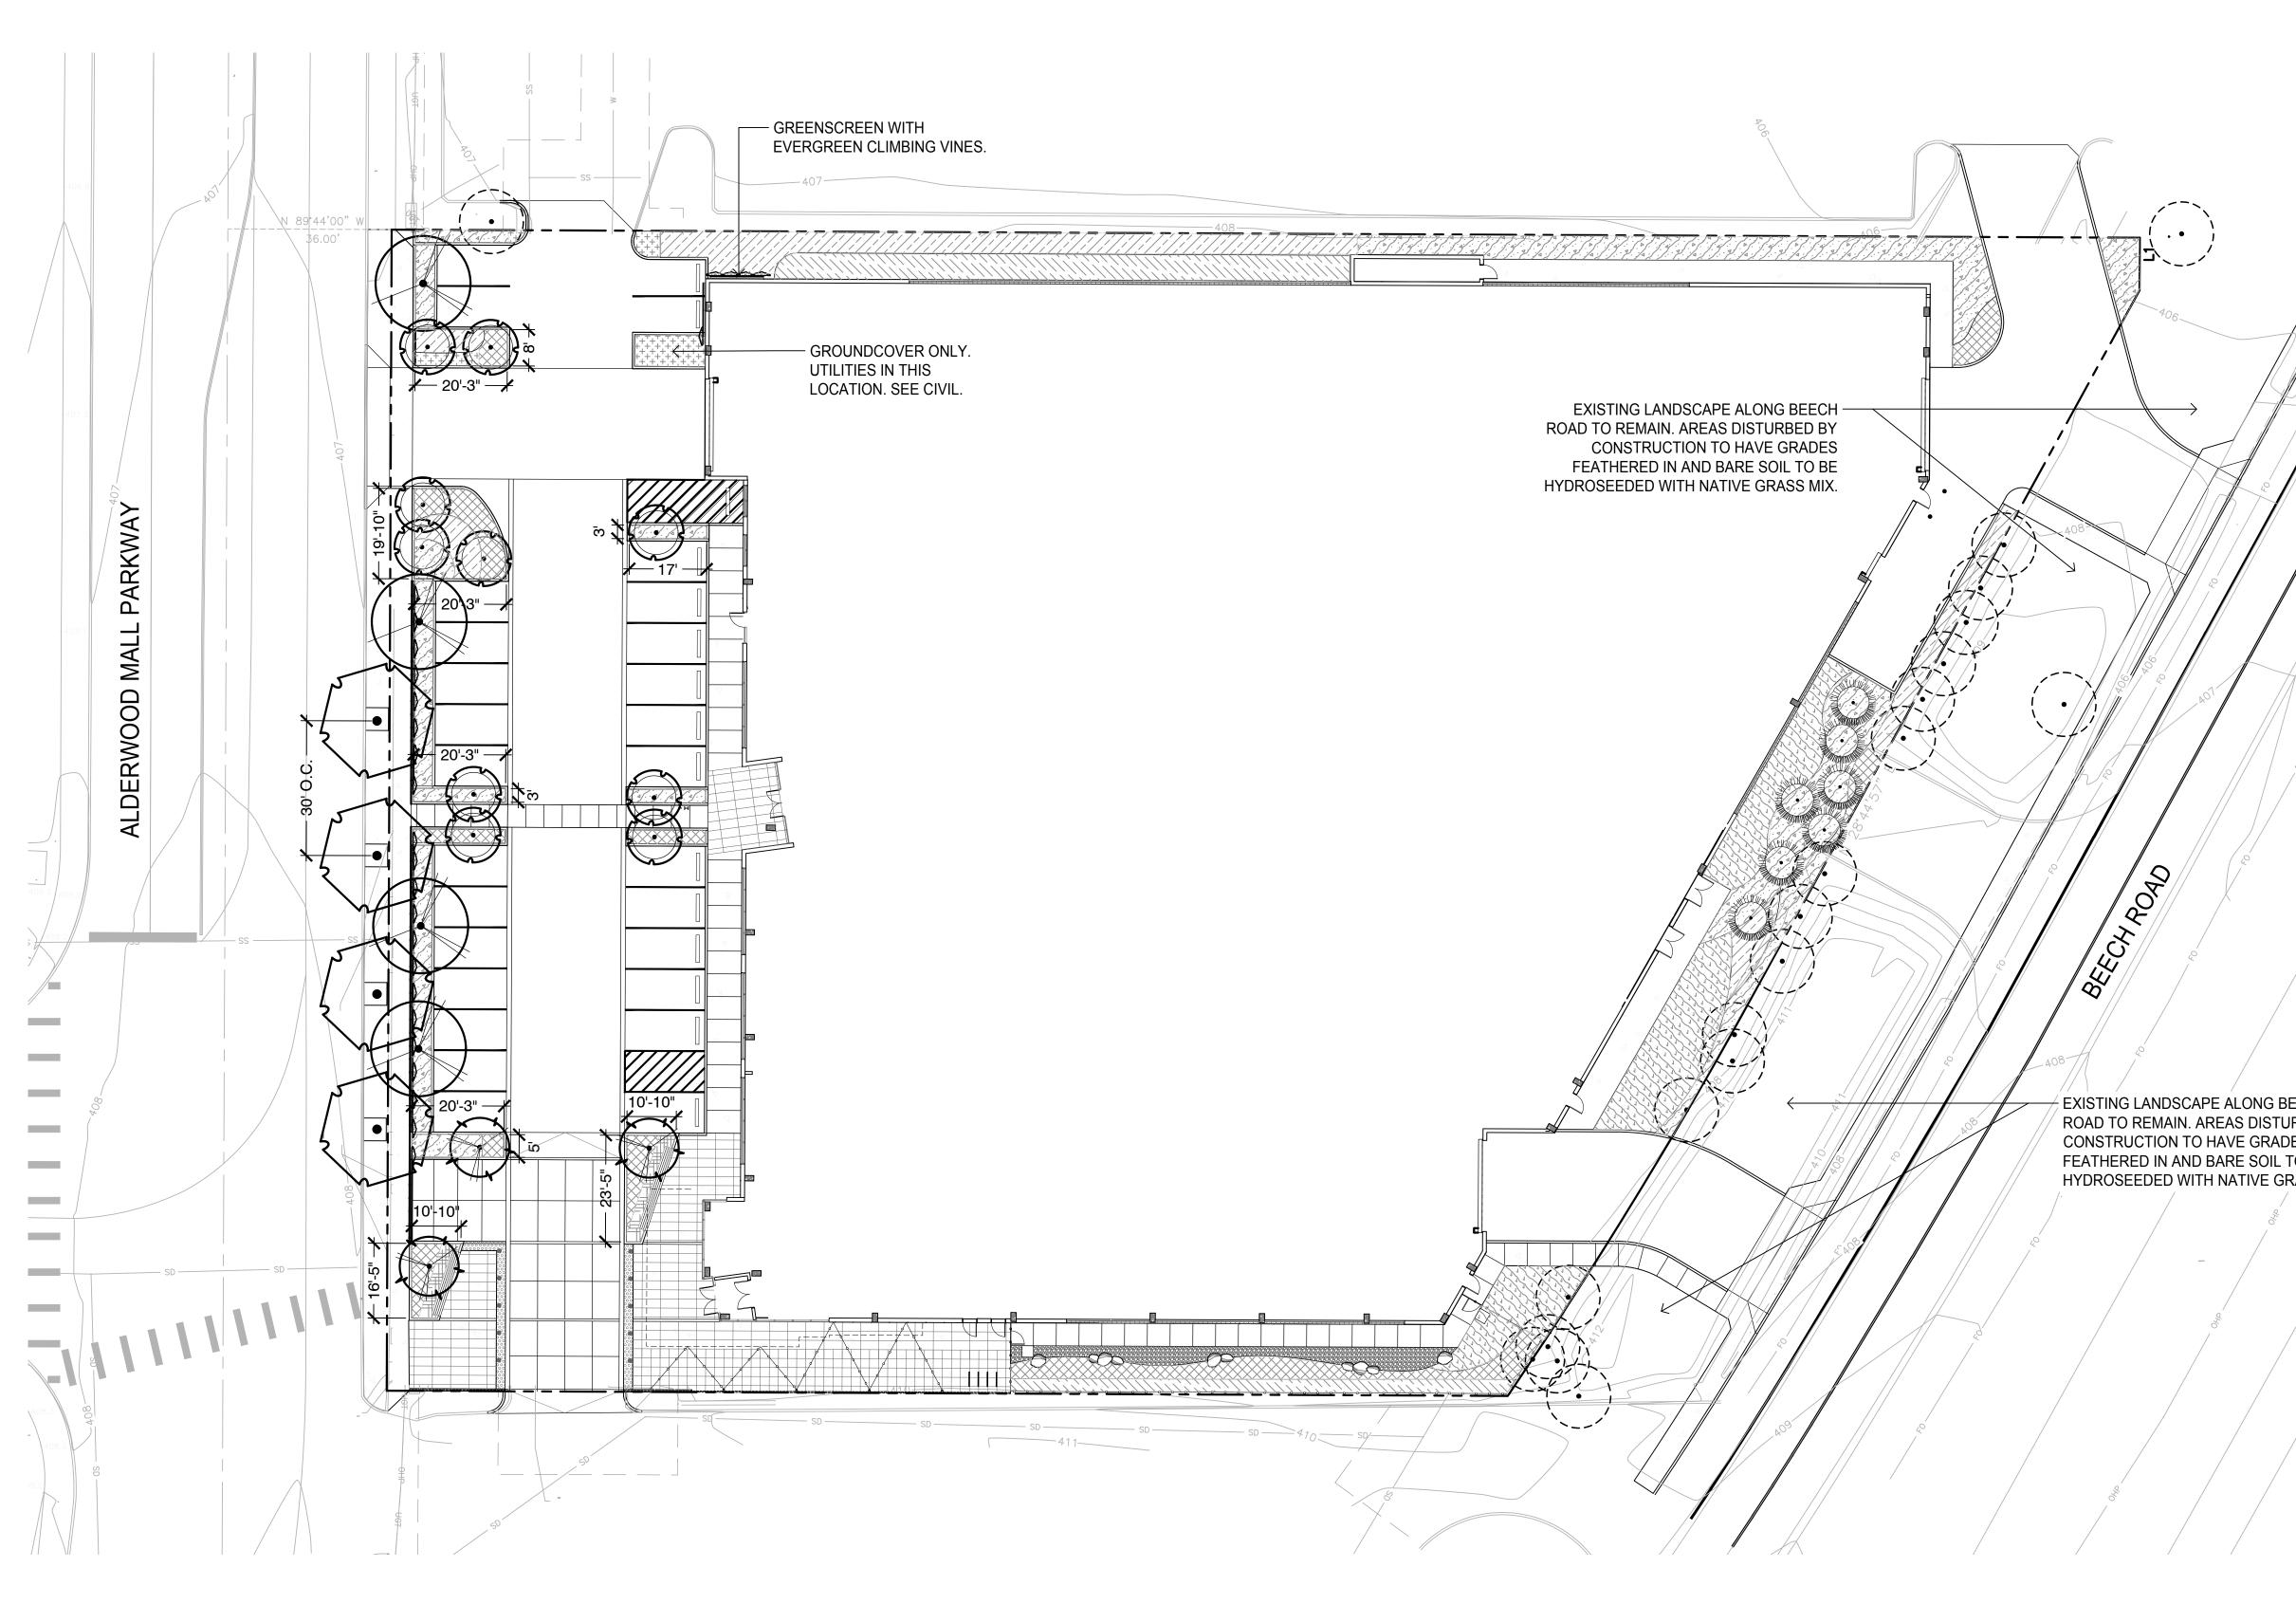
OWNER NAME

ALDERWOOD INVESTMENTS LLC

18799 ALDERWOOD MALL PARKWAY



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SCALE	AS SHOWN
PROJECT NUMBER	R 2023-02iVISTA
DESCRIPTION	
MATERIALS P	
LEVELS 3 AND) 4
SHEET NUMBER	
	L3.02
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LANDSCAPE CALCULATIONS PER LMC 21.08 AND LYNNWOOD CITYWIDE GUIDELINES

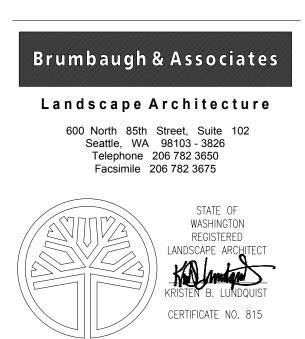INTERIOR PARKING LOT LANDSCAPE PROVIDED PARKING LOT AREA: 12,524 SF PROVIDED SURFACE PARKING COUNT: 30 STALLS REQUIRED INTERIOR PARKING LOT LANDSCAPE (10% OF PARKING LOT AREA): 1,252 SF PROVIDED INTERIOR PARKING LOT LANDSCAPE: 1,291 SF (10%) REQUIRED INTERIOR PARKING LOT TREES (1 MEDIUM TREE / 4 STALLS): 7 TREES PROVIDED INTERIOR PARKING LOT TREES: 9 TREES

PARKING LOT FRONTAGE PROVIDED STREET FRONTAGE: 255 LF (744 SF) REQUIRED FRONTAGE TREES (1 MED TREE / 22 LF): 12 MEDIUM TREES PROVIDED FRONTAGE TREES: 12 TREES REQUIRED SHRUBS (2/20 SF): 744 SF/10 = 74 SHRUBS PROVIDED SHRUBS: 144 LF @3' O.C. = 24 MEDIUM SHRUBS, @2' O.C. = 50 SMALL SHRUBS = 74 SHRUBS

PLANTING PROVIDED BETWEEN PARKING LOT AND R.O.W.: 74 SHRUBS REQUIRED EVERGREEN PLANTING BETWEEN PARKING LOT AND R.O.W.: (75%): 56 SHRUBS PROVIDED EVERGREEN PLANTING BETWEEN PARKING LOT AND R.O.W.: 56 (75%)

LANDSCAPE BUFFER: N/A

PLAZA AREA PROVIDED R-2 RESIDENTIAL AREA: 251,723 SF REQUIRED PLAZA AREA (1' PLAZA / 100' BUILDING AREA): 2,517 SF PROVIDED PLAZA AREA: 2,861 SF

LYNNWOOD MUNICIPAL CODE NOTES

1. LMC 21.08.300 (A)1 - SOIL MUST BE LOOSENED OR UNCOMPACTED, MIN. 24" DEPTH, IN BUFFER, STREET FRONTAGE, AND PARKING LOT LANDSCAPE AREAS WHERE NECESSARY DUE TO COMPACTION.

2. LMC 21.08.300 (A)2 - TREES PLANTED WITHIN 10' OF PUBLIC STREET OR SIDEWALK MUST BE SEPARATED FROM HARDSCAPE BY A ROOT BARRIER.

3. LMC 21.08.300 (B)1a - INVASIVE SPECIES ARE PROHIBITED PER WASHINGTON STATE NOXIOUS WEED CONTROL BOARD.

4. LMC 21.08.300 (C)1c - DECIDUOUS TREES MUST BE MIN. 8' HT. AND 2" CAL. AT TIME OF PLANTING.

5. LMC 21.08.300 (C)1d - TREES MUST HAVE 10' OF O.C. CLEARANCE BETWEEN TREES.

6. LMC 21.08.300 (C)1e - TREES MUST COMPLY WITH SNOHOMISH PUD UTILITY REQUIREMENTS.

7. LMC 21.08.300 (C)1g - TREE BRANCHES MUST BE TRIMMED TO PROVIDE MIN. 6' CLEARANCE. TREES OVERHANGING VEHICULAR USE AREA MUST PROVIDE 8' CLEARANCE.

CLASS II TREE REMOVAL AND REPLACEMENT SCHEDULE PER LMC 17.15

TOTAL NUMBER OF SIGNIFICANT TREES TO BE REMOVED: 37 QTY. TOTAL DBH OF SIGNIFICANT TREES TO BE REMOVED: 352 DBH AVERAGE DBH OF SIGNIFICANT TREES TO BE REMOVED (DBH / SIG TREE): 9.5 DBH REQUIRED REPLACEMENT TREES (# OF SIGNIFICANT TREES REMOVED X TREE UNITS): 37 TREES

PROVIDED REPLACEMENT TREES: 38 TREES TOTAL NUMBER OF NON SIGNIFICANT TREES TO BE REMOVED: 9 TREES

REQUIRED REPLACEMENT (1 TREE / 10 NON-SIGNIFICANT TREES REMOVED): 1 TREE PROVIDED REPLACEMEMT: 1 TREES

CLASS II PERMIT REPLACEMENT TREE NOTES

1. PRIOR TO PLANTING, LOCATION AND SPECIES SHALL BE APPROVED BY THE CITY.

2. DECIDUOUS REPLACEMENT TREES SHALL BE MIN. 2 1/2" CAL.

3. EVERGREEN REPLACEMENT TREES SHALL BE MIN. 8' HT.

EXISTING LANDSCAPE ALONG BE ROAD TO REMAIN. AREAS DISTUF CONSTRUCTION TO HAVE GRADE FEATHERED IN AND BARE SOIL T

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PROJECT NAME


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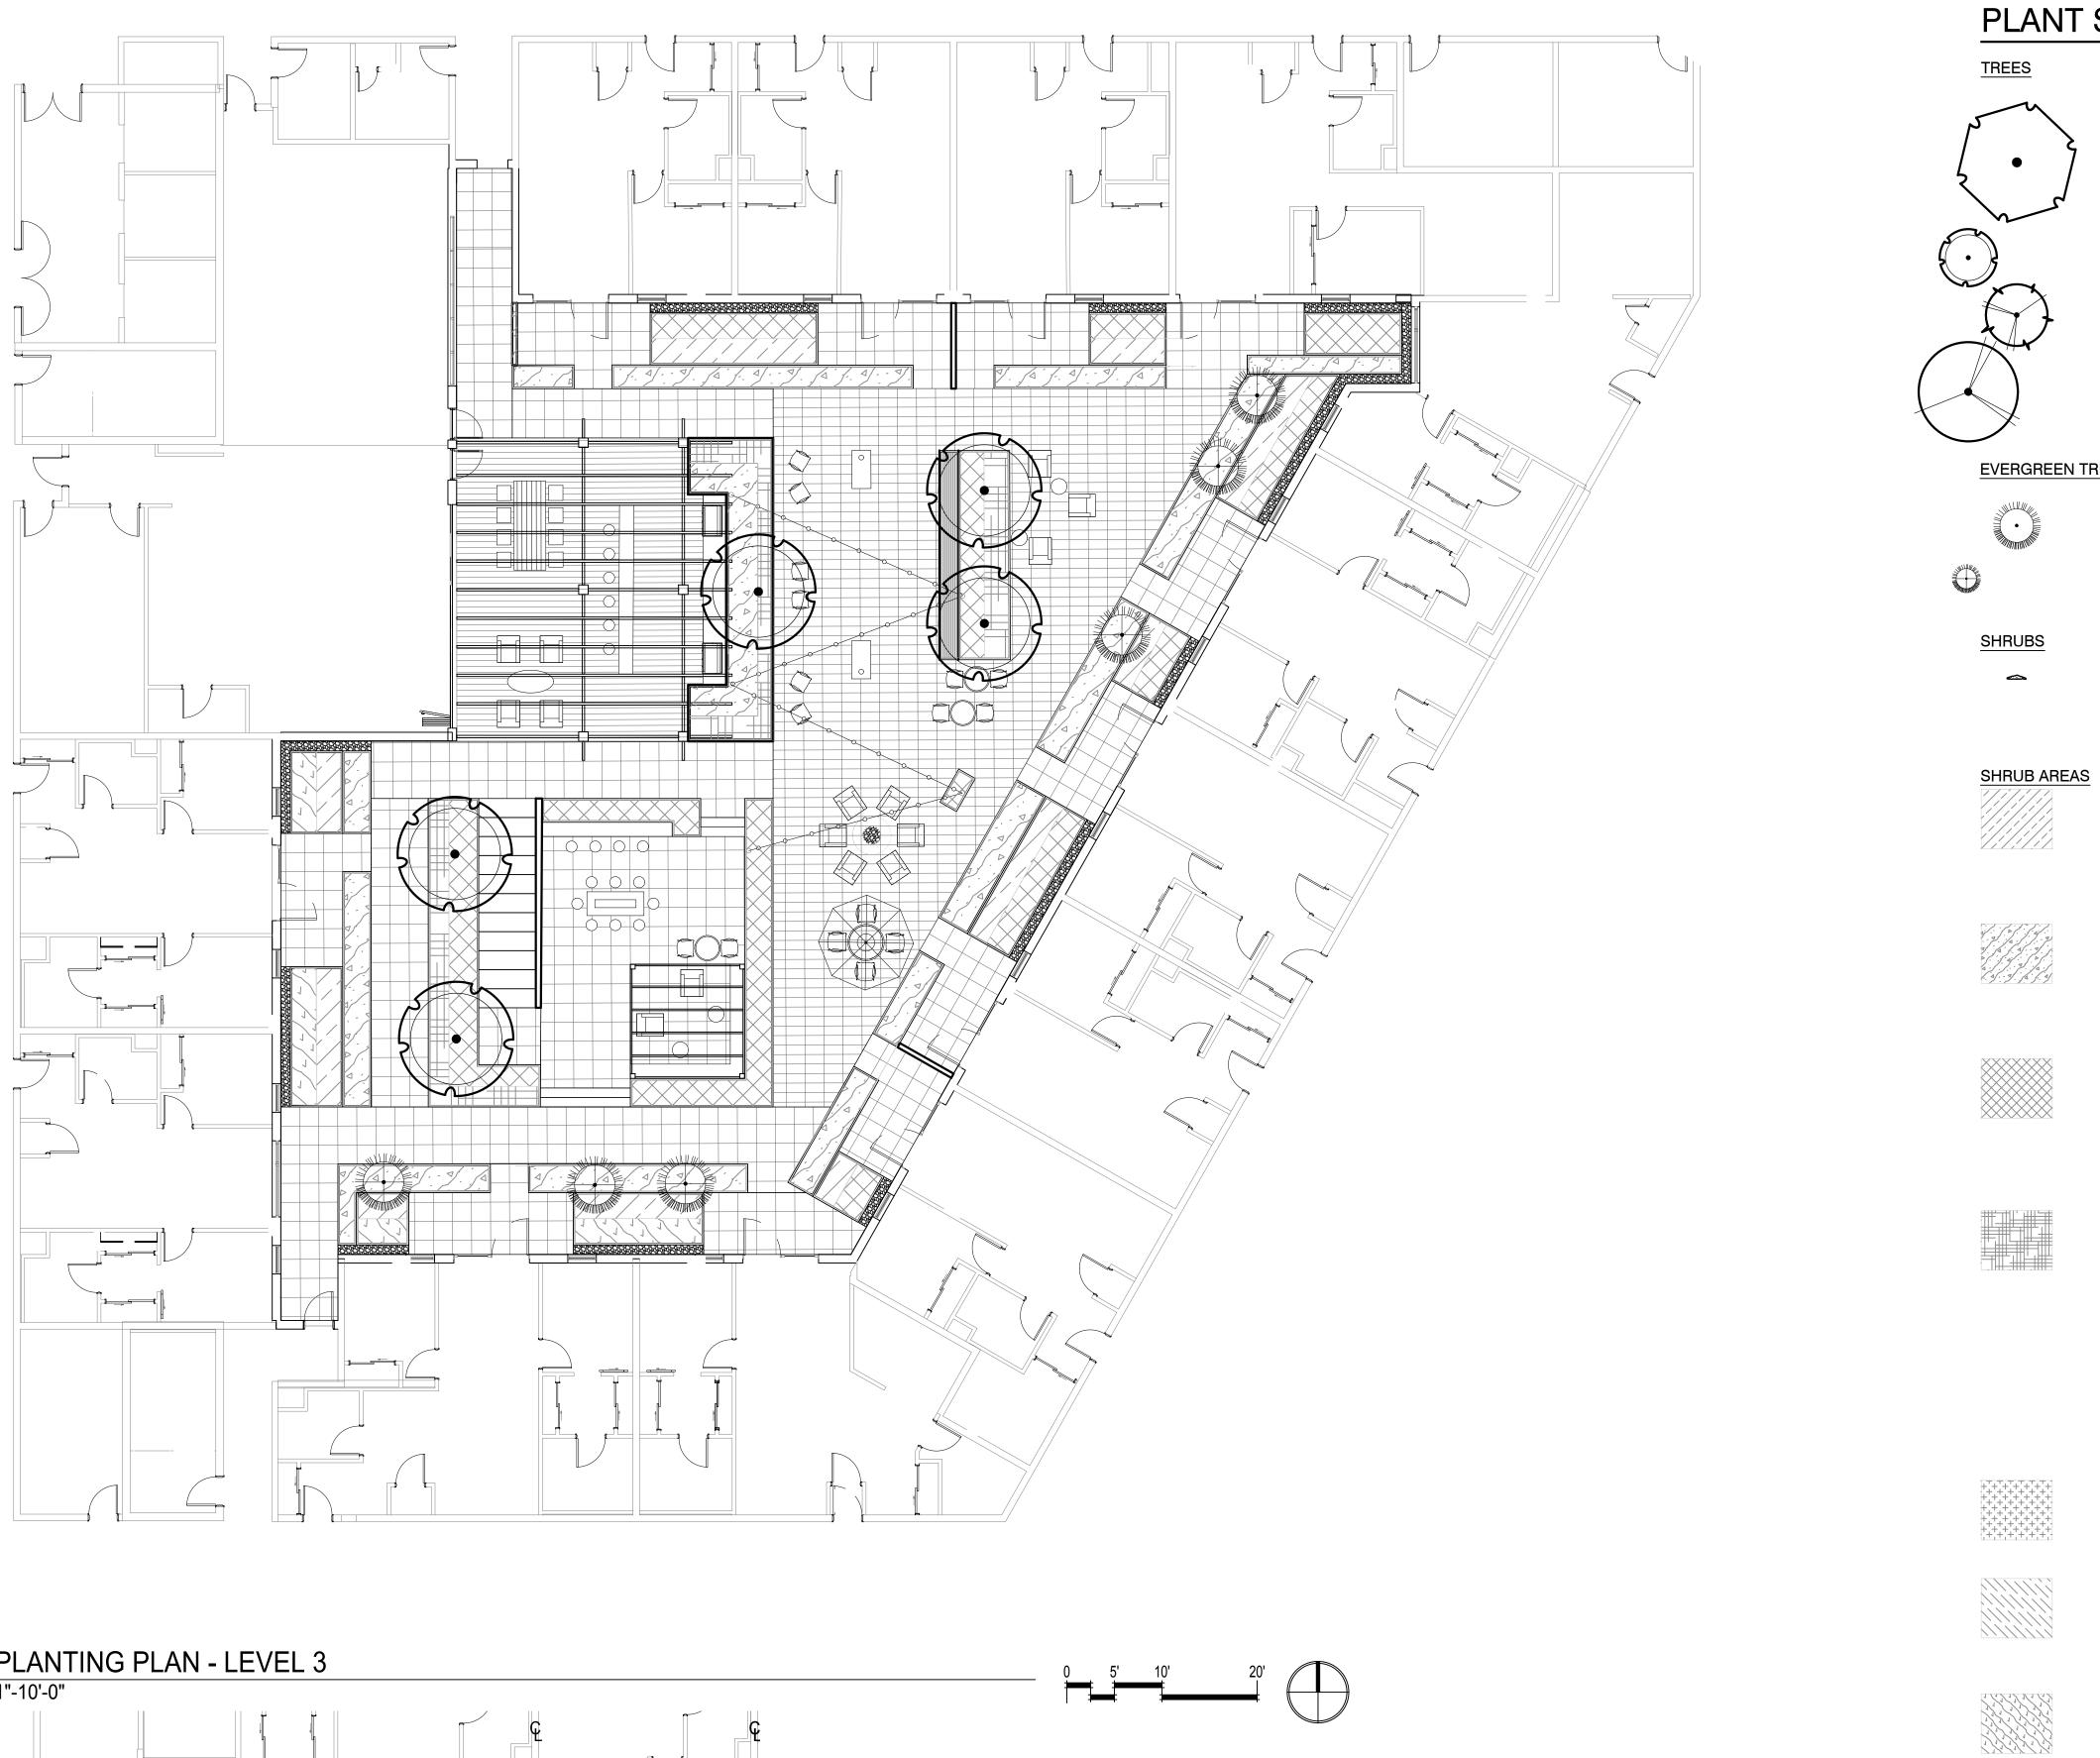
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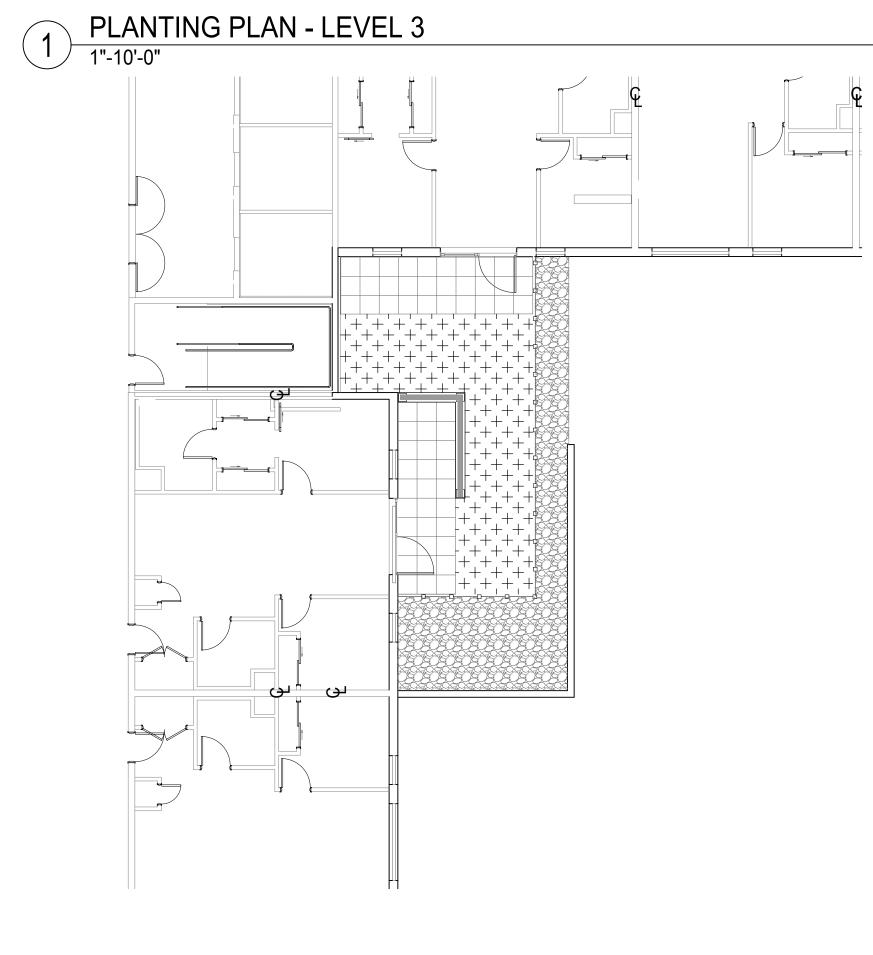
18799 ALDERWOOD MALL PARKWAY



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	SCALE	AS SHOWN
	PROJECT NUMBER	2023-02iVISTA
	DESCRIPTION	
	PLANTING PLAN SITE LEVEL	-
	SHEET NUMBER	
		.5.01
	ALL DRAWINGS AND WRITTEN MAT HEREIN CONSTITUTE ORIGINAL AN WORK OF THE DESIGN PROFESSIO DUPLICATED, USED OR DISCLOSEI	ID UNPUBLISHED

CONSENT OF THE DESIGN PROFESSIONAL



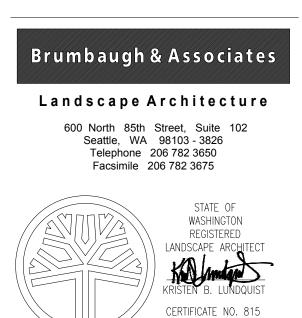

0 5' 10'

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2 PLANTING PLAN - LEVEL 4 1"-10'-0"

PLANT SCH	HEDU	JLE			
TREES	CODE	QTY	BOTANICAL / COMMON NAME	SIZE	
No M					
		4	ACER SACCHARUM 'BONFIRE' / BONFIRE SUGAR MAPLE	2.5" CAL.	
		15	GINKGO BILOBA 'THE PRESIDENT' / PRESIDENTIAL GOLD® MAIDENHAIR TREE	2.5" CAL.	
		3	STYRAX JAPONICUS 'SNOWCONE' / SNOWCONE JAPANESE SNOWBELL MULTI-STEM	10` - 12` HT.	
		4	TILIA CORDATA 'DE GROOT' / DE GROOT LITTLELEAF LINDEN	2.5" CAL.	
EVERGREEN TREES		<u>QTY</u>	BOTANICAL / COMMON NAME	SIZE	
		7	CALOCEDRUS DECURRENS / INCENSE CEDAR	8` - 10` HT.	
		6	CHAMAECYPARIS OBTUSA / HINOKI FALSE CYPRESS	8` HT.	
SHRUBS		QTY	BOTANICAL / COMMON NAME	SIZE	SPACING
-		26	CLIMBING VINES		48" o.c.
		9 9 9	AKEBIA QUINATA / CHOCOLATE VINE CLEMATIS ARMANDII 'SNOWDRIFT' / EVERGREEN CLEMATIS HOLBOELLIA CORIACEA / CHINA BLUE VINE	2 GAL 2 GAL 2 GAL	48" o.c. 48" o.c.
SHRUB AREAS		<u>QTY</u>	BOTANICAL / COMMON NAME	SIZE	SPACING
		102	DECIDUOUS SHRUBS	3 GAL	49"
		103 183	CORNUS ALBA 'ELEGANTISSIMA' / SILVEREDGE TATARIAN DOGWOOD HYDRANGEA PANICULATA 'JANE' / LITTLE LIME® PANICLE HYDRANGEA	3 GAL	48" o.c. 36" o.c.
		103 103	HYDRANGEA QUERCIFOLIA / OAKLEAF HYDRANGEA RIBES SANGUINEUM 'KING EDWARD VII' / RED FLOWERING CURRANT	3 GAL 3 GAL	48" o.c. 48" o.c.
1. [b]] 4] . . d . [b] .] .] . . f] [b] .] .] . . [b] .] . [b] .			EVERGREEN SHRUBS		
a		864 384	EUONYMUS JAPONICUS 'GREEN SPIRE' / GREEN SPIRE JAPANESE EUONYMUS GAULTHERIA SHALLON / SALAL	3 GAL 3 GAL	24" o.c. 36" o.c.
		384 216	LONICERA PILEATA / PRIVET HONEYSUCKLE TAXUS X MEDIA 'HICKSII' / HICKS ANGLO-JAPANESE YEW	3 GAL 3 GAL	36" o.c. 48" o.c.
			ORNAMENTAL GRASSES		
		414 414	CALAMAGROSTIS X ACUTIFLORA 'KARL FOERSTER' / KARL FOERSTER FEATHER REED GRASS DESCHAMPSIA CESPITOSA / TUFTED HAIR GRASS	1 GAL 1 GAL	24" o.c. 24" o.c.
		265	MISCANTHUS SINENSIS 'YAKU JIMA' / YAKU JIMA EULALIA GRASS	1 GAL	30" o.c.
		414 736	PENNISETUM ALOPECUROIDES 'HAMELN' / HAMELN FOUNTAIN GRASS SESLERIA AUTUMNALIS / AUTUMN MOOR GRASS	1 GAL 1 GAL	24" o.c. 18" o.c.
			PERENNIALS		
		54 149	ACANTHUS MOLLIS 'OAK LEAF' / OAK LEAF BEAR'S BREECH AGASTACHE FOENICULUM 'GOLDEN JUBILEE' / GOLDEN JUBILEE GIANT HYSSOP	1 GAL 1 GAL	30" o.c. 18" o.c.
		149	ECHINACEA PURPUREA 'WHITE SWAN' / WHITE SWAN CONEFLOWER	1 GAL	18" o.c.
		84 149	EUPATORIUM RUGOSUM 'CHOCOLATE' / CHOCOLATE SNAKEROOT GEUM X 'TOTALLY TANGERINE' / TOTALLY TANGERINE GEUM	1 GAL 1 GAL	24" o.c. 18" o.c.
		149	HEUCHERA X 'OBSIDIAN' / OBSIDIAN CORAL BELLS	1 GAL	18" o.c.
		54 149	HOSTA SIEBOLDIANA 'ELEGANS' / ELEGANS HOSTA LIRIOPE MUSCARI 'BIG BLUE' / BIG BLUE LILYTURF	1 GAL 1 GAL	30" o.c. 18" o.c.
		149	PEROVSKIA ATRIPLICIFOLIA 'BLUE SPIRE' / BLUE SPIRE RUSSIAN SAGE	1 GAL	18" o.c.
		84 54	SEDUM X 'AUTUMN JOY' / AUTUMN JOY SEDUM STACHYS BYZANTINA 'BIG EARS' / BIG EARS LAMB'S EAR	1 GAL 1 GAL	24" o.c. 30" o.c.
			GROUNDCOVERS		
		49 49	COTONEASTER DAMMERI / BEARBERRY COTONEASTER EUONYMUS FORTUNEI 'KEWENSIS' / KEW WINTERCREEPER	1 GAL 1 GAL	24" o.c. 24" o.c.
			FOUNDATION SHRUBS		
		69 69	MYRICA CALIFORNICA / PACIFIC WAX MYRTLE PRUNUS LUSITANICA / PORTUGAL LAUREL	3 GAL 3 GAL	48" o.c. 48" o.c.
		90	TAXUS X MEDIA 'HICKSII' / HICKS ANGLO-JAPANESE YEW	3 GAL	40 0.c. 42" o.c.
		004		1 0 1	o ("
1 1 1 1 1 1 1 1 1 1 1 1 1 1 1 1 1 1 1		381 170	DRYOPTERIS ERYTHROSORA 'BRILLIANCE' / BRILLIANCE AUTUMN FERN POLYSTICHUM MUNITUM / WESTERN SWORD FERN	1 GAL 2 GAL	24" o.c. 36" o.c.
GROUND COVERS		<u>QTY</u>	BOTANICAL / COMMON NAME	SIZE	SPACING
++++++++++++++++++++++++++++++++++++		322 SF	GREEN ROOF / SEDUM TILE TILE	1 GAL	

PROJECT NAME

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18799 ALDERWOOD MALL PARKWAY LYNNWOOD, WA 98037

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ALDERWOOD INVESTMENTS LLC

18799 ALDERWOOD MALL PARKWAY

Brumbaugh & Associates


Landscape Architecture 600 North 85th Street, Suite 102 Seattle, WA 98103 - 3826 Telephone 206 782 3650 Facsimile 206 782 3675 STATE OF WASHINGTON REGISTERED LANDSCAPE ARCHITECT / KRISTEN B. LUNDQUIST CERTIFICATE NO. 815

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SCALE

AS SHOWN


PROJECT NUMBER 2023-02iVISTA

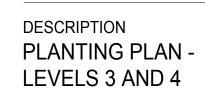

SHEET NUMBER





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IRRIGATION PLAN - SITE LEVEL

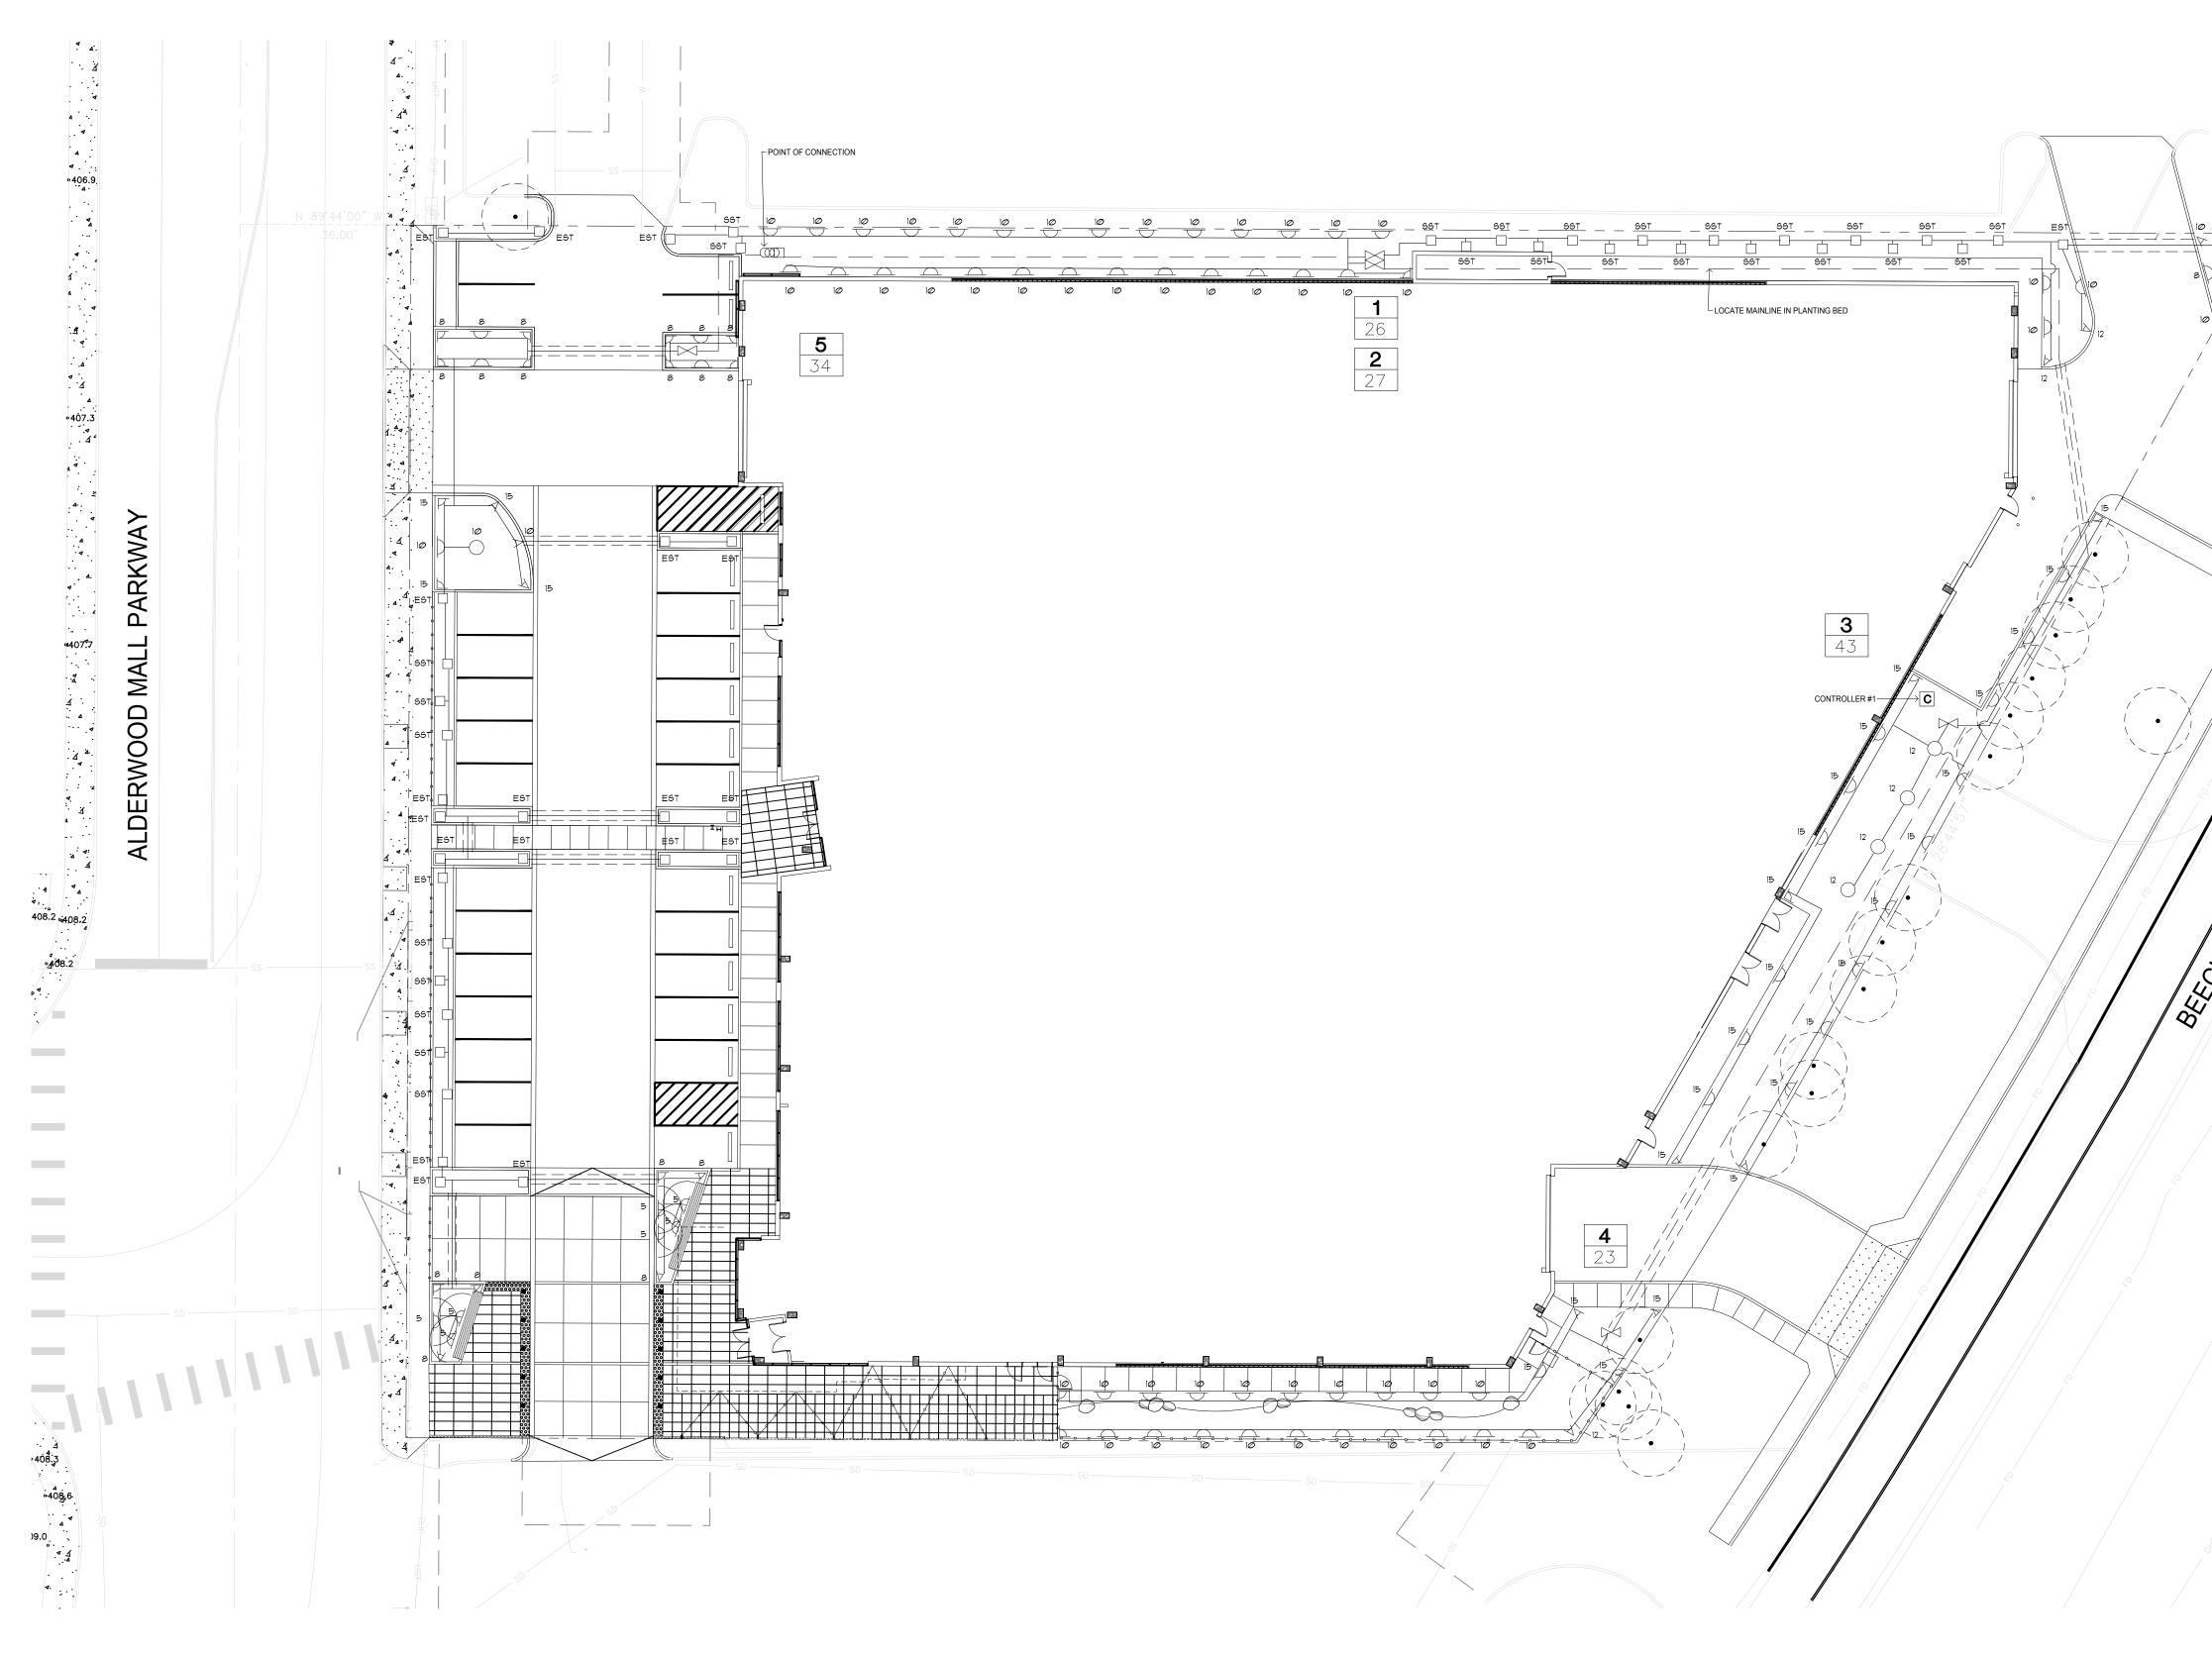



PROJECT NAME

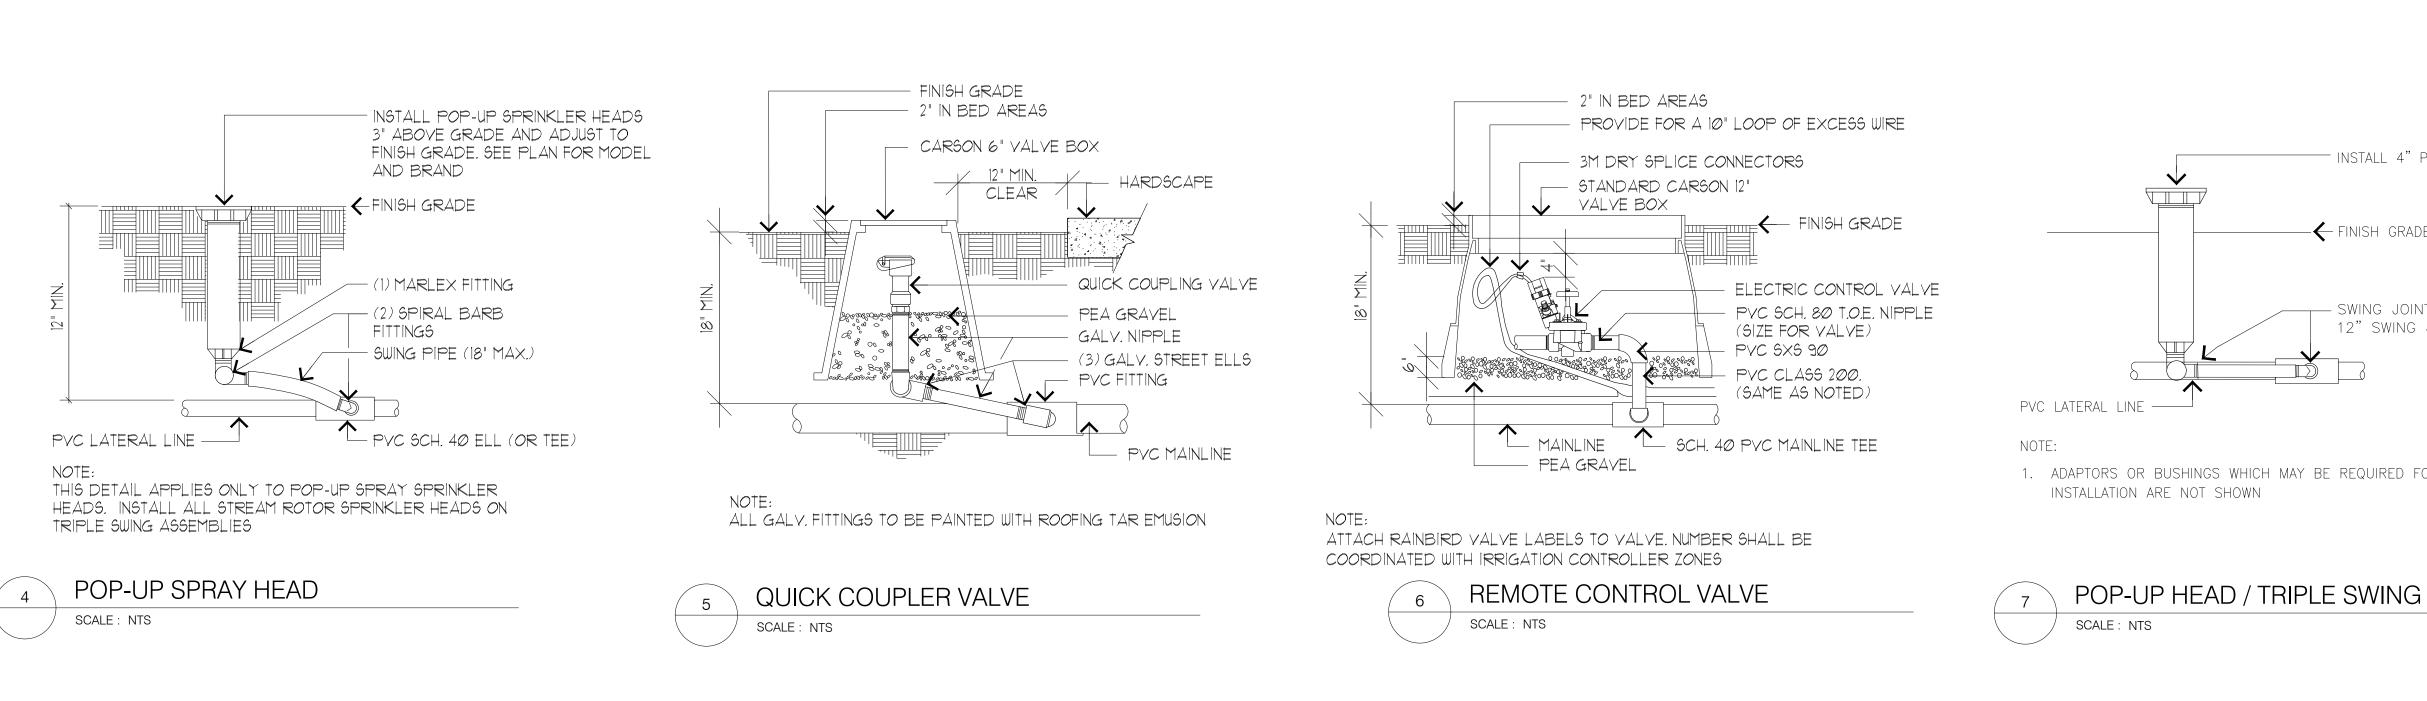
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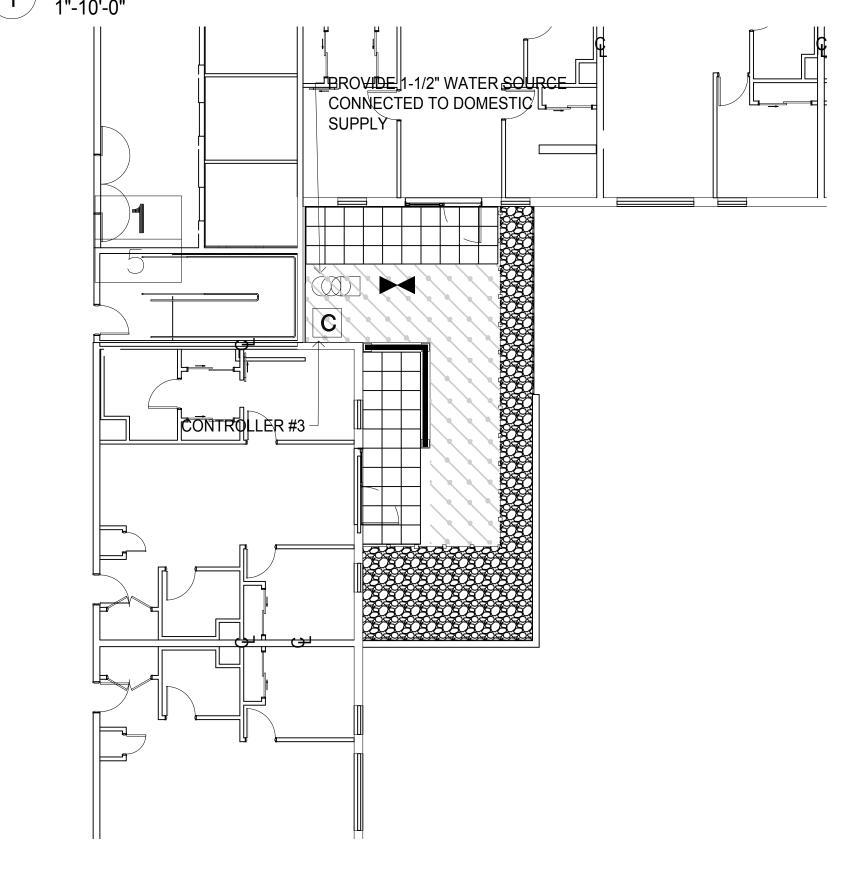
ALDERWOOD **INVESTMENTS LLC**

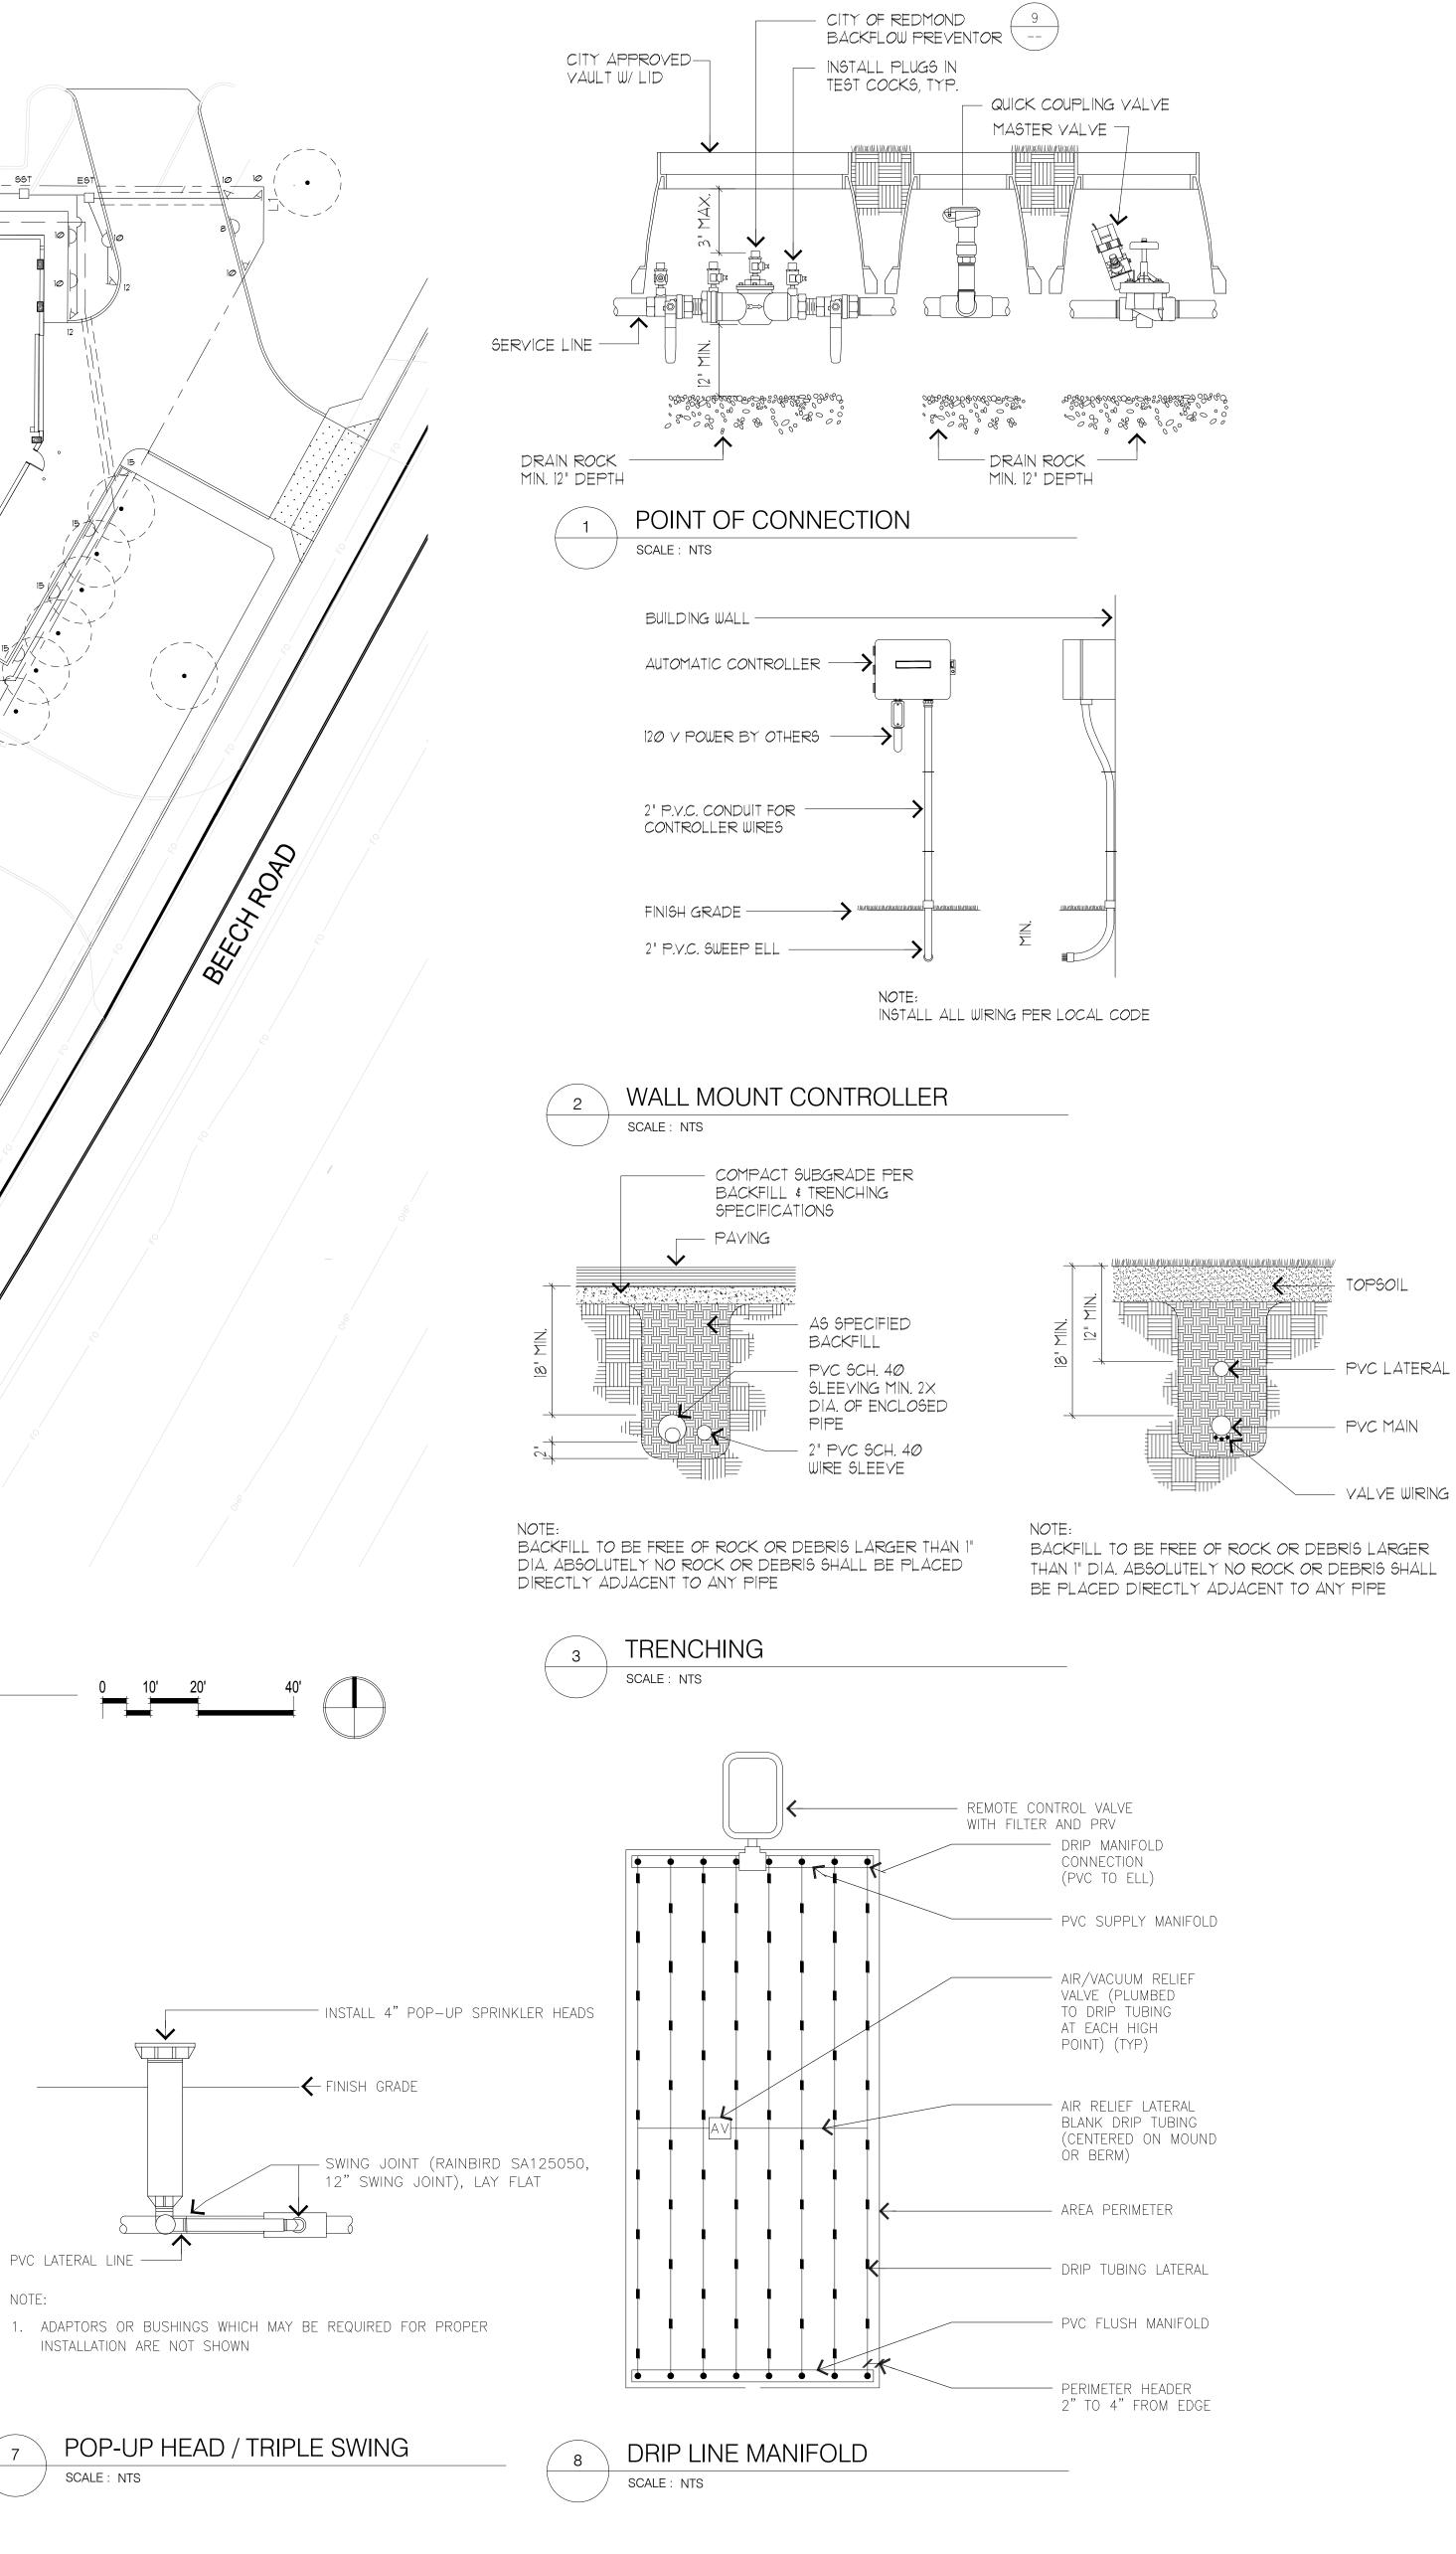








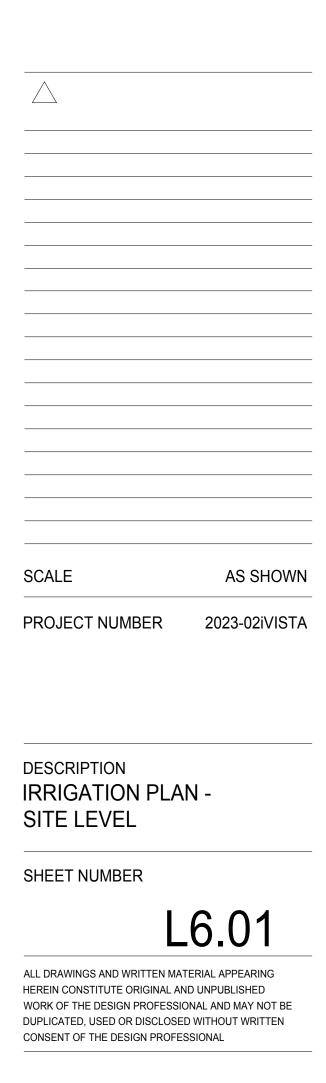

2 IRRIGATION PLAN - LEVEL 4 1"-10'-0"

0 5' 10' 20'

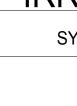

IRRIGATION SCHEDULE

SYMBOL					
	DESCRIPTION		PSI	RADIUS	G.P.M.
) 15	RAINBIRD RD06-S-P	30-E - 1115E	30	15'	3.70
\sim 15	RAINBIRD RD06-S-P		30	15'	1.85
⊥ 15 □ 15	RAINBIRD RD06-S-P		30	15	0.92
	RAINBIRD RD06-S-P		30	15	2.78
イン 15 人 15			30	15	
	RAINBIRD RD06-S-P	30-Г- ПЕ-VAN-13	30	15	0.93
12	RAINBIRD RD06-S-P	30-F - U12F	30	12'	2.60
<u> </u>	RAINBIRD RD06-S-P	30-F - U12H	30	12'	1.30
□_ 12	RAINBIRD RD06-S-P	30-F - U12Q	30	12'	0.65
<u> </u>	RAINBIRD RD06-S-P	30-F - HE-VAN-12	30	12'	1.77
ˈ <u>/</u> 12	RAINBIRD RD06-S-P	30-F - HE-VAN-12	30	12'	0.59
0 10	RAINBIRD RD06-S-P	30-F - U10F	30	10'	1.64
<u> </u>	RAINBIRD RD06-S-P	30-F - U10H	30	10'	0.82
└ <u></u> 10	RAINBIRD RD06-S-P	30-F- U10Q	30	10'	0.41
<u> </u>	RAINBIRD RD06-S-P	30-F - HE-VAN-10	30	10'	1.34
✓ 10	RAINBIRD RD06-S-P	30-F - HE-VAN-10	30	10'	0.45
8	RAINBIRD RD06-S-P	30-F - U8F	30	8'	1.05
<u> </u>	RAINBIRD RD06-S-P	30-F - U8H	30	8'	0.52
▶ 8	RAINBIRD RD06-S-P	30-F - U8Q	30	8'	0.26
<u> </u>	RAINBIRD RD06-S-P	30-F- HE-VAN-8	30	8'	0.88
∠ 8	RAINBIRD RD06-S-P		30	8'	0.29
<u> </u>	RAINBIRD RD06-S-P		30	6'	0.30
5	RAINBIRD RD06-S-P	30-F - MPR-5Q	30	6'	0.15
	RAINBIRD XQF1012	-12-100 - SUB-SURFACE DRIPLINE 100 - 1" DRIPLINE HEADER 1/2" AIR RELIEF VALVE	40		.9 GPH
	RAINBIRD OPERINE	- DRIP SYSTEM OPERATION INDICATOR. INSTALL ONE AT EACH ZONE			
	CONTROLLER - ZOI	INSTALL ONE AT EACH ZONE			
		INSTALL ONE AT EACH ZONE			
C	CONTROLLER - ZOI	INSTALL ONE AT EACH ZONE	CONTROL SYSTE	EM WITH CEL	LULAR CONNECTIO
C	CONTROLLER - ZOI ZONE GPM CONTROLLER: 1	INSTALL ONE AT EACH ZONE NE NUMBER RAINBIRD ESP8LXME - 8 STATION CONTROLLEF RAINBIRD IQ-CLOUD V3.0 - MODULAR CENTRAL RAINBIRD IQ FSCM-LXME FLOW SMART CONNE	CONTROL SYSTE CTION MODULE R, WALL MOUNT CONTROL SYSTE	-	
C	CONTROLLER - ZOI ZONE GPM CONTROLLER: 1 ON-GRADE CONTROLLER: 2 LEVEL 2	INSTALL ONE AT EACH ZONE NE NUMBER RAINBIRD ESP8LXME - 8 STATION CONTROLLEF RAINBIRD IQ-CLOUD V3.0 - MODULAR CENTRAL RAINBIRD IQ FSCM-LXME FLOW SMART CONNE RAINBIRD WR2-RFC RAIN + FREEZE SENSOR RAINBIRD ESP8LXME - 8 STATION CONTROLLEF RAINBIRD IQ-CLOUD V3.0 - MODULAR CENTRAL RAINBIRD IQ FSCM-LXME FLOW SMART CONNE	CONTROL SYSTE CTION MODULE R, WALL MOUNT CONTROL SYSTE CTION MODULE R, WALL MOUNT CONTROL SYSTE	EM WITH CEL	LULAR CONNECTIC
C	CONTROLLER - ZON ZONE GPM CONTROLLER: 1 ON-GRADE CONTROLLER: 2 LEVEL 2 COURTYARD CONTROLLER: 3 ROOF RAINBIRD 200-PESE	INSTALL ONE AT EACH ZONE NE NUMBER RAINBIRD ESP8LXME - 8 STATION CONTROLLEF RAINBIRD IQ-CLOUD V3.0 - MODULAR CENTRAL RAINBIRD IQ FSCM-LXME FLOW SMART CONNE RAINBIRD WR2-RFC RAIN + FREEZE SENSOR RAINBIRD ESP8LXME - 8 STATION CONTROLLEF RAINBIRD IQ FSCM-LXME FLOW SMART CONNE RAINBIRD IQ FSCM-LXME FLOW SMART CONNE RAINBIRD WR2-RFC RAIN + FREEZE SENSOR RAINBIRD WR2-RFC RAIN + FREEZE SENSOR RAINBIRD WR2-RFC RAIN + FREEZE SENSOR	CONTROL SYSTE CTION MODULE R, WALL MOUNT CONTROL SYSTE CTION MODULE R, WALL MOUNT CONTROL SYSTE	EM WITH CEL	LULAR CONNECTIC
	CONTROLLER - ZON ZONE GPM CONTROLLER: 1 ON-GRADE CONTROLLER: 2 LEVEL 2 COURTYARD CONTROLLER: 3 ROOF RAINBIRD 200-PESE RAINBIRD 200-PESE RAINBIRD XCZ-100-	INSTALL ONE AT EACH ZONE NE NUMBER RAINBIRD ESP8LXME - 8 STATION CONTROLLEF RAINBIRD IQ-CLOUD V3.0 - MODULAR CENTRAL RAINBIRD IQ FSCM-LXME FLOW SMART CONNE RAINBIRD WR2-RFC RAIN + FREEZE SENSOR RAINBIRD ESP8LXME - 8 STATION CONTROLLEF RAINBIRD IQ-CLOUD V3.0 - MODULAR CENTRAL RAINBIRD IQ FSCM-LXME FLOW SMART CONNE RAINBIRD WR2-RFC RAIN + FREEZE SENSOR RAINBIRD WR2-RFC RAIN + FREEZE SENSOR RAINBIRD ESP8LXME - 8 STATION CONTROLLEF RAINBIRD WR2-RFC RAIN + FREEZE SENSOR RAINBIRD IQ-CLOUD V3.0 - MODULAR CENTRAL RAINBIRD IQ-CLOUD V3.0 - MODULAR CENTRAL RAINBIRD IQ FSCM-LXME FLOW SMART CONNE RAINBIRD VR2-RFC RAIN + FREEZE SENSOR	CONTROL SYSTE CTION MODULE R, WALL MOUNT CONTROL SYSTE CTION MODULE R, WALL MOUNT CONTROL SYSTE CTION MODULE	EM WITH CEL	LULAR CONNECTIC
	CONTROLLER - ZON ZONE GPM CONTROLLER: 1 ON-GRADE CONTROLLER: 2 LEVEL 2 COURTYARD CONTROLLER: 3 ROOF RAINBIRD 200-PESE RAINBIRD 200-PESE RAINBIRD XCZ-100- RAINBIRD 44 NP - 1	INSTALL ONE AT EACH ZONE NE NUMBER RAINBIRD ESP8LXME - 8 STATION CONTROLLEF RAINBIRD IQ-CLOUD V3.0 - MODULAR CENTRAL RAINBIRD IQ FSCM-LXME FLOW SMART CONNE RAINBIRD WR2-RFC RAIN + FREEZE SENSOR RAINBIRD ESP8LXME - 8 STATION CONTROLLEF RAINBIRD IQ-CLOUD V3.0 - MODULAR CENTRAL RAINBIRD IQ FSCM-LXME FLOW SMART CONNE RAINBIRD WR2-RFC RAIN + FREEZE SENSOR RAINBIRD WR2-RFC RAIN + FREEZE SENSOR RAINBIRD WR2-RFC RAIN + FREEZE SENSOR RAINBIRD IQ-CLOUD V3.0 - MODULAR CENTRAL RAINBIRD IQ-SCM-LXME FLOW SMART CONNE RAINBIRD IQ FSCM-LXME FLOW SMART CONNE RAINBIRD WR2-RFC RAIN + FREEZE SENSOR	CONTROL SYSTE CTION MODULE R, WALL MOUNT CONTROL SYSTE CTION MODULE R, WALL MOUNT CONTROL SYSTE CTION MODULE	EM WITH CEL	LULAR CONNECTIO
	CONTROLLER - ZON ZONE GPM CONTROLLER: 1 ON-GRADE CONTROLLER: 2 LEVEL 2 COURTYARD CONTROLLER: 3 ROOF RAINBIRD 200-PESE RAINBIRD 200-PESE RAINBIRD XCZ-100- RAINBIRD 44 NP - 1 2" FEBCO DOUBLE	INSTALL ONE AT EACH ZONE NE NUMBER RAINBIRD ESP8LXME - 8 STATION CONTROLLEF RAINBIRD IQ-CLOUD V3.0 - MODULAR CENTRAL RAINBIRD IQ FSCM-LXME FLOW SMART CONNE RAINBIRD WR2-RFC RAIN + FREEZE SENSOR RAINBIRD ESP8LXME - 8 STATION CONTROLLEF RAINBIRD IQ-CLOUD V3.0 - MODULAR CENTRAL RAINBIRD IQ FSCM-LXME FLOW SMART CONNE RAINBIRD WR2-RFC RAIN + FREEZE SENSOR RAINBIRD WR2-RFC RAIN + FREEZE SENSOR RAINBIRD ESP8LXME - 8 STATION CONTROLLEF RAINBIRD UR2-RFC RAIN + FREEZE SENSOR 8, 2" REMOTE CONTROL VALVE PESB, 1" VALVE WITH BASKET FILTER ' QUICK COUPLING VALVE. PROVIDE ONE AT EACH	CONTROL SYSTE CTION MODULE R, WALL MOUNT CONTROL SYSTE CTION MODULE R, WALL MOUNT CONTROL SYSTE CTION MODULE	EM WITH CEL	LULAR CONNECTIO
	CONTROLLER - ZON ZONE GPM CONTROLLER: 1 ON-GRADE CONTROLLER: 2 LEVEL 2 COURTYARD CONTROLLER: 3 ROOF RAINBIRD 200-PESE RAINBIRD 200-PESE RAINBIRD XCZ-100- RAINBIRD XCZ-100- RAINBIRD 44 NP - 1 2" FEBCO DOUBLE THREADED COPPEN SCHEDULE 40 PVC	INSTALL ONE AT EACH ZONE NE NUMBER RAINBIRD ESP8LXME - 8 STATION CONTROLLEF RAINBIRD IQ-CLOUD V3.0 - MODULAR CENTRAL RAINBIRD IQ FSCM-LXME FLOW SMART CONNE RAINBIRD WR2-RFC RAIN + FREEZE SENSOR RAINBIRD ESP8LXME - 8 STATION CONTROLLEF RAINBIRD IQ-CLOUD V3.0 - MODULAR CENTRAL RAINBIRD IQ FSCM-LXME FLOW SMART CONNE RAINBIRD WR2-RFC RAIN + FREEZE SENSOR RAINBIRD ESP8LXME - 8 STATION CONTROLLEF RAINBIRD WR2-RFC RAIN + FREEZE SENSOR RAINBIRD IQ-CLOUD V3.0 - MODULAR CENTRAL RAINBIRD IQ-CLOUD V3.0 - MODULAR CENTRAL RAINBIRD IQ-SCM-LXME FLOW SMART CONNE RAINBIRD IQ FSCM-LXME FLOW SMART CONNE RAINBIRD WR2-RFC RAIN + FREEZE SENSOR 8, 2" REMOTE CONTROL VALVE PESB, 1" VALVE WITH BASKET FILTER ' QUICK COUPLING VALVE. PROVIDE ONE AT EACH CHECK VALVE - PROVIDE ONE AT COURTYARD LE' R STUB (OR APPROVED EQUAL). COORDINATE WI' 2" MAINLINE.	CONTROL SYSTE CTION MODULE R, WALL MOUNT CONTROL SYSTE CTION MODULE R, WALL MOUNT CONTROL SYSTE CTION MODULE	EM WITH CEL	LULAR CONNECTIO
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PROJECT NAME

iVista@Alderwood

18799 ALDERWOOD MALL PARKWAY LYNNWOOD, WA 98037

OWNER NAME


ALDERWOOD INVESTMENTS LLC

18799 ALDERWOOD MALL PARKWAY



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SCALE	AS SHOW
PROJECT NUMBER	2023-02iVIST
DESCRIPTION	
IRRIGATION PLA	N -
LEVELS 3 AND 4	
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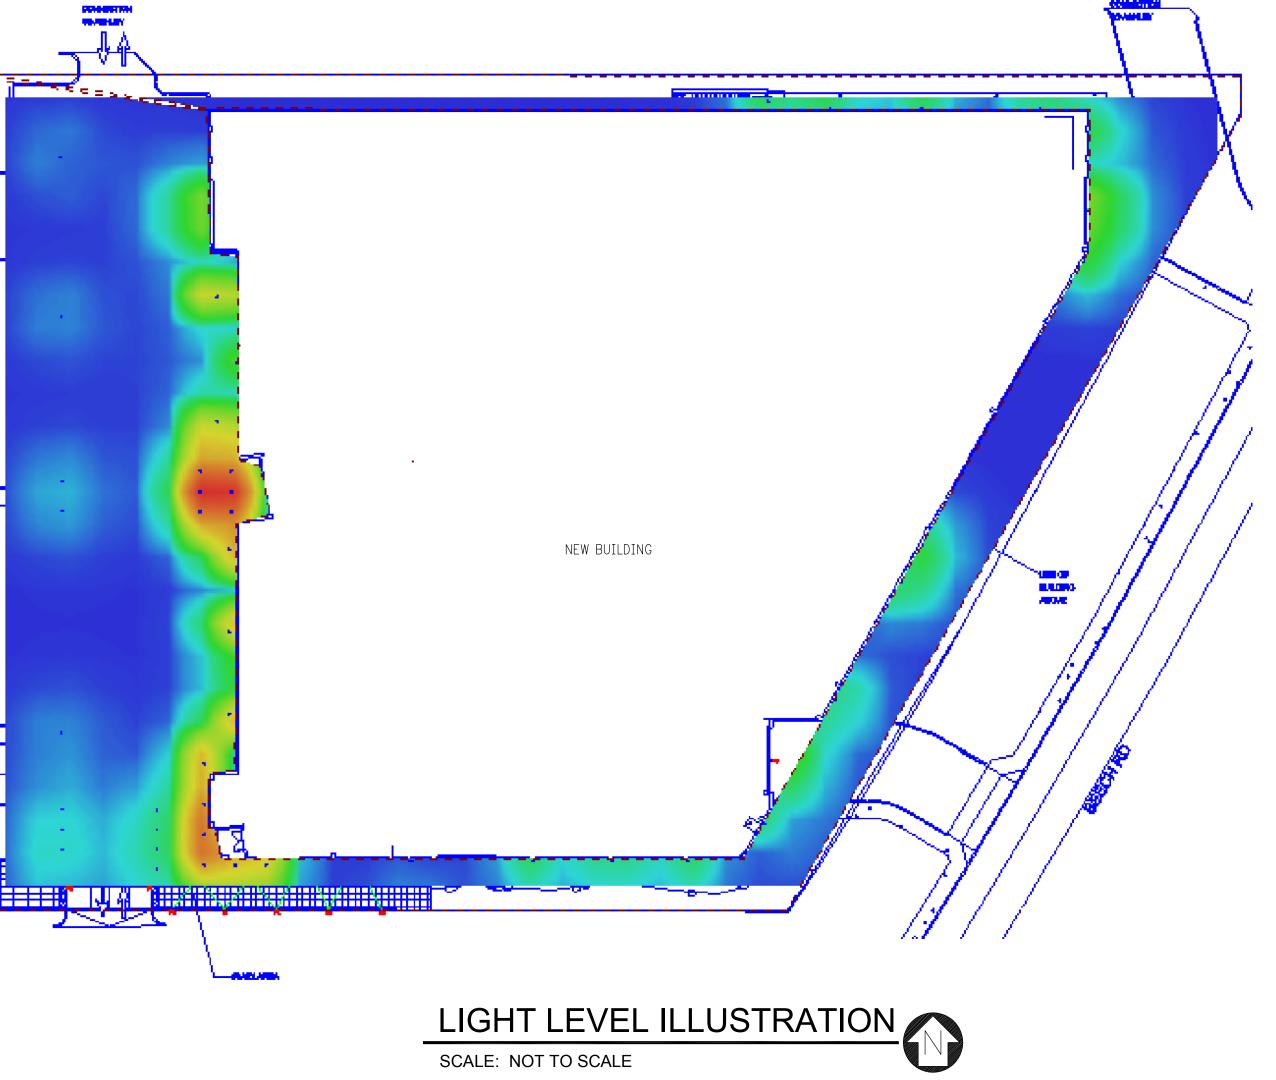
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	LIGHTING FIXTURE SCHEDULE				
TYPE	DESCRIPTION	LAMPS	MOUNTING	MANUFACTURER	VA
EXTER		I	•		
X1	DOWNLIGHT, RECESSED, WET LISTED	LED 4000 LUMENS 3000K	BUILDING OVERHANG, RECESSED	COOPER LIGHTING SOLUTIONS LD8D ER8B 8LB	41.6W
X2	SCONCE, DECORATIVE, OUTDOOR, WITH DOWNLIGHT WIDE MODULE	LED 1294 LUMENS, 3000K	WALL MOUNTED	Betacalco Sentinel II	18W
X3	BOLLARD, BUG RATING: B0-U3-G1, 31.5" HEIGHT, 360 DEGREE LIGHT EMISSION, ROUND, WET LISTED, IP 65	LED 565 LUMENS, 3000K	GROUND ANCHOR	DESIGNPLAN MATITA ROUND	13W
X4	SCONCE, UTILITY. UV RESISTANT POLYCARBONATE MATERIAL. UL746C RATED, FULL CUTOFF.	LED 1607 LUMENS, 3000K	WALL MOUNTED	BROWNLEE LIGHTING SHORE [CUTOFF]	12W
X5	WALL PACK, PARKING GARAGE ENTRY, BUG RATING: B2-U0-G0, MEDIUM HOUSING	LED 3995 LUMENS, 3000K	WALL MOUNTED	COOPER LIGHTING SOLUTIONS LUMARK XTOR CROSSTOUR LED	38W
X6	FESTOON STRING LIGHTS, WARM WHITE V6 "FILAMENT", 1 FOOT BULB SPACING	LED 21.1 LUMENS/BULB 2200K	GROUND ANCHOR TO CANOPY MOUNT	FIREFLY FESTOON FIRFESV6120VE2	0.5W/BULB (109W)
X7	BUILDING FAÇADE, STRING LIGHTING, 84 LUMENS PER FOOT (210 FEET REQUIRED),	LED 12621 LU MENS, XOOOK (VARIABLE)	SOUTH AND WEST ROOF OVERHANG	LUMINII LIGHT PLEXINEON SURFACE MOUNT	5.7W/FOOT (1197W)

Lynnwood Municiple Code (LMC) 21.17 Lighting Zone: LZ-3 Planned Regional Shopping Center (PRC). 21.17.080 Nonresidential Lighting. Method used - Prescriptive Method, Hardscape: 5.0 Lumens per SF. Total hardscape SF: 29757 SF. A.1. Total Site Lumen Limit: Determined by Hardscape Method: 155,285 Lumens (Hardscape method - Table 21.17.04) Lumens allowed Total Hardscape Area Total Lumens Allowed 5.0 LUMENS * 31057 SF = 155,285 Total Allowed Site Lumens = 155,285 A.2. Limits to Off-Site Impacts. All luminaires shall be rated and installed according to Tables 21.17.05 through 21.17.07. Table 21.17.05 Backlight rating Zone LZ-3 B5 - Greater than 2 mounting heights from property line. B4 - 1 to less than 2 mounting heights from property line. B3 - 0.5 to 1 mounting heights from property line. B1 - Less than 0.5 mounting heights from property line. Table 21.17.06 - Max allowed Uplight rating Zone LZ-3 U3 - 0% allowed light emission above 90 degrees for area lighting. Table 21.17.07 - Max allowed Glare rating Zone LZ-3 G3 - Allow ed Glare Rating G1 - Not ideally oriented with 1 to less than 2 mounting heights from property line. G1 - Not ideally oriented with 0.5 to 1 mounting heights from property line. G0 - Not ideally oriented with less than 0.5 mounting heights to property line. A.3. All parking lot lighting shall have no light emitted above 90 degrees.

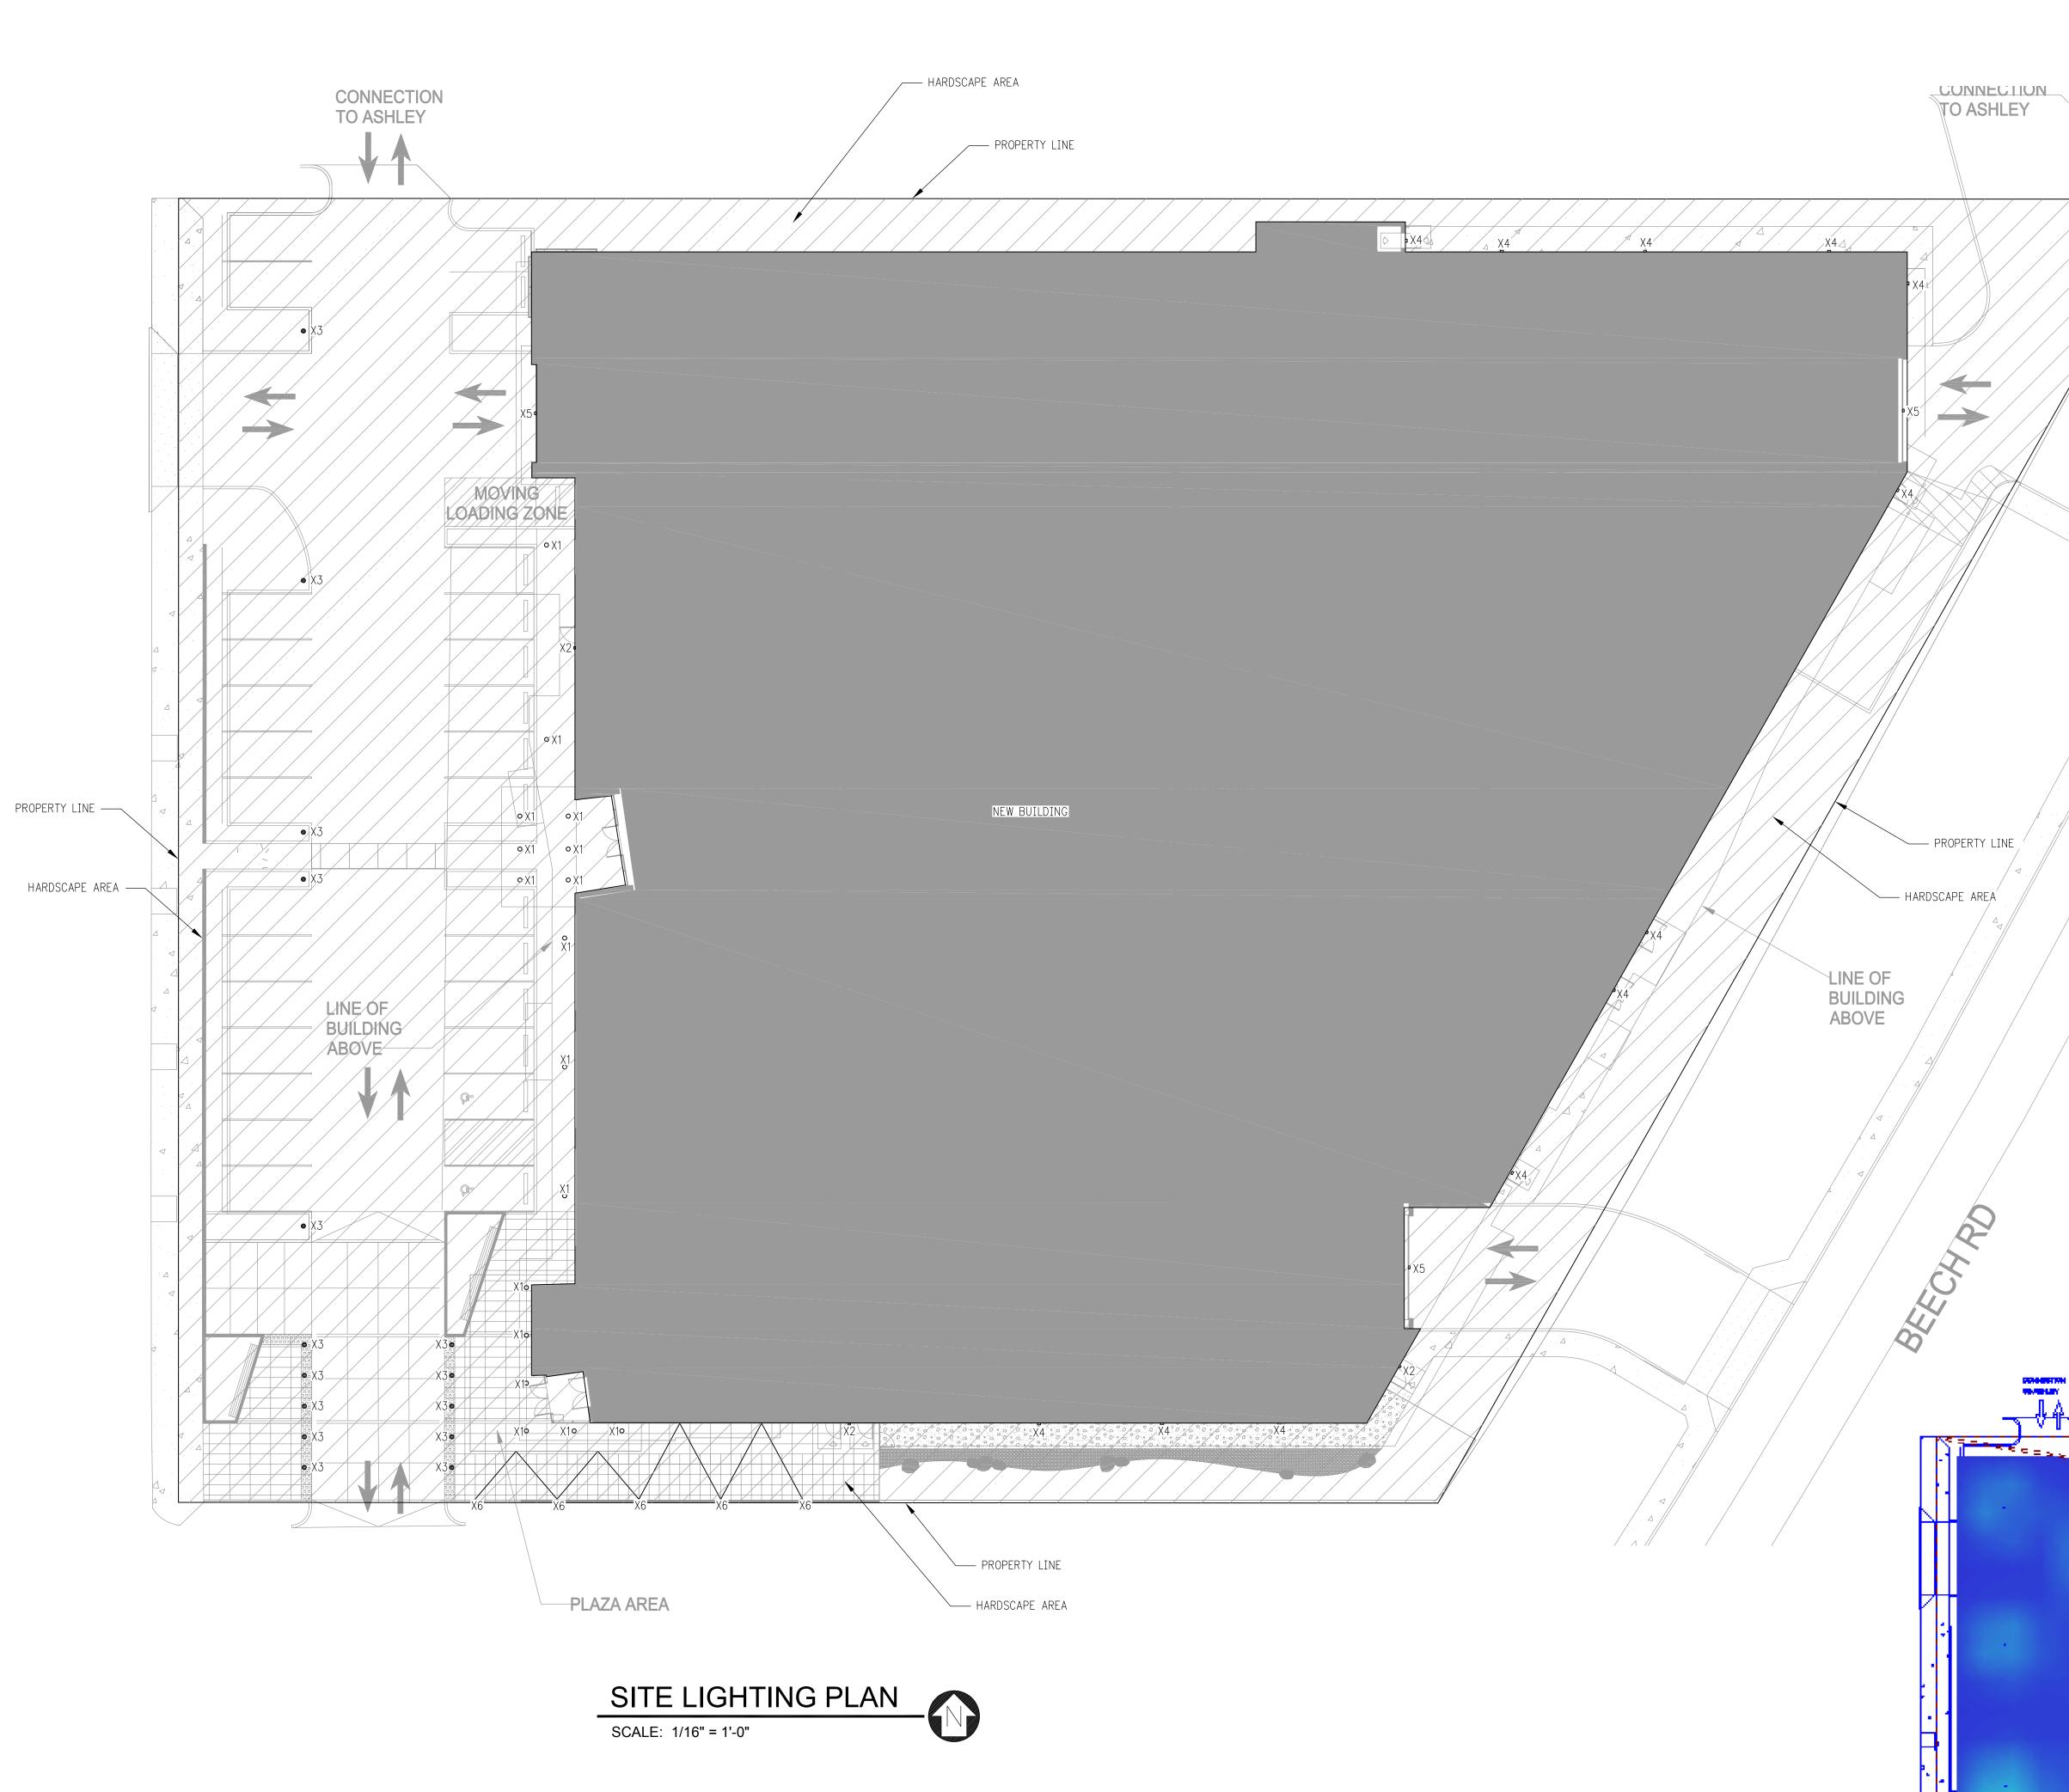	LUMENS WORKSHEET			
MARK	AMOUNT	TYPE	LUMENS	TOTAL
			EACH	LUMENS
X1	17	FIXTURE	5000	85000
X2	3	FIXTURE	1294	3882
Х3	15	FIXTURE	565	8475
X4	12	FIXTURE	1327	15924
X5	3	FIXTURE	3995	11985
X6	210	BULBS @	21.1	4000
Xb	218	1 FT SPACING	21.1	4600
X7	210	LENGTH IN FEET	60.1	12621

TOTAL SITE LUMENS: 142,487





Electrical Consultants, Inc. 19015 36th Avenue West, Suite E Lynnwood, Washington 98036 Phone (425) 775-1799 FAX (425) 774-9870


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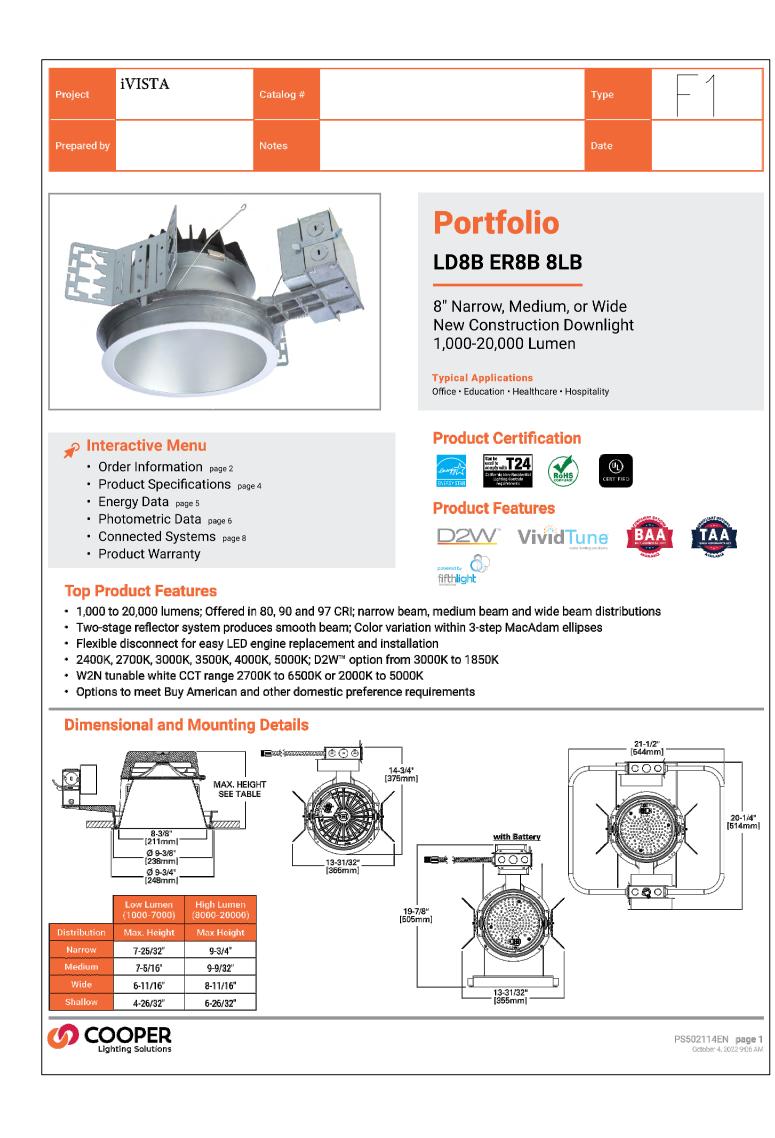



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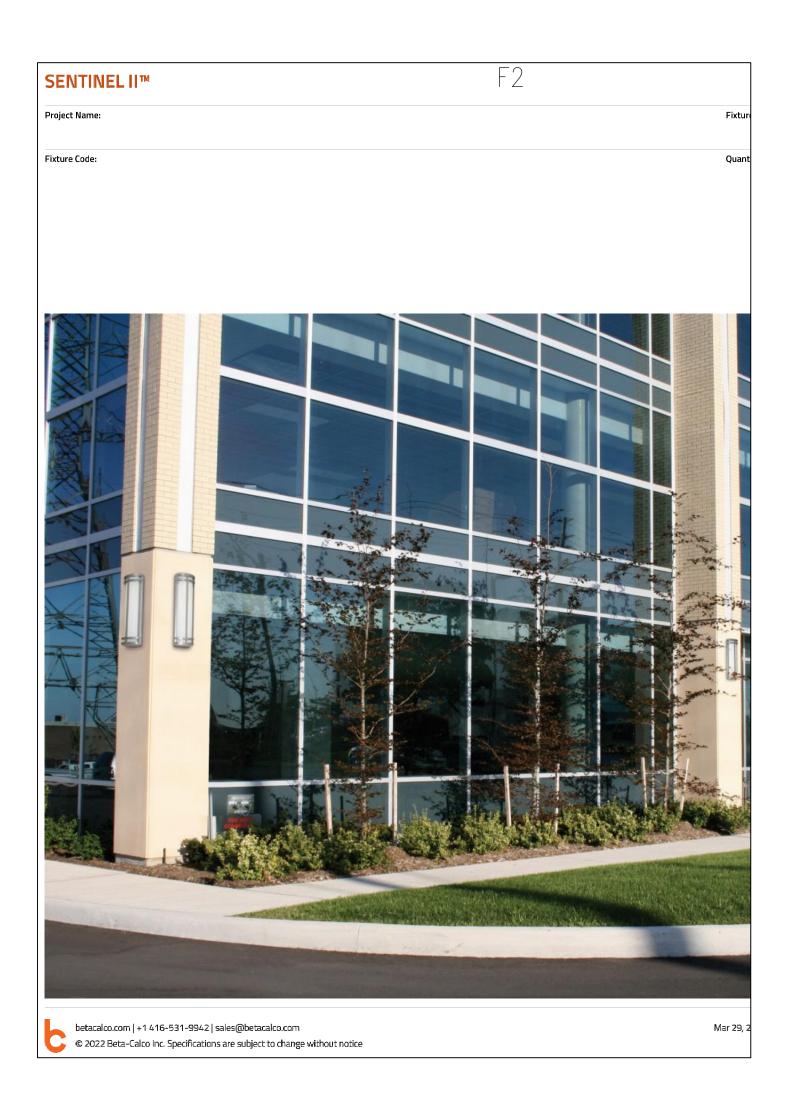
OWNER NAME


ALDERWOOD **INVESTMENTS LLC**







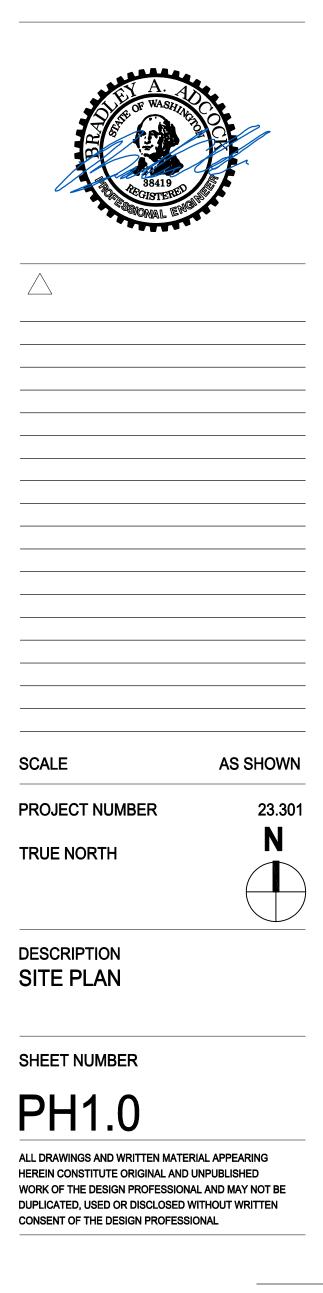

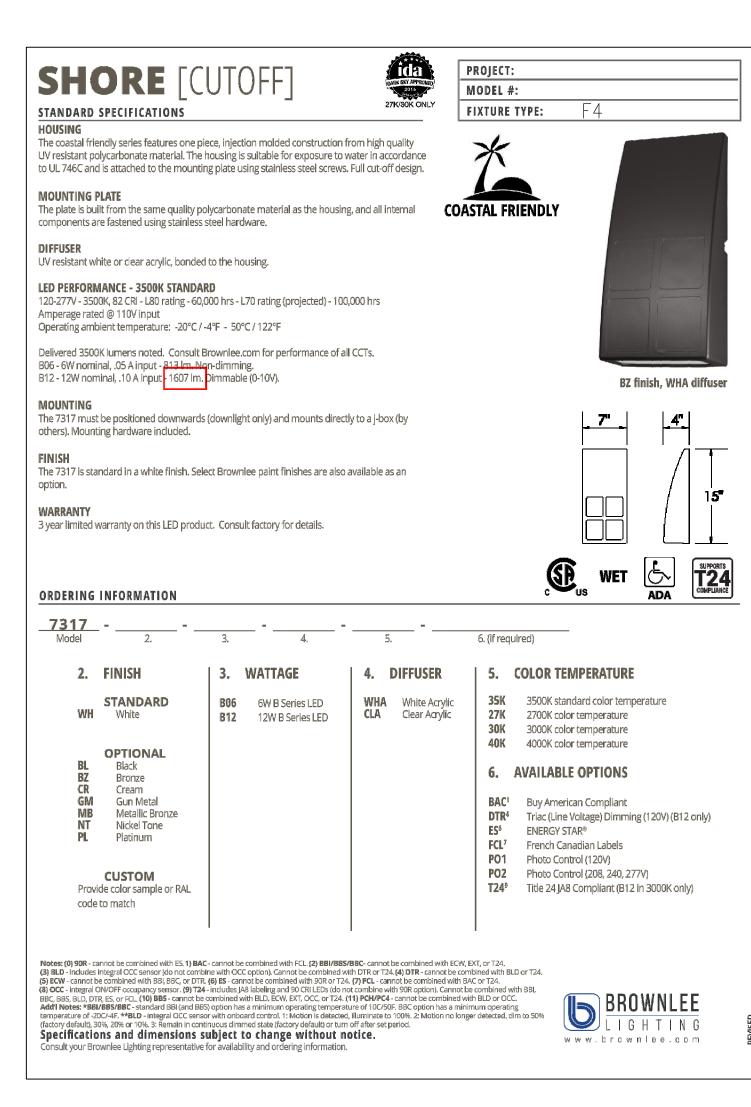

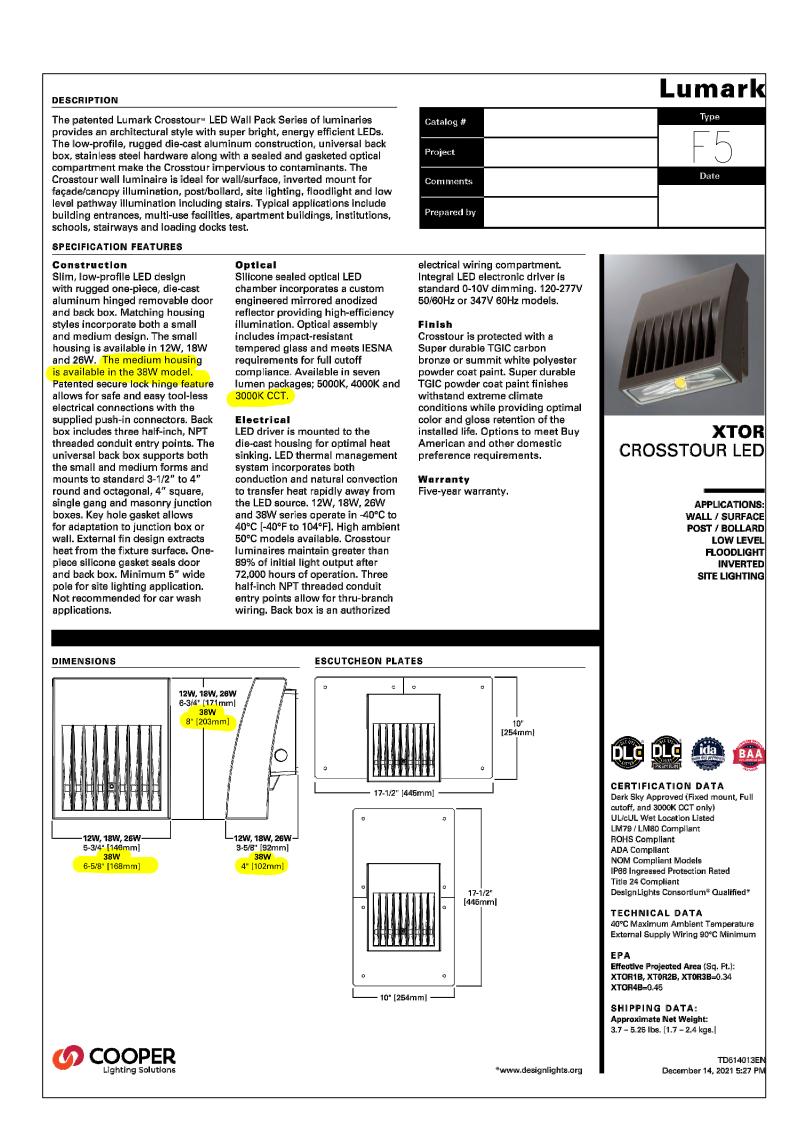

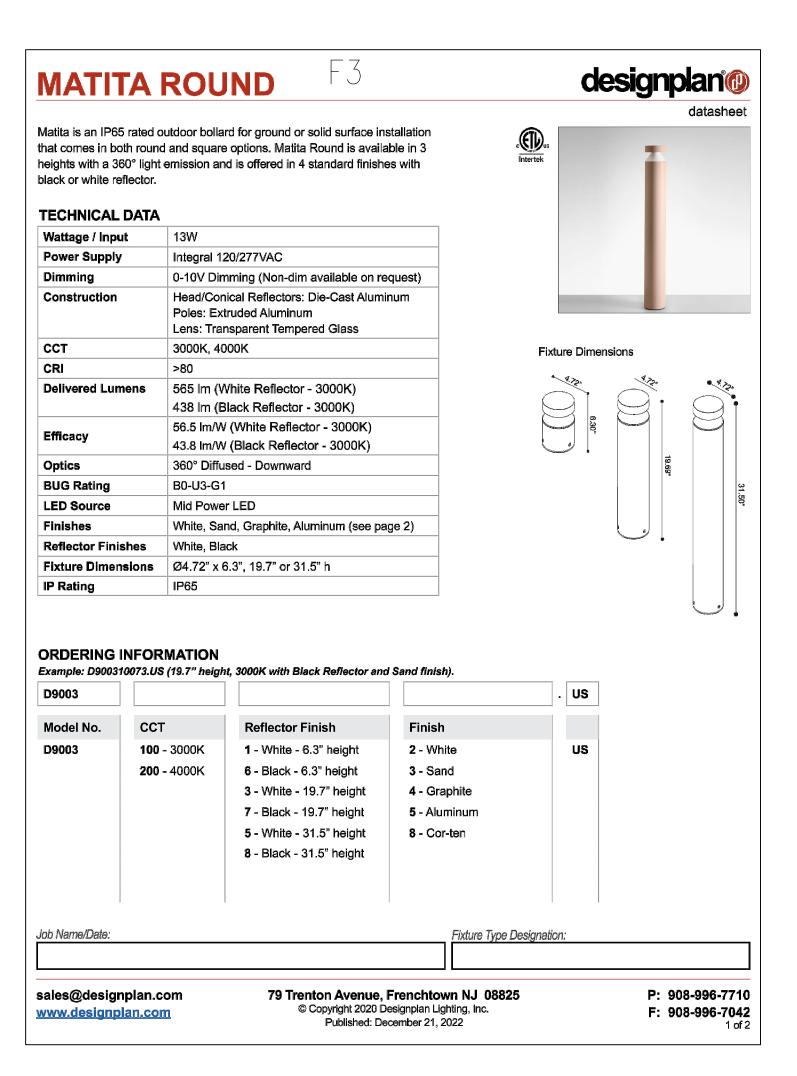

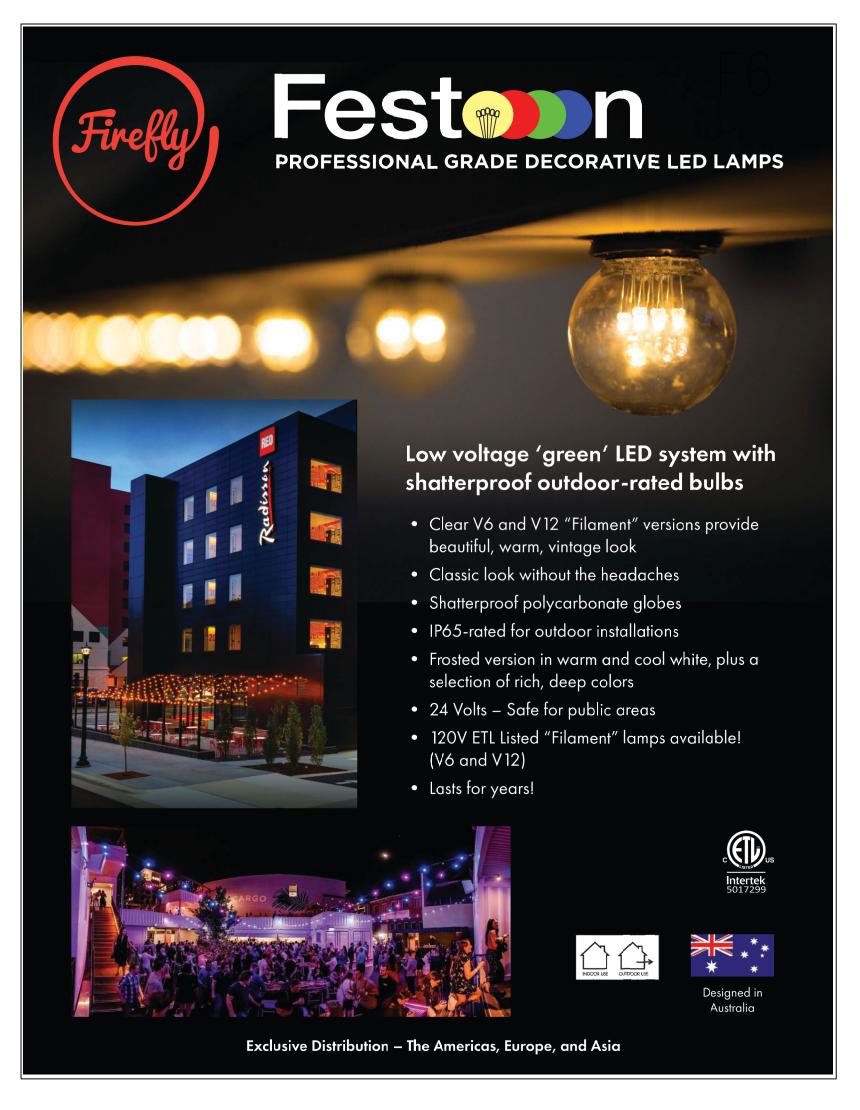



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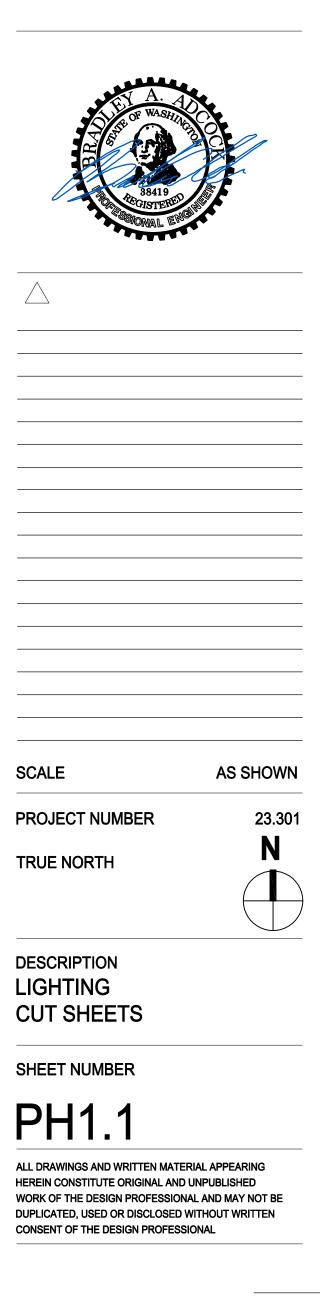
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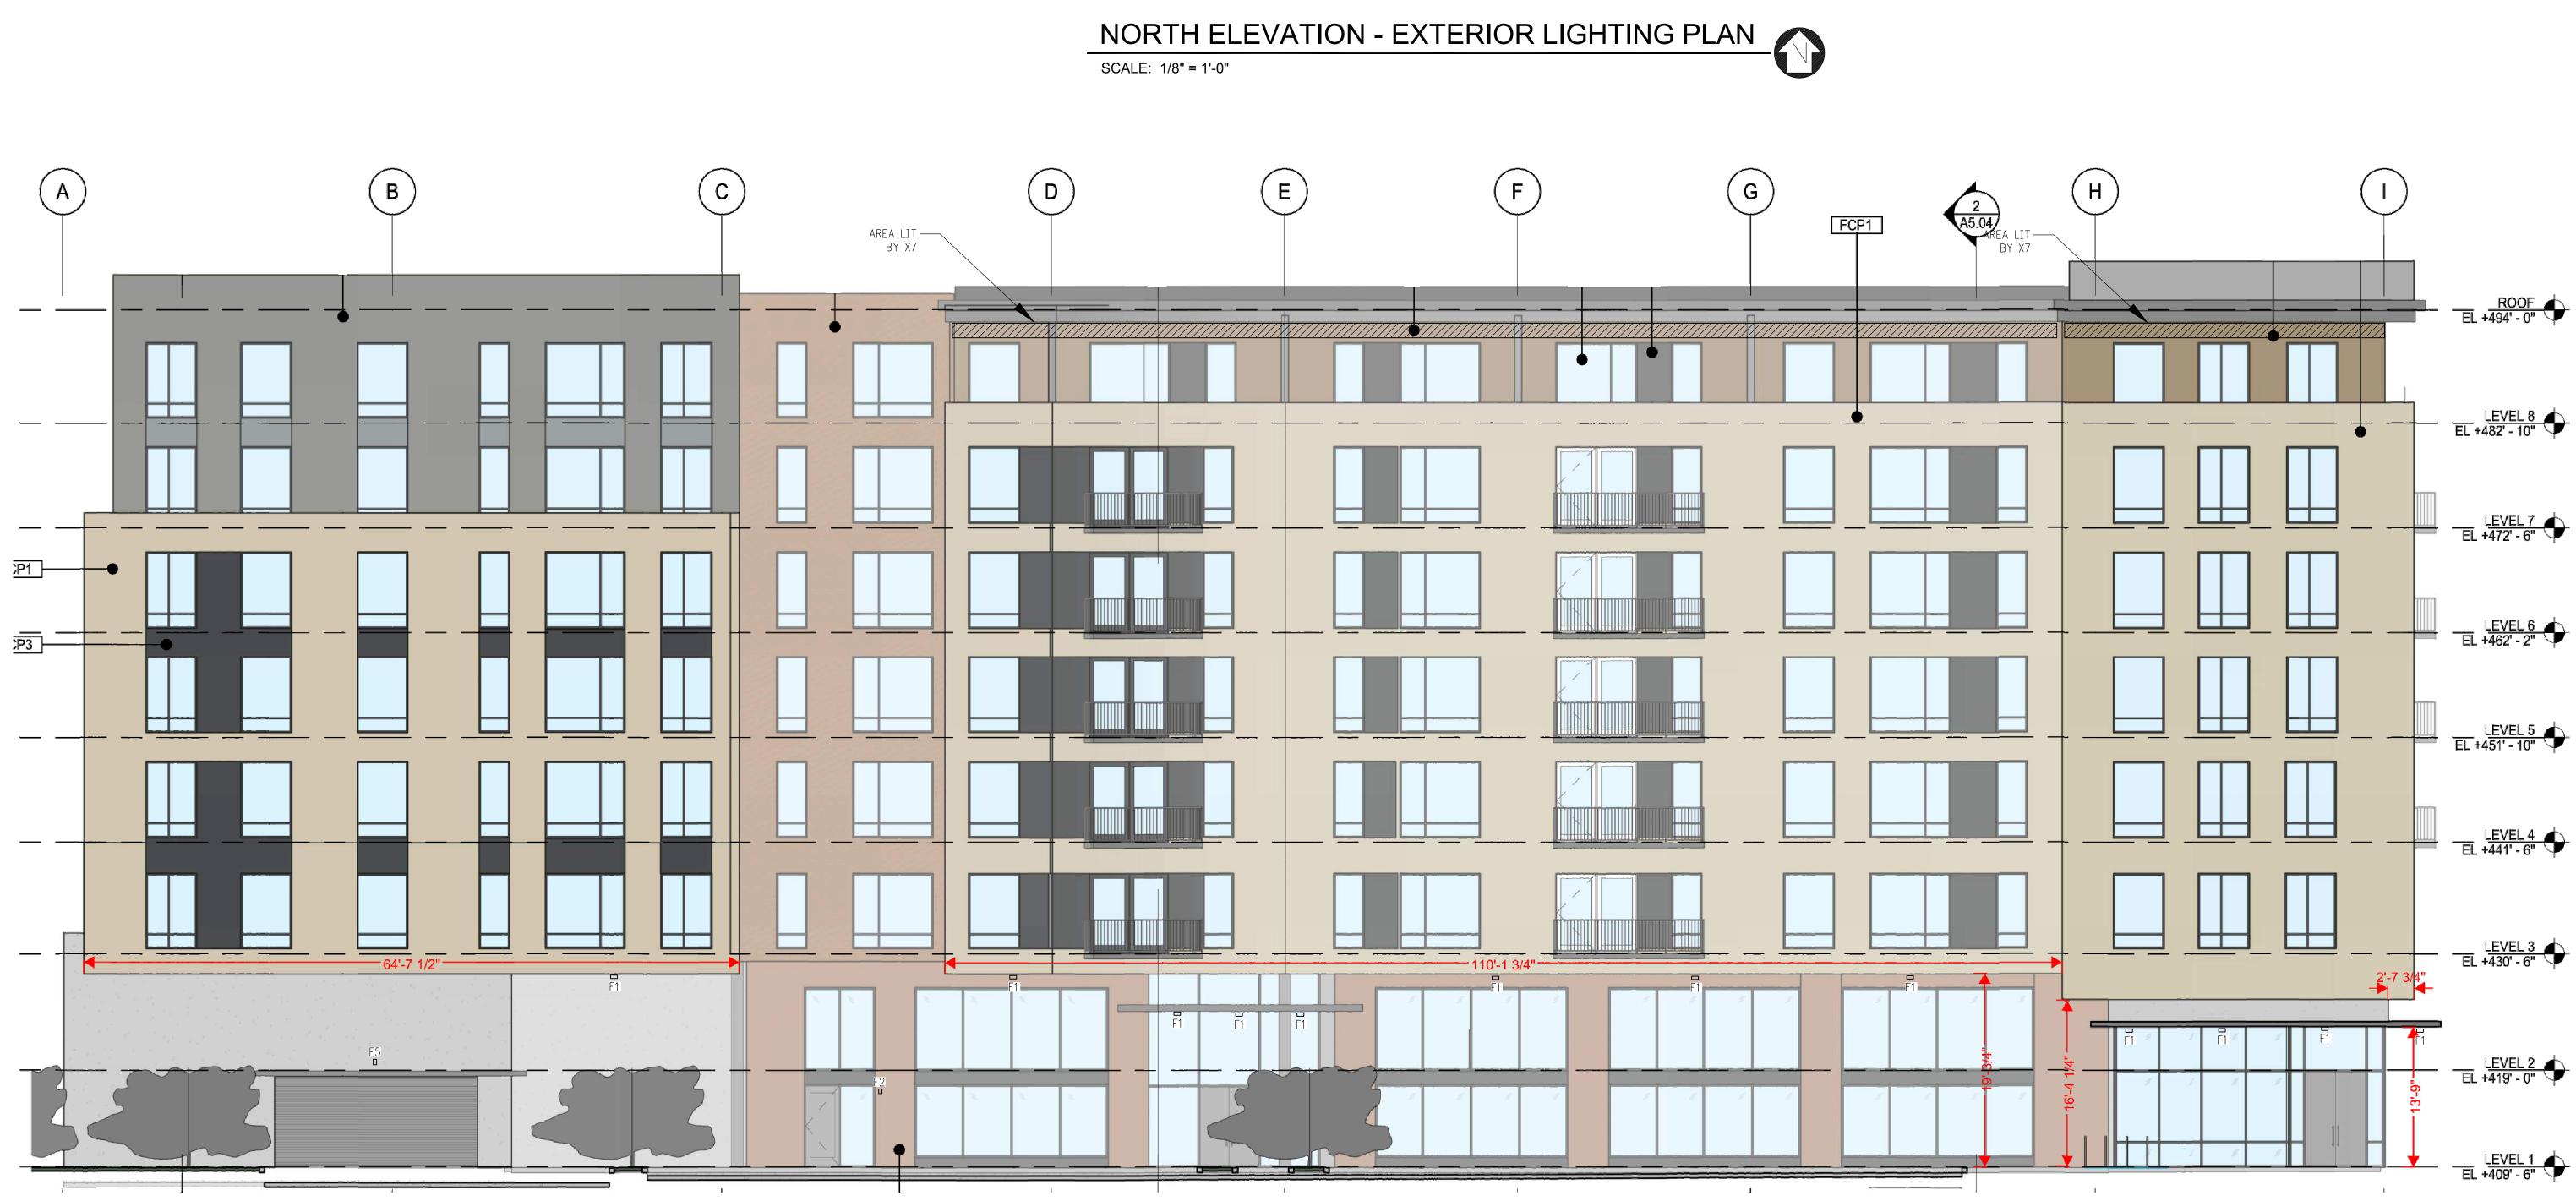
18799 ALDERWOOD MALL PARKWAY LYNNWOOD, WA 98037

OWNER NAME

ALDERWOOD INVESTMENTS LLC



10		9	8	7
F4 0	F40			F4





WEST ELEVATION - EXTERIOR LIGHTING PLAN

SCALE: 1/8" = 1'-0"



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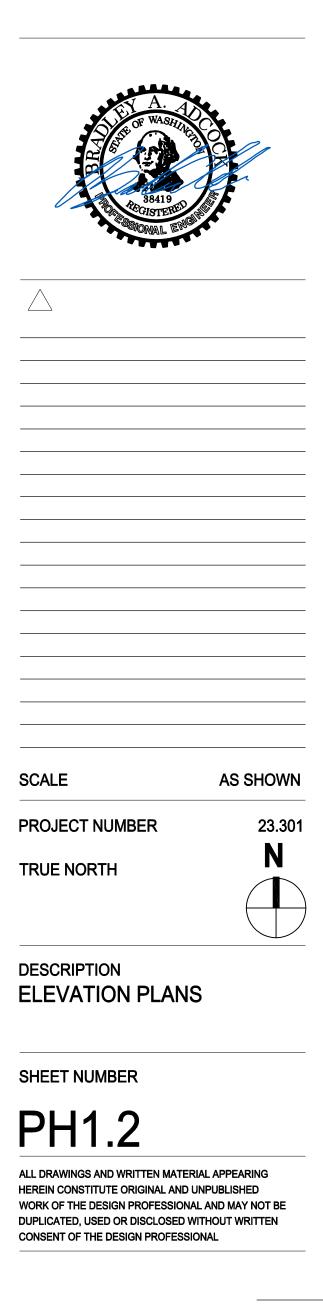
PROJECT NAME



18799 ALDERWOOD MALL PARKWAY LYNNWOOD, WA 98037

OWNER NAME

ALDERWOOD INVESTMENTS LLC





SCALE: 1/8" = 1'-0"



SOUTHEAST ELEVATION - EXTERIOR LIGHTING PLAN

SOUTH ELEVATION - EXTERIOR LIGHTING PLAN

SCALE: 1/8" = 1'-0"

EAST ELEVATION - EXTERIOR LIGHTING PLAN SCALE: 1/8" = 1'-0"

R <u>OOF</u> 4' - 0"	A VV A
V <u>EL 8</u> ' - 10"	Electrical Consultants, Inc. 19015 36th Avenue West, Suite E Lynnwood, Washington 98036 Phone (425) 775-1799 FAX (425) 774-9870
V <u>EL 7</u> 2' - 6"	PROJECT NAME IVISTA ALDERWOOD
V <u>EL 6</u> 2' - 2"	18799 ALDERWOOD MALL PARKWAY LYNNWOOD, WA 98037
V <u>EL 5</u> '- 10"	OWNER NAME ALDERWOOD INVESTMENTS LLC
V <u>EL 4</u> 1' - 6"	18799 ALDERWOOD MALL PARKWAY
V <u>EL 3</u> 0' - 6"	
V <u>EL 2</u> 9' - 0"	
V <u>EL 1</u> 9' - 6"	

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SCALE	AS SHOWN
PROJECT NUMBER	23.301
TRUE NORTH	N
DESCRIPTION ELEVATION PLANS	
SHEET NUMBER	
PH1.3	
ALL DRAWINGS AND WRITTEN MATERIAL AF HEREIN CONSTITUTE ORIGINAL AND UNPUE WORK OF THE DESIGN PROFESSIONAL AND DUPLICATED, USED OR DISCLOSED WITHOU CONSENT OF THE DESIGN PROFESSIONAL	BLISHED MAY NOT BE