LYNNWOOD HOUSE 1



NOTE: 3D RENDERINGS ARE FOR ILLUSTRATIVE PURPOSES ONLY. NOT TO BE USED FOR CONSTRUCTION.

ABBREVIATIONS

FRW FIRE RATE WINDOW

FLOOR AREA RATIO

HVAC HEATING, VENTILATION & A/C

FORCED AIR UNIT

GFA GROSS FLOOR AREA

FIXED

FOOTING

FDN FOUNDATION

HDWD HARDWOOD

HORZ HORIZONTAL

LF LINEAR FEET MANUF MANUFACTURER

INCL INCLUDE (ED)(ING)

LED LIGHT EMITTING DIODE

LOD LIMIT OF DISTURBANCE

FURN FURNACE

HDR HEADER

HT HEIGHT

HR HOUR

INT INTERIOR

MAX MAXIMUM

MED MEDIUM

OC

MECH MECHANICAL

MINIMUM

MISC MISCELLANEOUS

NUMBER

PERF PERFORATED

ON CENTER

NOT IN CONTRACT

NOT TO SCALE

FIXT FIXTURE

FXD

FTG

ABOVE FINISH FLOOR AIR CONDITIONING PLAM PLASTIC LAMINATE POUNDS PER SQUARE FOOT AIR HANDLING UNIT ALT ALTERNATE POUNDS PER SQUARE INCH ALUM ALUMINUM PROPERTY LINE ANOD ANODIZED PROTECTED NATURAL AREA BSMT BASEMENT QTY QUANTITY BLK BLOCK BOTH SIDES BLDG BUILDING REV CABINET R RMCB CATCH BASIN RO SG SIM CLG CEILING CLEAR CLOSET CL CONC CONCRETE SH CMU CONCRETE MASONRY UNIT CONT CONTINUOUS CJ CONTROL JOINT CARPET CSMT CASEMENT CUBIC FOOT DIA DIAMETER DIAMETER BREAST HEIGHT DIMENSION DW DISHWASHER DOUBLE HUNG DN DOWN DS DOWNSPOUT DRYER EΑ EACH ELEC ELECTRICAL TB ELECTRICAL PANEL ELEV ELEVATOR EQ EXT **EQUAL** EXTERIOR EXIST EXISTING FFE FINISH FLOOR ELEVATION FRD FIRE RATE DOOR

REF REFRIGERATOR REQ'D REQUIRED REVISION RISER ROOM **ROUGH OPENING** SAFETY GLASS SIMILAR SINGLE HUNG SOG SLAB ON GRADE SPEC SPECIFICATION SQUARE FOOT STAINLESS STEEL STD STANDARD STL STEEL STOR STORAGE STORM DRAIN SUP SUPPLEMENTAL TV TELEVISION TEMP TEMPORARY TOILET PAPER DISPENSER T&G TONGUE & GROOVE TOP OF TOW TOP OF WALL TOWEL BAR TREAD TPZ TREE PROTECTION ZONE TYPICAL UNO UNLESS NOTED OTHERWISE VAPOR BARRIER VTOS VENT TO OUTSIDE VIF VERIFY IN FIELD VERT VERTICAL VERTICAL GRAIN WATER CLOSET WH WATER HEATER WRB WATER RESISTANT BARRIER WASHER WHF WHOLE HOUSE FAN WIN WINDOW W/ WITH W/O WITHOUT WATER PROOFING YARD

(A)			EXISTING WALL
1	GRID LINES		EXISTING WALL TO DEMO
\boxtimes	PROJECT BASE POINT		2X WALLS
⊕	REFERENCE ELEVATION POINT		FOUNDATION WALL
\bigoplus	PROPERTY CORNER		CONCRETE SURFACE
P	PROPERTY LINE		CAST IN PLACE
Ę	CENTER LINE	<u>.</u>	CONCRETE
T.O.W. 119.12'	TOP OF WALL ELEVATION	\boxtimes \otimes	STRUCTURAL POST - SIZE AND TYPE PER STRUCTURAL PLAN
N 90 00' 00" E	PROPERTY LINE TAG	 _G	GAS OUTLET
Distance	SECTIONS FOUND	GAS	GAS METER
A101	ON SHEET A101	—∦ нв	HOSE BIB
1 A101	DETAIL SECTION FOUND ON SHEET A101	□ DS	DOWNSPOUT
1		METER	ELECTRICAL METER
4 A1.0 2	INTERIOR ELEVATION FOUND ON SHEET A1.0	EP	ELECTRICAL PANEL
3			UNDISTURBED EARTH
			COMPACTED FILL
EXIT	EXIT DIRECTION		GRAVEL
			RIGID OR SPRAY INSULATION
(s)	SMOKE DETECTOR		BIBS BLOWN-IN INSULATION
H	HEAT DETECTOR		STONE
(S/C)	SMOKE & CARBON MONOXIDE DETECTOR		BATT INSULATION
$\langle 1 \rangle$	DOOR TAG NUMBER	- A	EXHAUST FAN
10'-0"x12'-0"	DOOR SIZE	VTOS	VENT TO OUTSIDE
^			WATER METER
⟨A ⟩	WINDOWS TAG NUMBER		STEP DOWN / ELEVATION CHANGE
<u></u>	DRAWING REVISION	,,,,,,,	
(1i)	WALL TAG ASSEMBLY	1	KEY NOTES

WHOLE HOUSE FAN

ENERGY CODE COMPLIANCE - SFR

<u>CONDITIONED FLOOR AREA</u> 1,521.11 SF 1ST FLOOR: 2,229.36 SF 3,750.47 SF < 5,000 SF "MEDIUM DWELLING UNIT" GENERAL PRESCRIPTIVE METHOD: SEE SHEETS A0.2, A0.3 & A5.0

FUEL NORMALIZATION CREDITS PER TABLE R406.2 SYSTEM TYPE 2 -HEAT PUMP

ENERGY CREDITS PER TABLE R406.3 0.5 **OPTION 1.3 BUILDING ENVELOPE** -VERTICAL FENESTRATION U=0.28 -FLOOR R-38 -SLAB R-10 AT PERIMETER AND UNDER ENTIRE **OPTION 2.2 AIR LEAKAGE CONTROL** -AIR LEAKAGE TO MAX 2.0 AIR CHANGES PER

HOUR -WHOLE HOUSE VENTILATION SHALL BE MET WITH HRV MIN. SENSIBLE HEAT RECOVERY EFF. OF 0.65 OPTION 3.5 HIGH EFF. HVAC EQUIPMENT

1.5 -CENTRALLY DUCTED HEAT PUMP WITH MIN HSPF OF 11.0 OPTION 4.1: HIGH EFFICIENCY HVAC DISTRIBUTION 0.5 -AIR HANDLING UNIT TO BE LOCATED IN

CONDITIONED SPACE -DUCT LEAKAGE LIMITED TO 3 CFM PER 100 SF OF CONDITIONED FLOOR AREA OPTION 5.1: EFFICIENT WATER HEATING

-A DRAIN WATER HEAT RECOVERY UNIT WILL BE INSTALLED FOR EQUAL FLOW WITH A MIN. EFF. OF 40%. **OPTION 5.3 EFFICIENT WATER HEATING**

-ENERGY STAR RATED GAS WATER HEATER WITH MIN. UEF OF 0.91. (TANKLESS) **TOTAL CREDITS REQUIRED**

FIRE CALCULATION

TOTAL CREDITS PROPOSED

TOTAL	5,283.17 SF
GARAGE	1,042.85 SF
2ND FLOOR	2,035.79 SF
1ST FLOOR	1,873.61 SF
COVERED PATIO	277.15 SF
COVERED ENTRY	53.77 SF
SPRINKLER THRESHOLD:	5000 SF

6.0

6.0

AUTOMATIC SPRINKLERS PROVIDED: NFPA 13D *SPRINKLER UNDER A SEPARATE PERMIT

PROJECT DATA

OWNER:

NEW CONSTRUCTION OF SINGLE FAMILY

RESIDENCE WITH ATTACHED ACCESSORY DWELLING UNIT AND

ATTACHED GARAGE.

TRIAD HOLDINGS GILL SUKHWINDER 19707 44TH AVE W

LYNNWOOD, WA 98036 P: 425.780.1820 E: GUILL@TRIADHOLDINGS.NET

ARCHITECT: MEDICI ARCHITECTS

> JEN KIM 11711 SE 8TH ST, SUITE 100 BELLEVUE, WA 98005

P: 425.453.9298 E: JENN@MEDICIARCHITECTS.COM

STRUCTURAL ENGINEER: UPSTATE ENGINEERING INC.

ANDY GAHAN 22002 64TH AVE W SUITE 2C MOUNTLAKE TERRACE, WA 98043 P: 206.280.4715 E: ANDY@UPST8.COM

CIVIL ENGINEER: TATU CONSULTING ENGINEERS

SHAILESH TATU 18402 46TH PL W LYNNWOOD, WA 98037

P: 206.900.4899 E: SHAILESH TATU@HOTMAIL.COM

SURVEYOR: DALEY-MORROW-POBMETE, INC.

JUSTIN EMERY 726 ABURN WAY NORTH AUBURN, WAY 98002 P: 253.333.2200 E: DMP@DMP-INC.COM

GEOTECH: AMERICAN GEOSERVICES

SAM ADETTIWAR 24 ROY STREET #343 SEATTLE, WA 98109 P: 888.276.4027

E: SMA@AMERICANGEOSERVICES.COM

ENERGY CODE COMPLIANCE - ADU

CONDITIONED FLOOR AREA 1ST FLOOR:

TOTAL: 617.71 SF < 1,500 SF

TOTAL FENISTRATIONS 94.5 SF < 300 SF "SMALL DWELLING UNIT"

GENERAL PRESCRIPTIVE METHOD: SEE SHEETS A0.2. A0.3 & A5.0

FUEL NORMALIZATION CREDITS PER TABLE R406.2 SYSTEM TYPE 2 1.0 CREDITS

-HEAT PUMP **ENERGY CREDITS PER TABLE R406.3** 0.5 OPTION 1.3 BUILDING ENVELOPE -VERTICAL FENESTRATION U=0.28

-FLOOR R-38 -SLAB R-10 AT PERIMETER AND UNDER ENTIRE **OPTION 2.2 AIR LEAKAGE CONTROL** -AIR LEAKAGE TO MAX. 2.0 AIR CHANGES PER

-WHOLE HOUSE VENTILATION SHALL BE MET WITH HRV. MIN. SENSIBLE HEAT RECOVERY EFF. OF .65 OPTION 5.3 EFFICIENT WATER HEATING

-ENERGY STAR RATED GAS WATER HEATER WITH MIN. UEF OF 0.91. (TANKLESS)

TOTAL CREDITS REQUIRED 3.0 TOTAL CREDITS PROPOSED 3.5

CODE INFORMATION

ALL MATERIALS, WORKMANSHIP, DESIGN AND CONSTRUCTION SHALL CONFORM TO THE DRAWINGS, SPECIFICATIONS, AND THE FOLLOWING APPLICABLE CODES USED IN THIS DESIGN FOR CITY OF LYNNWOOD.


2018 WASHINGTON STATE RESIDENTIAL CODE (IRC) 2018 WASHINGTON STATE MECHANICAL CODE (INC) 2018 INTERNATIONAL FUEL GAS CODE (NATURAL GAS) (IFGC) 2018 NATIONAL FUEL GAS CODE 58 (PROPANE) (NFPA 54) 2018 INTERNATIONAL SWIMMING POOL AND SPA CODE (ISPSC) 2018 UNIFORM PLUMBING CODE (UPC) 2018 WASHINGTON STATE ENERGY CODE - RESIDENTIAL

PROVISIONS (WSEC - RESIDENTIAL) 2018 WASHINGTON STATE FIRE CODE (IFC) 2020 WASHINGTON CITIES ELECTRICAL CODE



PROJECT LOCATION

VICINITY MAP 1/4" = 1'-0"

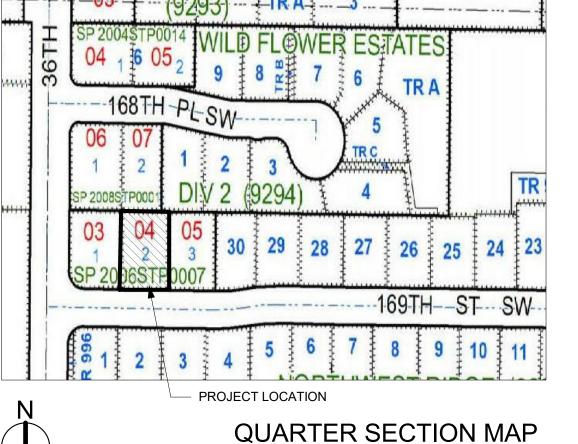

INDEX OF DRAWINGS

TITLE SHEET & SYMBOLS 1 OF 1

ARCHITECTURAL SHEET INDEX

SITE PLAN A1.0 FOUNDATION PLAN A2.0 1ST FLOOR PLAN A2.1 2ND FLOOR PLAN A3.0 **ROOF PLAN** A4.0 **ELEVATIONS** A4.1 **ELEVATIONS**

A4.2 **PERSPECTIVES** A4.3 **ELEVATIONS - MATERIALS / COLORS ELEVATIONS - MATERIALS / COLORS**



11711 SE 8TH STREET SUITE 100 BELLEVUE, WA 98005

200 W. RIVER ST. SUITE 301 KETCHUM, ID 83340 TEL: (425) 453-9298 TEL: (208) 726-0194

REGISTRATION



INTA	NTAKE DATE: 04/22/20		22
REVI	SIONS:	DATE:	

PROJECT / CLIENT:

LYNNWOOD HOUSE '

TRIAD HOLDINGS

PROJECT ADDRESS: 3515 169TH AVE SW LYNNWOOD, WA 98037

DRAWING NAME:

TITLE SHEET

DRAWN BY: KKH CHECKED By: JK

PHASE:

ADU LAND USE


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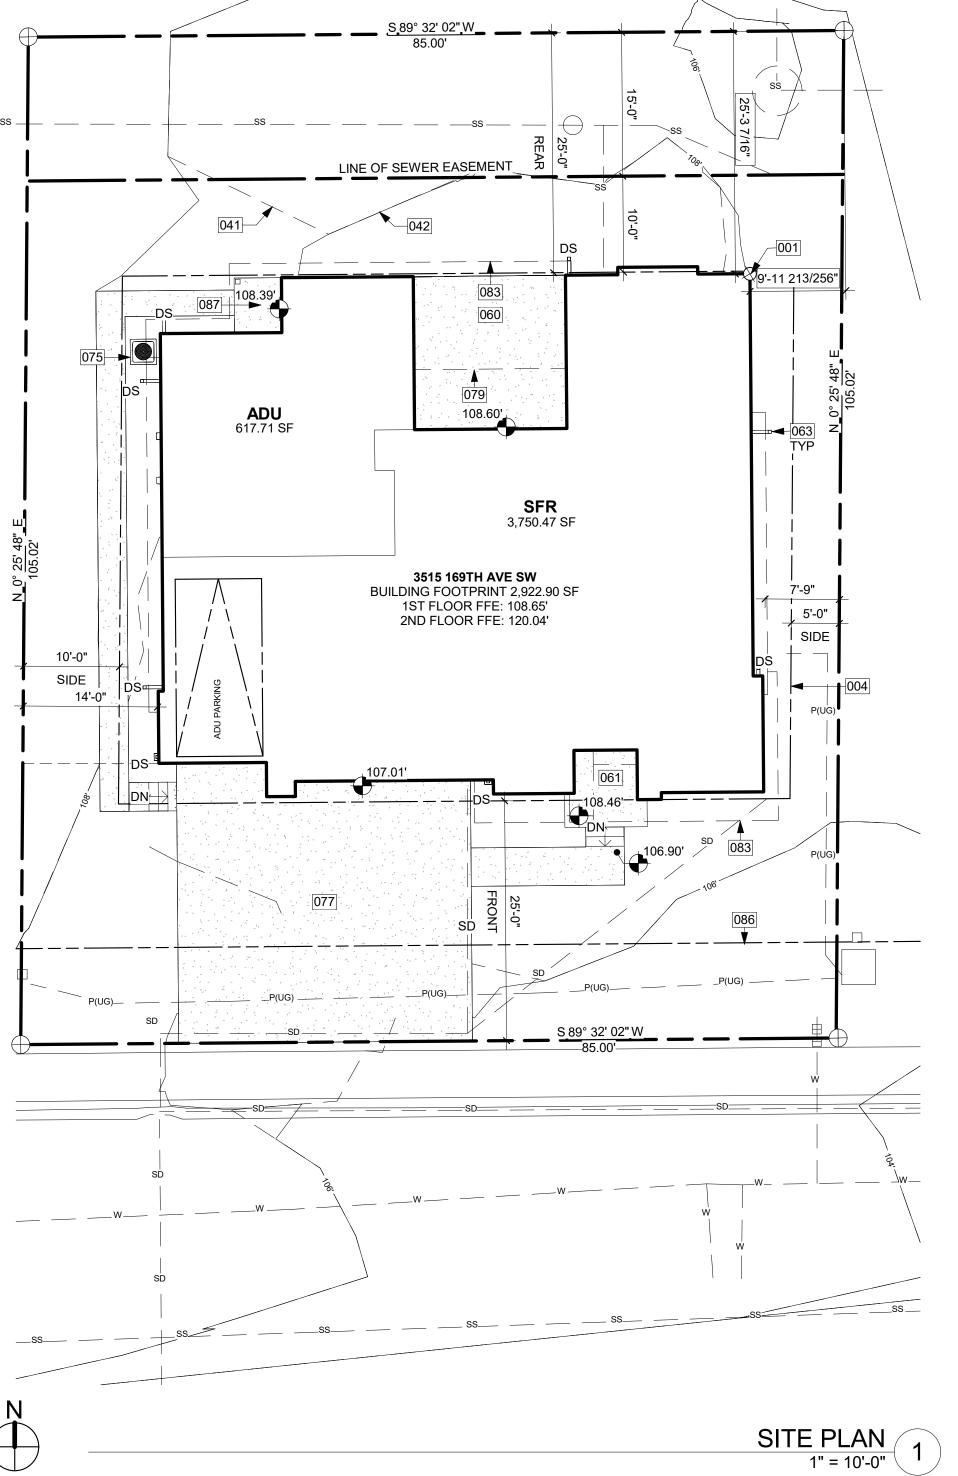
APPROVED FOR CONSTRUCTION:

DEFERRED SUBMITTAL

THE FOLLOWING ITEMS ARE CONSIDERED TO BE A DEFERRED SUBMITTAL UNDER SECTION 107.3.4.1 OF THE IBC AND MUST BE SUBMITTED TO THE ENGINEER FOR REVIEW. THESE ITEMS WILL THEN BE FORWARDED TO THE BUILDING OFFICIAL FOR APPROVAL. THE DEFERRED SUBMITTAL ITEMS SHALL NOT BE INSTALLED UNTIL THE DESIGN AND SUBMITTAL DOCUMENTS HAVE BEEN APPROVED BY THE BUILDING OFFICIAL. *HANDRAILS *GUARDRAILS

PROJECT No.: A21 068 DATE: 6/13/2023



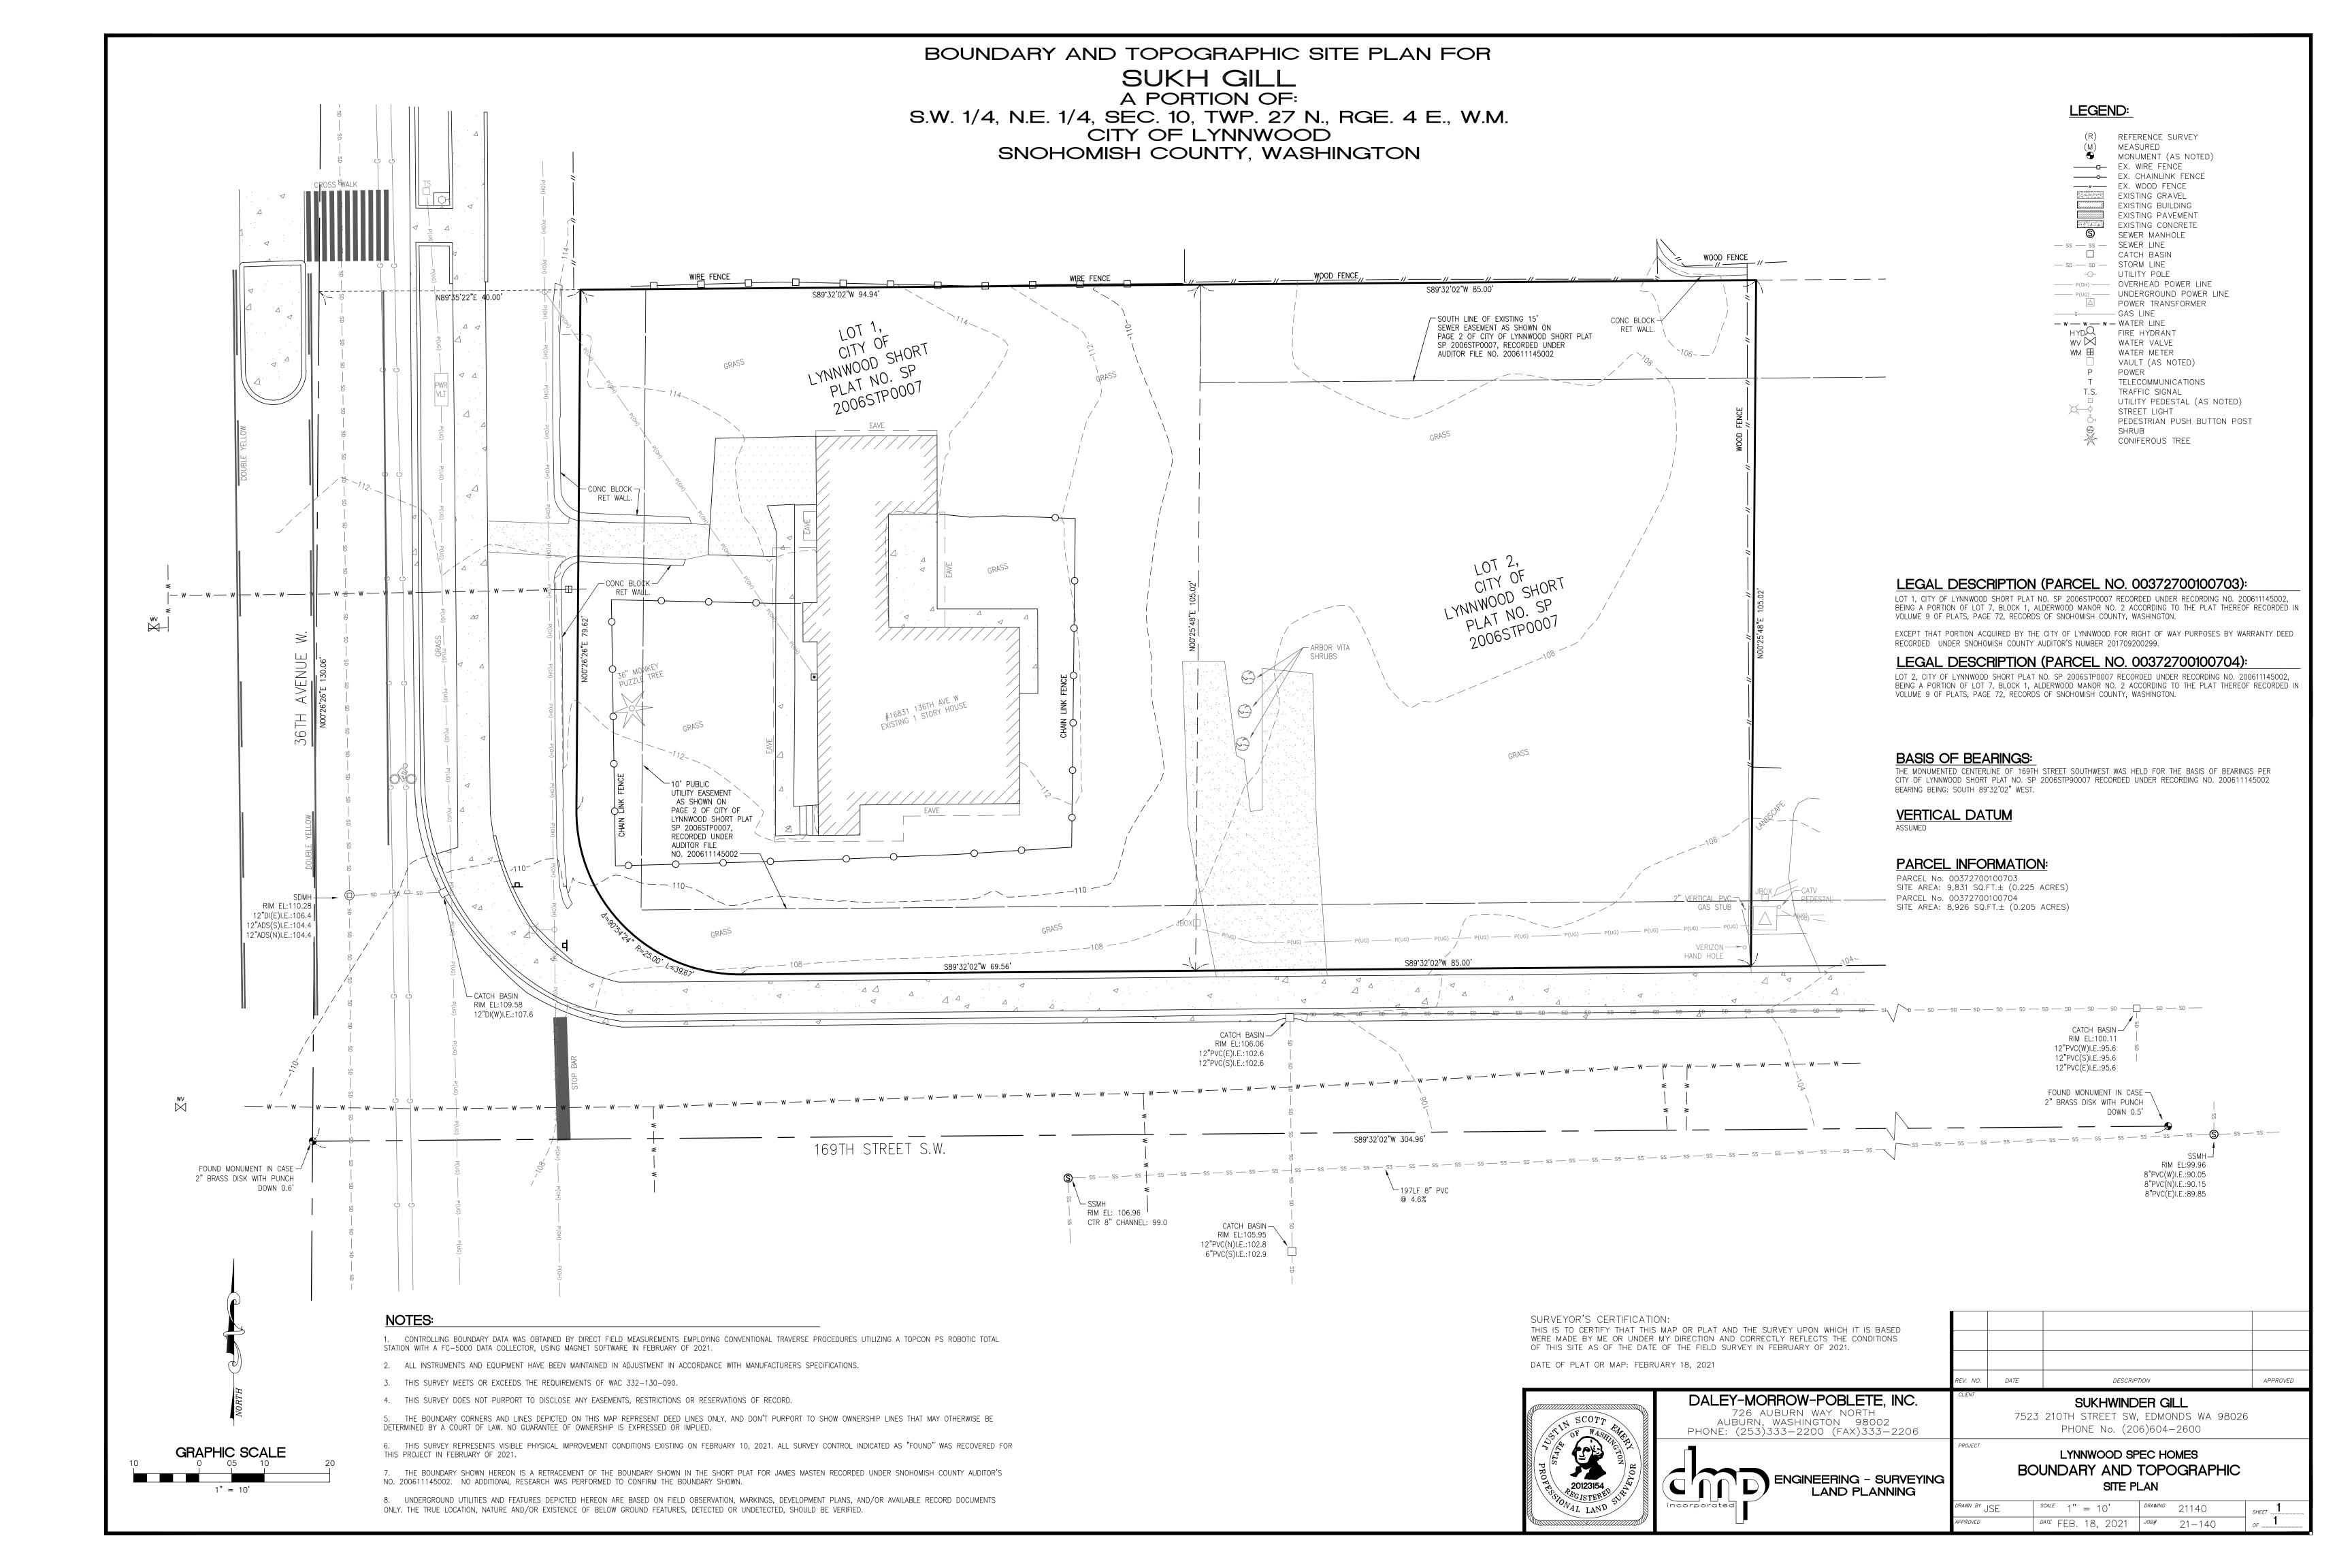

087 ADU ENTRY

001 PROJECT BASE POINT

004	SETBACK LINE.
041	LINE OF EXISTING GRADE, PER SURVEY.
042	LINE OF PROPOSED GRADE, PER CIVIL.
060	PROPOSED AT-GRADE CONCRETE PATIO, PER PLANS.
061	FRONT ENTRY TO SFR.
063	DOWNSPOUT, TIGHTLINE TO STORMWATER SYSTEM, PER CIVIL.
075	CONCRETE SLAB OVER COMPACTED EARTH FOR OUTDOOR HVAC UNIT, OR PE MANUFACTURER'S RECOMMENDATION.
077	DRIVEWAY SLOPE PER CIVIL.
079	LINE OF BUILDING ABOVE.
083	LINE OF ROOF ABOVE OR AWNING ABOVE.
086	LINE OF 10' PUBLIC UTILITY EASEMENT PER SURVEY. 00 SITE PLAN

ZONING REQUIREMENTS

JURISDICTION: CITY OF LYNNWOOD RS-8
PARCEL ASSESSOR'S #: 00372700100704
LOT SIZE: 8,926 SF = 0.205 ACRE

LEGAL DESCRIPTION:

SECTION 10 TOWNSHIP 27 RANGE 04 QUARTER NE ALDERWOOD MANOR 2 BLK 001 D-04-LOT 2 CITY OF LYN SP 2006STP0007 REC AFN 200611145002

MAXIMUMS:


MAX. FAR: N/A MAX. LOT COVERAGE: 35% (3,049.2 SF) MAX. HEIGHT: 35' ABOVE ABE

SETBACKS:

REQUIRED FRONT: MIN. 25' PROVIDED: 25' REQUIRED SIDE: MIN. 5'/10' PROVIDED: 5'/10' REQUIRED REAR: MIN. 25' PROVIDED: 25'

NOTE:

THE ACCESSORY DWELLING UNIT SHOWN ON THIS PLAN SHALL NOT BE SOLD AS A SEPARATE PROPERTY OR AS A CONDOMINIUM, OR IN ANY WAY BE PART OF A SUBDIVISION OF THE LOT UPON WHICH IT IS LOCATED UNLESS THAT SUBDIVISION CONFORMS WITH ALL PROVISIONS OF THE LYNNWOOD MUNICIPAL CODE.

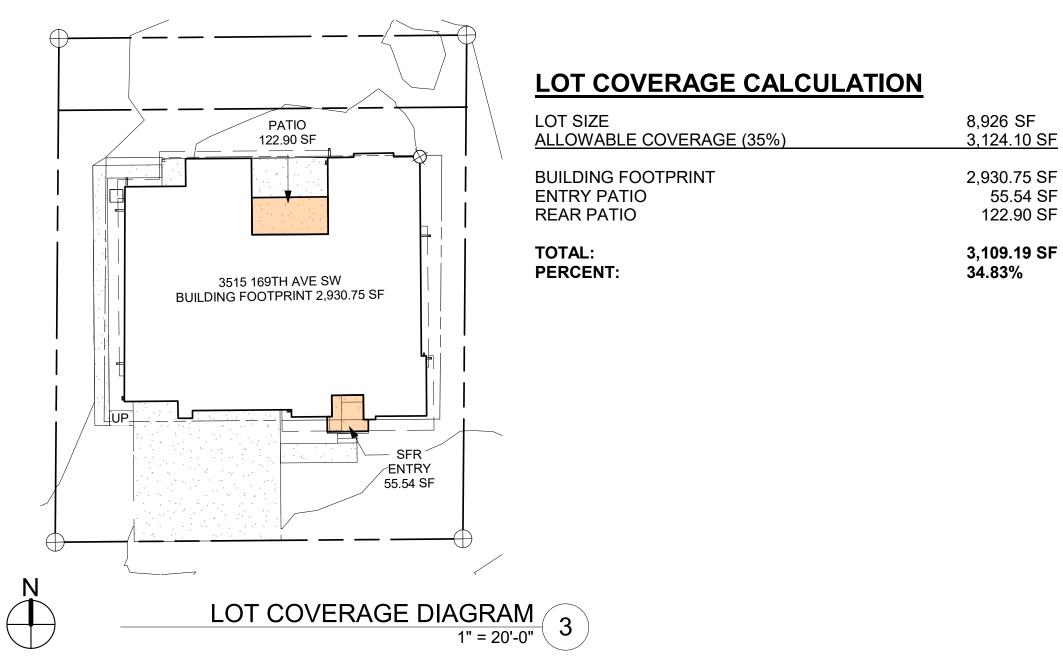

TREE PROTECTION GUIDELINES

ALL REMAINING TREES ARE TO HAVE A TREE PROTECTION ZONE (TPZ) ESTABLISHED BEFORE COMMENCEMENT OF ANY CONSTRUCTION OR DELIVERY ACTIVITIES. THE FOLLOWING GUIDELINES ARE TO BE OBSERVED AND PRACTICED DURING ALL CONSTRUCTION ACTIVITIES.

- 1. ACCESS IS TO BE RESTRICTED INTO TPZ'S WITH READILY VISIBLE TEMPORARY TREE FENCING ALONG THE LOD WHICH COMPLETELY SURROUNDS THE PROTECTED AREAS OF RETAINED TREES. FENCES SHALL BE CONSTRUCTED OF CHAIN LINK AND BE AT LEAST 4 FT TALL, CONSTRUCTED USING PIER BLOCK, AND MAJOR ROOTS SHOULD BE AVOIDED WHILE STAKING.
- HIGHLY VISIBLE SIGNS SPACED NO FURTHER THAN 15
 FEET SHALL BE PLACED ALONG SIDES OF THE TPZ
 FENCING.
- 3. CONSTRUCTION MATERIALS OR SUPPLIES, SOIL, DEBRIS, VEHICLES, AND EQUIPMENT ARE NOT TO BE PARKED OR STORED WITHIN TPZ.
 - TPZ FENCES MUST BE INSPECTED PRIOR TO THE BEGINNING OF ANY CONSTRUCTION ACTIVITIES.
- ASSESS CREW AND CONTRACTOR PENALTIES, IF NECESSARY, TO KEEP THE TPZ'S INTACT.
- . CHECK THE INTEGRITY OF TPZ FENCES WEEKLY, AND
- REPAIR OR REPLACE AS NEEDED.

 7. WOOD CHIPS SHOULD BE USED IF POSSIBLE TO SPREAD ABOVE ROOT ZONES WITHIN THE TPZ'S TO A DEPTH OF
- 6-8 INCHES FOR TEMPORARY PROTECTION.

 8. CEMENT TRUCKS MUST NOT DEPOSIT WASTE OR RINSE
- 9. AVOID GRADE CHANGES OR TRENCHING WITHIN OR NEAR THE TPZ. IF IT IS UNAVOIDABLE, THEN FOLLOW THE GUIDELINES BELOW.

OUT TRUCKS IN THE TPZ.

- 10. TPZ'S MAY ONLY BE MOVED OR ACCESSED WITH PERMISSION FROM CITY OFFICIALS, AND ANY WORK DONE WITHIN TPZ'S MUST BE DONE WITH A CERTIFIED ARBORIST PRESENT.
- 11. IF ROOTS NEED TO PRUNED, THEY SHOULD BE CUT WITH PRUNING SAWS, MADE FLUSH WITH THE SIDE OF THE TRENCH.
- 12. TREES SHOULD BE WATERED TWICE A WEEK IF CONSTRUCTION IS TO TAKE PLACE DURING HOT SUMMER MONTHS

IF EXCAVATION OCCURS WITHIN THE DRIPLINES OF TREES SCHEDULED FOR RETENTION, THE FOLLOWING PROCEDURES MUST BE FOLLOWED TO PROTECT THEM:


- 1. THE CONTRACTOR SHALL VERIFY THE VERTICAL AND HORIZONTAL LOCATION OF EXISTING UTILITIES TO AVOID CONFLICTS AND MAINTAIN MINIMUM CLEARANCES; ADJUSTMENT SHALL BE MADE TO THE GRADE OF THE NEW UTILITY AS REQUIRED.
- 2. THE INNER ROOT ZONE SHALL NOT BE DISTURBED OR CUT (INNER ROOT ZONE = HALF THE DRIP LINE RADIUS).
- CUT (INNER ROOT ZONE = HALF THE DRIP LINE RADIUS).

 3. ISA CERTIFIED ARBORIST MUST WORK WITH EQUIPMENT OPERATORS DURING TRENCHING/ EXCAVATION. THE

ARBORIST SHOULD HAVE A SHOVEL, HAND PRUNERS,

- LOPPERS, HANDSAW, AND A SAWSALL.

 4. IF ROOTS ONE INCH OR LARGER ARE DAMAGED BY EQUIPMENT, THE ARBORIST SHALL STOP THE EQUIPMENT AND HAVE THE DIRT EXCAVATED BY HAND UNTIL THE ROOT CAN BE CLEANLY CUT. A CLEAN STRAIGHT CUT SHALL BE MADE TO REMOVE THE DAMAGED PORTION OF ROOT, AND IF POSSIBLE THE ROOTS SHOULD BE COVERED IN MOIST BURLAP UNTIL RECOVERED WITH DIRT THE SAME DAY.
- 5. BORING OR TUNNELING UNDER ROOTS OF EXISTING TREES IS A VIABLE ALTERNATIVE TO TRENCHING THROUGH ROOTS. IT SHALL BE PERFORMED UNDER THE SUPERVISION OF AN ISA CERTIFIED ARBORIST, AND NO ROOTS 1 INCH IN DIAMETER OR LARGER SHALL BE CUT.
- 6. THE GRADE SHALL NOT BE ELEVATED OR REDUCED WITHIN THE CRITICAL ROOT ZONE OF TREES TO BE PRESERVED WITHOUT THE PLANNING OFFICIAL'S AUTHORIZATION BASED ON RECOMMENDATIONS FROM A QUALIFIED PROFESSIONAL. THE PLANNING OFFICIAL MAY ALLOW COVERAGE OF UP TO ONE HALF OF THE AREA OF THE TREE'S CRITICAL ROOT ZONE WITH LIGHT SOILS (NO CLAY) TO THE MINIMUM DEPTH NECESSARY TO CARRY OUT GRADING OR LANDSCAPING PLANS, IF IT WILL NOT IMPERIL THE SURVIVAL OF THE TREE. AERATION DEVICES MAY BE REQUIRED TO ENSURE THE TREE'S SURVIVAL.

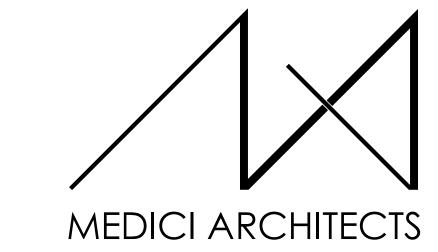


11711 SE 8TH STREET SUITE 100 BELLEVUE, WA 98005 TEL: (425) 453-9298

STREET 200 W. RIVER ST. SUITE 301 \$98005 KETCHUM, ID 83340 9298 TEL: (208) 726-0194

04/22/2022

REGISTRATION:

INTAKE DATE:

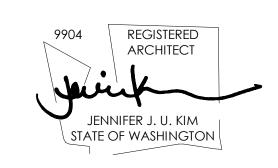

EVISIONS:	DATE:

PROJECT / CLIENT:

LYNNWOOD HOUSE 1

TRIAD HOLDINGS

PROJECT ADDRESS: 3515 169TH AVE SW

LYNNWOOD, WA 98037

SITE PLAN

DRAWING NAME:

DRAWN BY: KKH

CHECKED By: JK

PHASE:

ADU LAND USE

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APPROVED FOR CONSTRUCTION:

SYMBOL LEGEND


SEE GENERAL NOTES SHEET A0.0 FOR COMPLETE SYMBOL INDEX.

DATE: 6/13/2023

PROJECT No.: A21 068

PLOT SCALE: 1:1


CALL 48 HOURS BEFORE YOU DIG 811 OR 1-800-424-5555

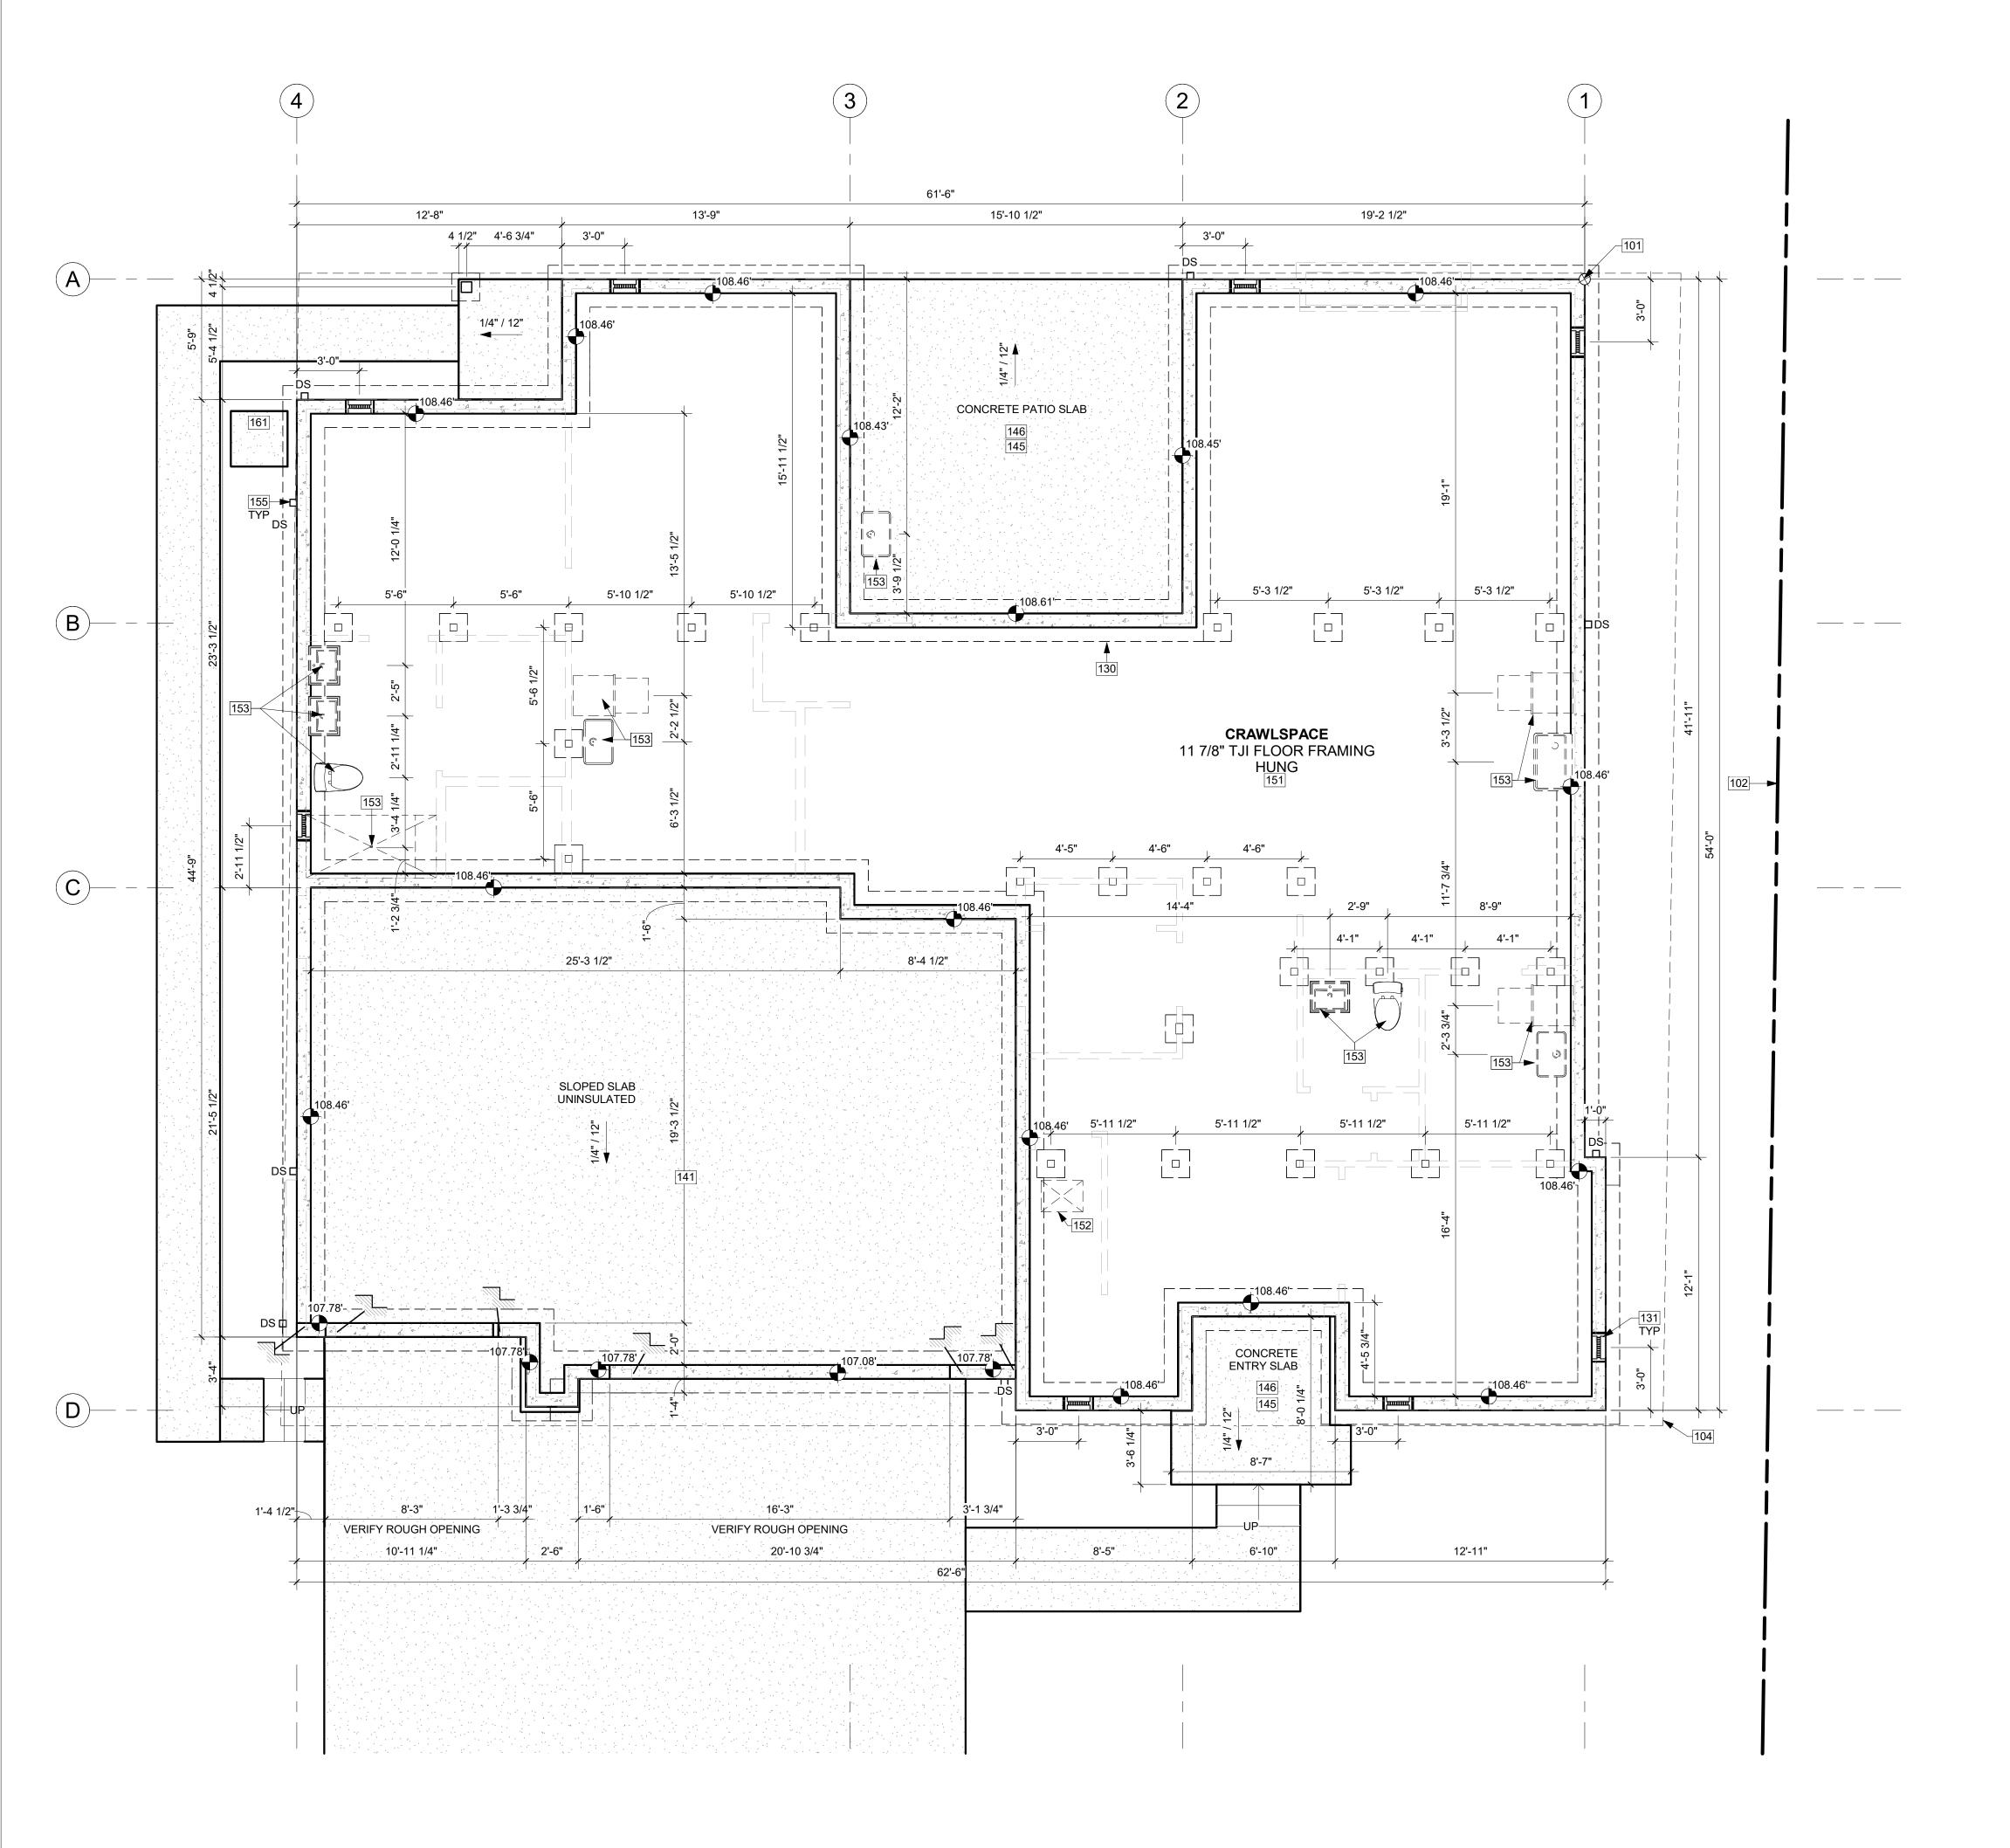






101	PROJECT BASE POINT.
102	EXISTING PROPERTY LINE.
104	SETBACK LINE.
130	FOUNDATION WALL AND FOOTING, PER STRUCTURAL. 6MIL VAPOR BARRIER TURNED UP AND OVER TOP OF STEM WALL.
131	16"x8" CRAWL SPACE VENT, TYP. ENSURE VENTS ARE NOT IN CONFLICT WITH HOLDDOWNS. PROVIDE PRE-FABRICATED GALVANIZED VENT WELL AS REQUIRED, PER IRC 408.1.
141	CONCRETE SLAB IN UNCONDITIONED SPACE. SLOPE PER PLANS. INSTALL OVER GRAVEL OR CRUSHED ROCK OVER FIRM COMPACTED OR UNDISTURBED SOIL, WITH REINFORCING PER STRUCTURAL.
145	CONCRETE LANDING. MIN. SLOPE 1/4" PER 12" AWAY FROM BUILDING.
146	LANDINGS OR FINISHED FLOORS AT REQUIRED EGRESS DOORS SHALL NOT BE MORE THAN 1-1/2" LOWER THAN THE TOP OF THE THRESHOLD.
151	CRAWL SPACE. MINIMUM 18" TALL. PROVIDE MIN 6MIL VAPOR BARRIER OVER GRADE AND TURNED UP AND OVER STEM WALLS.
152	CRAWL SPACE ACCESS IN FLOOR ABOVE, PER IRC R408.4. 18"x24" MIN OPENING WITH R-38 INSULATION.
153	PLUMBING FIXTURE ABOVE. VERIFY DIMENSIONS IN FIELD PER FIXTURE SELECTION.
155	POWDER-COATED 4" SQUARE DOWNSPOUT. TIGHTLINE ALL DOWNSPOUTS TO STORMWATER SYSTEM, PER CIVIL.
161	CONCRETE SLAB OVER COMPACTED EARTH FOR OUTDOOR HVAC UNIT, OR PER MANUFACTURER'S RECOMMENDATION.

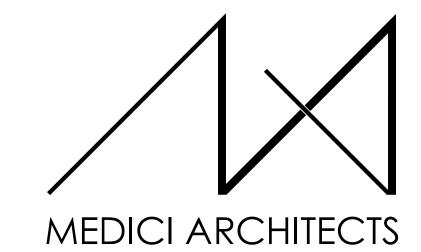

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200 W. RIVER ST. SUITE 301 KETCHUM, ID 83340 TEL: (208) 726-0194

REGISTRATION:

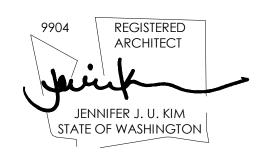

NTAKE DATE: 04/22/20	
REVISIONS:	DATE:

PROJECT / CLIENT:

LYNNWOOD HOUSE 1

TRIAD HOLDINGS

PROJECT ADDRESS: 3515 169TH AVE SW LYNNWOOD, WA 98037

DRAWING NAME:

DRAWN BY: KKH

CHECKED By: JK

ADU LAND USE

PHASE:

FOUNDATION PLAN

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CRAWL SPACE VENTILATION

CRAWL SPACE AREA =	1,952.50 SF	
VENTILATION REQUIRED:	(1,952.50 SF x 144 SI) / 1500 =	187.44 SI REQUIRED
USE:	16"x8" FOUNDATION VENTS	
NET VENT AREA =	98.0 SI (-25%) = 73.5 SI	
VENTS REQUIRED =	168.05 SI / 73.5 SI =	3 VENTS
PROVIDE:	(8) 16"x8" VENTS =	588 SI
TOTAL MIN. VENTILATION PR	OVIDED = 588 SI IS GREATER T	HAN 187.44 REQUIRED.
NOTE: PER IRC R408.2:		
 IF VENTILATION IS RE 	EDUCED TO LESS THAN 1 SI / 300	SF OR IF OPERABLE

LOUVERS ARE PROVIDED, A RADON VENT SHALL BE INSTALLED. VENTILATION MAY BE REDUCED TO 1 SI / 1500 SF IF A CLASS I VAPOR

RETARDER IS PROVIDED OVER ENTIRE GROUND SURFACE.

FOUNDATION PLAN NOTES

- 1. FOOTINGS SHALL BEAR ON SOLID UNDISTURBED EARTH (CONTROLLED, COMPACTED STRUCTURAL FILL OR BOTH). DEPTH OF FOOTINGS TO BE DETERMINED BY STRUCTURAL ENGINEER. FOUNDATION EXCAVATION, BACKFILL AND COMPACTION SHALL CONFORM TO SPECIFICATION REQUIREMENTS. THIS CONSTRUCTION WORK, INCLUDING DRAINAGE, SHORING AND SUCH OTHER RELATED WORK AS REQUIRED, SHALL BE CONDUCTED BY THE CONTRACTOR. STOP WORK IF RECOMMENDED EXCAVATION CUT OR BEARING SOIL CHANGES OCCUR IN EITHER HORIZONTAL OR VERTICAL DIRECTION AND NOTIFY IMMEDIATELY THE GEOTECHNICAL ENGINEER AND STRUCTURAL ENGINEER. AT WHICH POINT THE ENGINEERS SHALL DETERMINE CAUSE OF DISPLACEMENT AND DEVELOP AND IMPLEMENT REMEDIAL MEASURES.
- 2. REFER TO STRUCTURAL PLANS FOR ALL FRAMING & FOUNDATION INFORMATION
- ALL IMPERVIOUS SURFACES TO BE GRADED TO SLOPE AND DRAIN AWAY FROM THE STRUCTURE MIN. 1/4" PER FOOT.

SYMBOL LEGEND

SEE GENERAL NOTES SHEET A0.2 FOR COMPLETE SYMBOL INDEX.

	WALL ABOVE
	NEW DIAGRAMMATIC FOUNDATION WALL & FOOTING VERIFY SIZE WITH STRUCTURAL.
	NEW SLAB ON GRADE
	POST AND PLINTH - VERIEY SIZE AND TYPE WITH


POST AND PLINTH - VERIFY SIZE AND TYPE WITH STRUCTURAL PLAN

TOW 119.12' TOP OF WALL ELEVATION

APPROVED FOR CONSTRUCTION:

PROJECT No.: A21 068

DATE: 6/13/2023

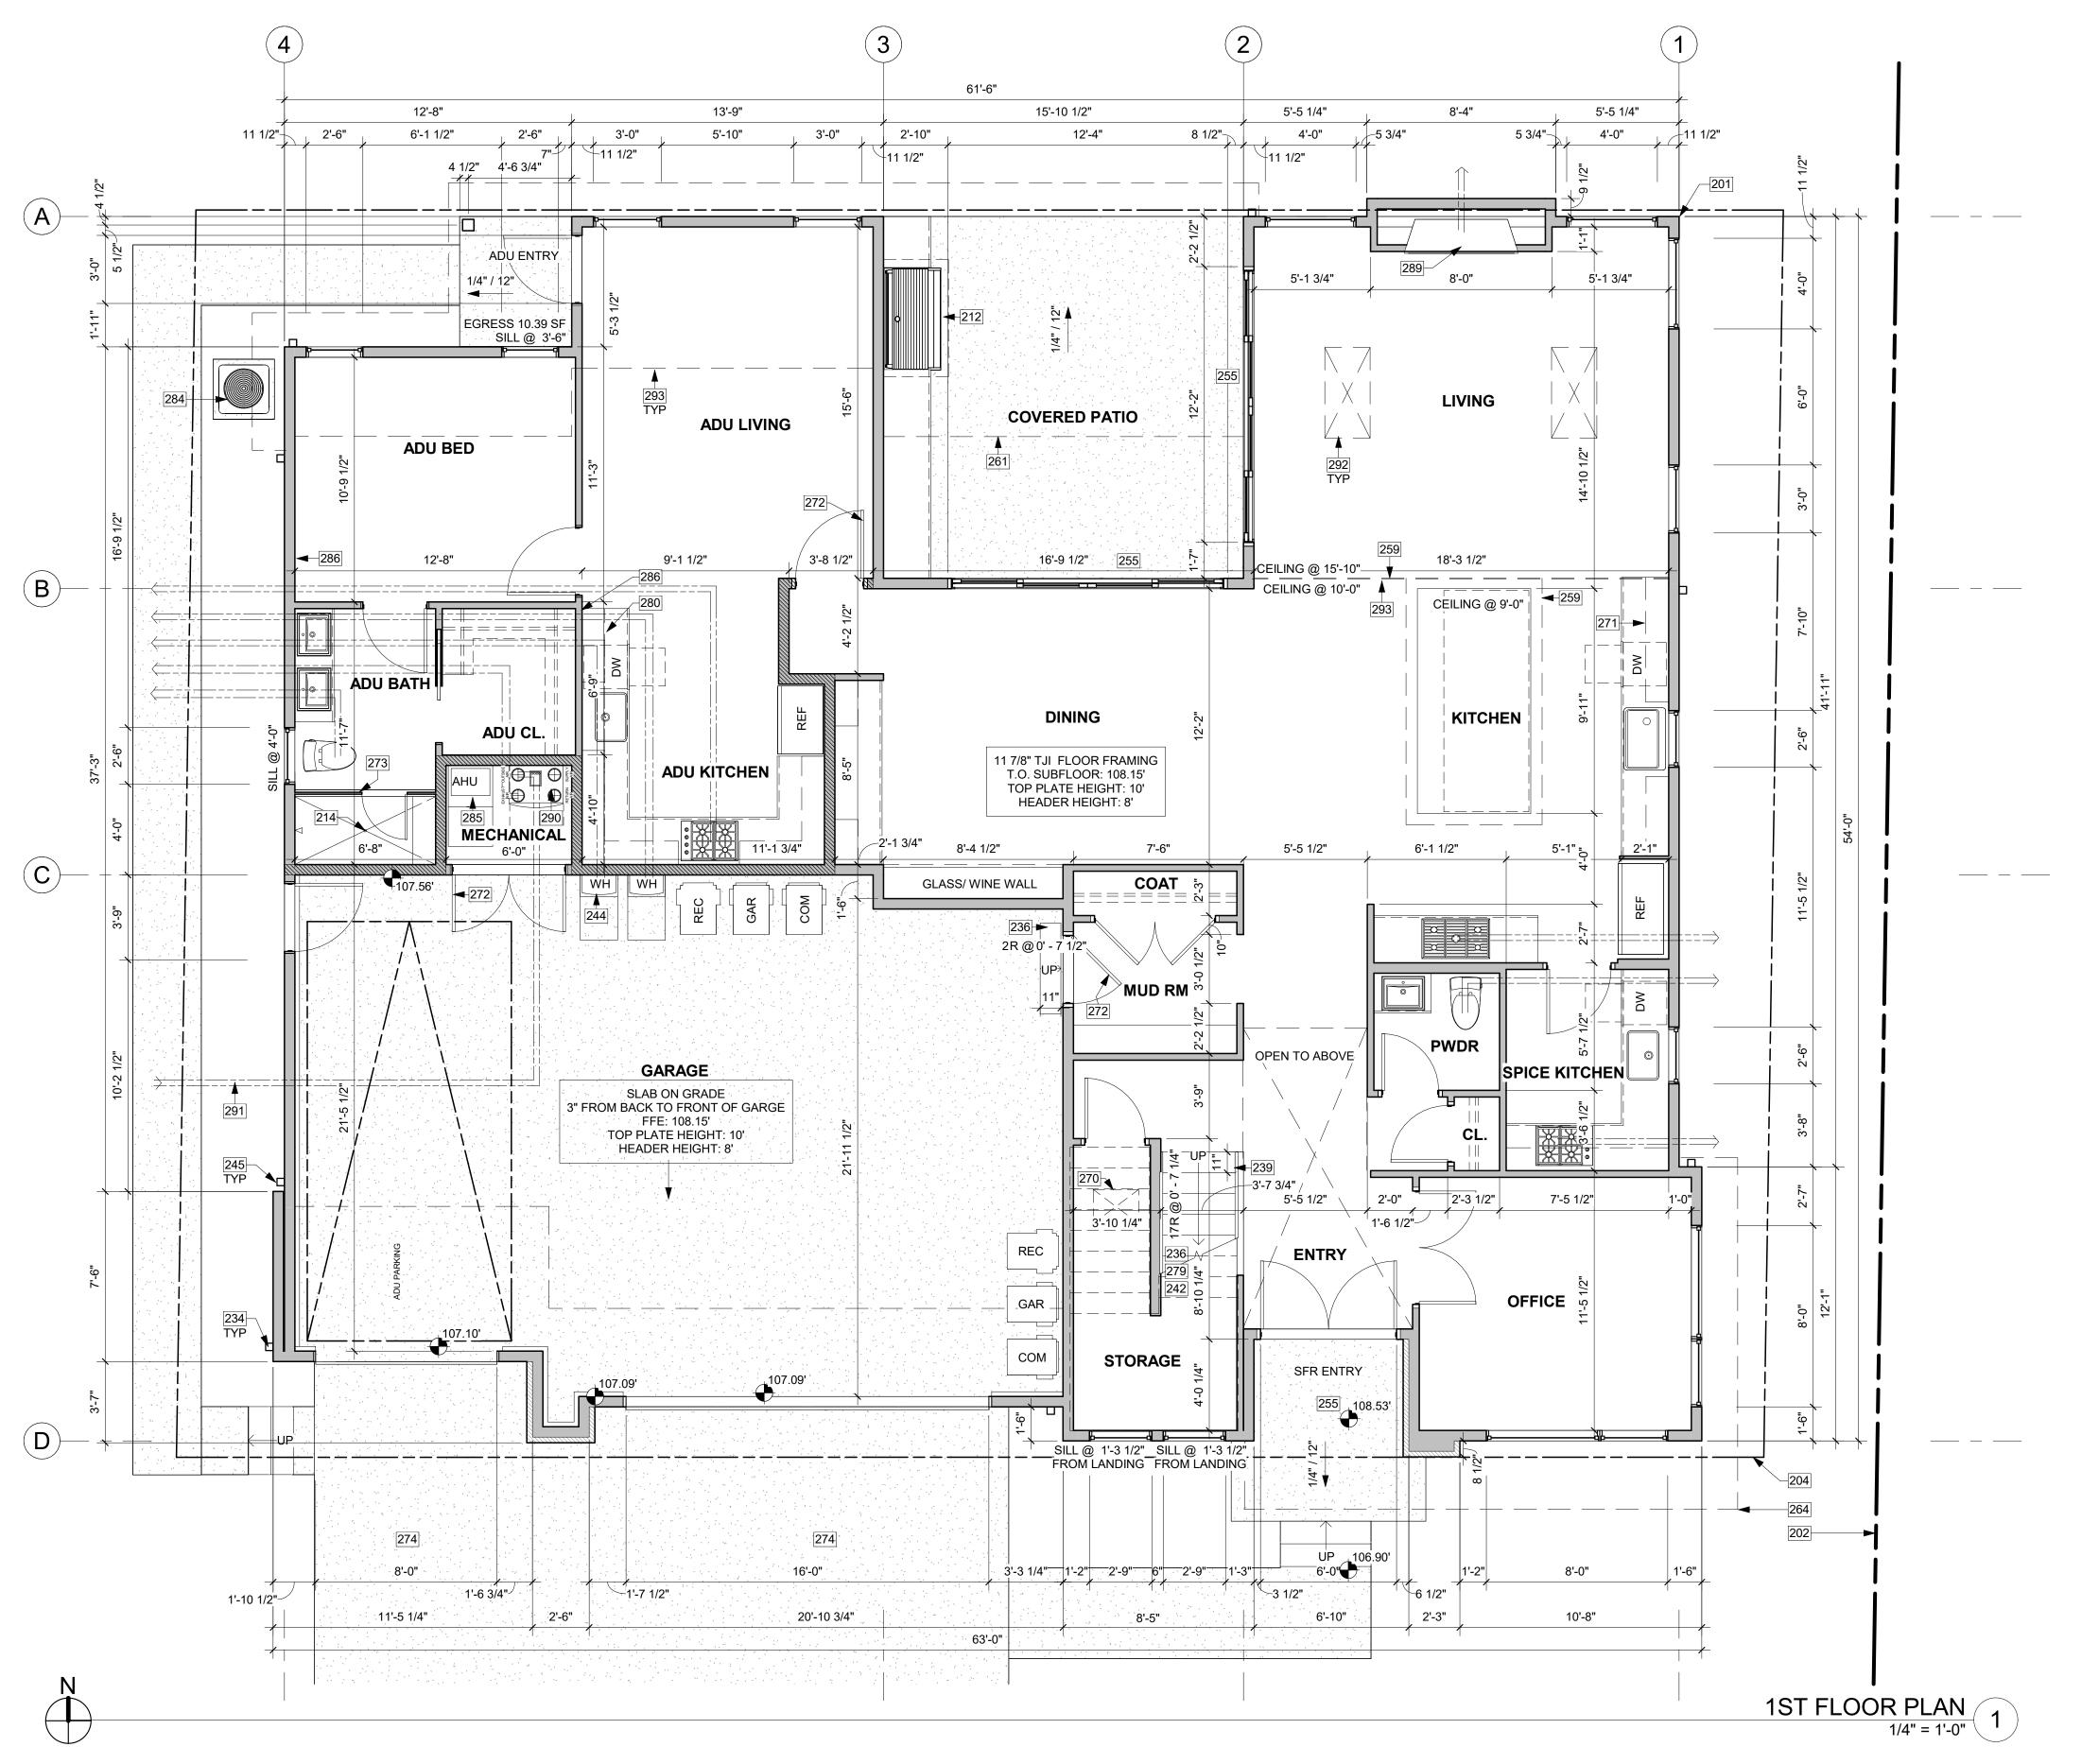

CONDITION:

NO DOMESTIC DISHWASHING MACHINE SHALL BE DIRECTLY CONNECTED TO A DRAINAGE SYSTEM OR FOOD WASTE DISPOSER WITHOUT THE USE OF AN APPROVED DISHWASHER AIR GAP FITTING ON THE DISCHARGE SIDE OF THE DISHWASHING MACHINE. LISTED AIR GAPS SHALL BE INSTALLED WITH THE FLOOD-LEVEL (FL) MARKING AT OR ABOVE THE FLOOD LEVEL OF THE SINK OR

DRAINBOARD. WHICHEVER IS HIGHER.

2018 UPC 807.3 DOMESTIC DISHWASHING MACHINE.

CONDITION:

ENCLOSED SPACE UNDER STAIRS THAT IS ACCESSED BY A DOOR OR ACCESS PANEL SHALL HAVE WALLS, UNDER-STAIR SURFACE AND ANY SOFFIT PROTECTED ON THE ENCLOSED SIDE WITH 1/2-INCH (12.7 MM) GYPSUM BOARD.

2018 IRC SECTION R302.7 UNDER-STAIR PROTECTION

HOUSE VENTILATION - ADU

BALANCED WHOLE HOUSE VENTILATION REQUIREMENTS TO BE MET WITH A HEAT RECOVERY VENTILATION SYSTEM (HRV) PER M1505.4 AND WSEC ENERGY CREDIT OPTION 2.2. HRV TO HAVE MINIMUM SENSIBLE HEAT RECOVERY EFFICIENCY OF 0.65. MINIMUM MECHANICAL VENTILATION AIRFLOW RATE TO BE 60 CFM (INTERMITTENT) - (0-1 BEDROOMS 617.71<1,500 SF) TO OPERATE 50% OF TIME IN EACH 4-HOUR SEGMENT, PER TABLES M1505.4.3(1) AND M1505.4.3(3).

SYMBOL	LOCATION	MINIMUM FAN REQUIREMENTS
-A	BATH & POWDER	MINIMUM LOCAL EXHAUST RATE TO BE 50 CFM
B	KITCHEN	MINIMUM LOCAL EXHAUST RATE TO BE 100 CFM PROVIDED BY RANGE HOOD OR DOWN DRAFT EXHAUST FAN, PER M1503.2 IF OVER 400 CFM, MAKEUP AIR IS REQUIRED IN THE SAME ROOM PER M1503.6.
-C	LAUNDRY ROOM	MINIMUM LOCAL EXHAUST RATE TO BE 50 CFM

HOUSE VENTILATION -SFR

BALANCED WHOLE HOUSE VENTILATION REQUIREMENTS TO BE MET WITH A HEAT RECOVERY VENTILATION SYSTEM (HRV) PER M1505.4 AND WSEC ENERGY CREDIT OPTION 2.2. HRV TO HAVE MINIMUM SENSIBLE HEAT RECOVERY EFFICIENCY OF 0.65. MINIMUM MECHANICAL VENTILATION AIRFLOW RATE TO BE 90 CFM (INTERMITTENT) - (4-5 BEDROOMS 3,001<4,500 SF) TO OPERATE 50% OF TIME IN EACH 4-HOUR SEGMENT, PER TABLES M1505.4.3(1) AND M1505.4.3(3).

SYMBOL	LOCATION	MINIMUM FAN REQUIREMENTS
A	BATH & POWDER	MINIMUM LOCAL EXHAUST RATE TO BE 50 CFM
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-C	LAUNDRY ROOM	MINIMUM LOCAL EXHAUST RATE TO BE 50 CFM

201	PROJECT BASE POINT.	
202	EXISTING PROPERTY LINE.	
204	SETBACK LINE.	
212	PROTECTIVE MATERIAL ABOVE AND AROUND APPLIANCE TO BE INSTALL PER MANUFACTURER SPECIFICATIONS.	
214	EQUAL FLOW DRAIN WATER HEAT RECOVERY UNIT TO BE INSTALLED IN SHOWER. MINIMUM EFFICIENCY OF 40%.	
234	POWDER-COATED SCUPPER AND 4" SQUARE DOWNSPOUT. TIGHTLINE A DOWNSPOUTS TO STORMWATER SYSTEM, PER CIVIL.	
236	WOOD STAIR. STAIR STRUCTURE AND CONNECTIONS TO BE A DEFERRE SUBMITTAL.	
239	GUARDRAILS. FLOOR MOUNT. DEFERRED SUBMITTAL. MIN. HEIGHT 36-INCHES PER IRC R312.1.2. REQUIRED GUARDS SHALL NOT HAVE OPENINGS FROM THE WALKING SURFACE TO THE REQUIRED GUARD HEIGHT WHICH ALLOW PASSAGE OF A SPHERE 4" IN DIAMETER, PER IRC R312.1.3 EXCEPTIONS: 1) THE TRIANGULAR OPENINGS AT THE OPEN SID OF STAIR, FORMED BY THE RISER, TREAT AND BOTTOM RAIL OF A GUAR SHALL NOT ALLOW PASSAGE OF A SPHERE OF 6" IN DIAMETER. 2) GUAR ON THE OPEN SIDE OF STAIRS SHALL NOT HAVE OPENINGS WHICH ALLO PASSAGE OF A SPHERE OF 4-3/8" IN DIAMETER. CONNECTIONS PER TYP STRUCTURAL GUARDRAIL DETAILS.	
242	HANDRAIL PER IRC 311.7.8, WALL MOUNTED.	
244	ENERGY STAR RATED ON DEMAND WATER HEATER PER WSEC TABLE 40 OPTION 5.3: MIN. EF= 0.91. DIRECT VENT TO OUTSIDE THROUGH WALL O ROOF PER MANUFACTURER'S REQUIREMENTS. THE COMBUSTION AIR TO PROVIDED BY INFILTRATION OF FRESH AIR WITH A FRESH AIR VENT. ON FOR EACH DWELING UNIT.	
245	POWDER-COATED 5" SQUARE GUTTER AND 4" SQUARE DOWNSPOUT. TIGHTLINE ALL DOWNSPOUTS TO STORMWATER SYSTEM, PER CIVIL.	
255	LANDINGS OR FINISHED FLOORS AT REQUIRED EGRESS DOORS SHALL IN BE MORE THAN 1-1/2" LOWER THAN THE TOP OF THE THRESHOLD.	
259	LINE OF CEILING CHANGE ABOVE.	
261	LINE OF EXTERIOR WALL ABOVE. FILL FLOOR CAVITY OVER NON-CONDITIONED SPACES WITH BATT INSULATION. MINIMUM R-38.	
264	LINE OF ROOF ABOVE.	
270	CRAWL SPACE ACCESS IN FLOOR, PER IRC R408.4. 18"x24" MIN OPENING WITH R-38 INSULATION.	
271	LINE OF UPPER CABINETS.	
272	20 MINUTE FIRE-RATED DOOR WITH SELF CLOSER. INSULATED.	
273	TEMPERED GLAZING IN SHOWER STALL. DOOR TO SWING OUTWARD.	
274	DRIVEWAY SLOPE PER CIVIL.	
279	PROVIDE ILLUMINATION PER IRC R303.7: INTERIOR STAIRWAYS SHALL BI PROVIDED WITH AN ARTIFICIAL LIGHT SOURCE TO ILLUMINATE THE LANDINGS AND TREADS. THE LIGHT SOURCE SHALL BE CAPABLE OF ILLUMINATION LEVELS NOT LESS THAN 1 FOOT-CANDLE (11 LUX) AS MEASURED AT THE CENTER OF TREADS AND LANDINGS.	
280	WHOLE HOUSE FAN CONTROL (WHFC) PER IRC 2018 1504.2 SHALL BE PROVIDED WITH CONTROLS THAT ENABLE MANUAL OVERRIDE. MUST OPERATE AT LEAST 50% OF TIME IN EACH 4 HOUR SEGMENT PER IRC TAM1505.4.3(1) & (2).	
284	EXTERIOR PORTION OF AIR SOURCE HEAT PUMP WITH MINIMUM HSPF O TO SERVE BOTH SFR AND ADU WITH ZONAL CONTROL. PROVIDE MINIMU CLEARANCES AROUND UNIT PER MANUFACTURER'S REQUIREMENTS.	
285	INTERIOR PORTION OF ZONALLY CONTROLLED AIR SOURCE HEAT PUMP WITH MIN HSPF OF 11, TOTAL COMBINED MAX 72,157 Btu/hr.	
286	ZONAL CONTROL FOR SHARED HVAC UNIT, SFR MAX 62448 BTU/HR, ADU MAX 9,709 BTU/HR.	
289	GAS FIREPLACE: DIRECT VENT THROUGH THE WALL PER MANUFACTURE REQUIREMENTS. MINIMUM FRAMING CLEARANCES PER OWNER'S SELECUNIT, PER IRC R1004.2. FACTORY-BUILT FIREPLACES SHALL BE LISTED, LABELED AND INSTALLED WITH THE CONDITIONS OF THE LISTING, AND I ACCORDANCE WITH UL 127. FACTORY-BUILT HEARTH EXTENSIONS FOR APPROVED FACTORY-BUILT FIREPLACES SHALL BE INSTALLED IN ACCORDANCE WITH THE LISTING OF THE FIREPLACE. THE HEARTH EXTENSION SHALL BE READILY DISTINGUISHABLE FROM THE SURROUNDING FLOOR AREA.	
	SOM CONDING I LOOK AINEA.	

RATED CONSTRUCTION LEGEND

HEAT RECOVERY VENTILATOR (HRV) PROVIDED TO SERVE BOTH SFR AND

FRESH AIR TO BEDROOMS AND LIVING SPACES. INSTALLATION

REQUIREMENTS PER MANUFACTURE.

291 HRV INTAKE AND EXHAUST DUCTS.

292 SKYLIGHT ABOVE.

293 LINE OF BUILDING ABOVE.

EXTRACT STALE AIR FROM THE KITCHEN AND BATHROOMS AND SUPPLIES

1-HOUR RATED WALL CONSTRUCTION

1-HOUR RATED FLOOR / ROOF CONSTRUCTION

FLOOR PLAN NOTES

- CONTRACTOR SHALL VERIFY ALL NOTES, DIMENSIONS & CONDITIONS PRIOR TO CONSTRUCTION.
- SEE STRUCTURAL DRAWINGS FOR ALL POSTS, BEAMS AND HEADERS. PROVIDE SOLID BLOCKING OVER SUPPORTS.
- PROVIDE FIRE BLOCKING @ ALL PLUMBING PENETRATIONS.
- WINDOWS & DOORS ARE SHOWN & NOTED AS NOMINAL SIZES. DOOR JAMB 4.5" FROM CORNER TYP., U.N.O.
- SEE SHEETS A0.3, A4.0 & A4.1 FOR WINDOW & DOOR HEADER HEIGHTS ABOVE FINISHED FLOOR. ALL WOOD IN CONTACT WITH CONCRETE TO BE PRESSURE TREATED.
- EXTERIOR WALLS TO BE 2x6 STUDS @ 16" O.C., U.N.O. INSTALL SIMPSON CONC. TO WOOD HOLDOWNS PER STRUCTURAL
- DRAWINGS, ALSO SEE MANUFACTURER'S SPECS.
- SMOKE & CARBON MONOXIDE DETECTORS: • SHALL BE 110V INTERCONNECTED W/ BATTERY BACKUP. • SHALL SOUND AN ALARM AUDIBLE IN ALL SLEEPING ROOMS. • SHALL BE INSTALLED ON EACH FLOOR AND IN ALL BEDROOMS. • SHALL BE INSTALLED IN EACH LOCATION WHERE THERE IS A CEILING
- CHANGE OF GREATER THAN 24" FRESH AIR PROVIDED BY WHOLE-HOUSE EXHAUST FAN WITH FRESH AIR PORT (NET 4 SF IN MIN. OPENING) AT EACH HABITABLE ROOM. A TIMER
- OPERATES AN EXHAUST FAN WHICH PULLS OUTSIDE AIR THROUGH AIR INLETS LOCATED IN EACH HABITABLE ROOM.
- LIMITING DEVICE FOR TUBS TO PROVIDE MAX. 120°F HOT WATER TEMPERATURE.
- FOOTINGS SHALL BEAR ON SOLID UNDISTURBED EARTH (CONTROLLED, COMPACTED STRUCTURAL FILL OR BOTH). DEPTH OF FOOTINGS TO BE DETERMINED BY STRUCTURAL ENGINEER. FOUNDATION EXCAVATION, BACKFILL AND COMPACTION SHALL CONFORM TO SPECIFICATION REQUIREMENTS. THIS CONSTRUCTION WORK, INCLUDING DRAINAGE, SHORING AND SUCH OTHER RELATED WORK AS REQUIRED, SHALL BE CONDUCTED BY THE CONTRACTOR. STOP WORK IF RECOMMENDED EXCAVATION CUT OR BEARING SOIL CHANGES OCCUR IN EITHER HORIZONTAL OR VERTICAL DIRECTION AND NOTIFY IMMEDIATELY THE
- GEOTECHNICAL ENGINEER AND STRUCTURAL ENGINEER. AT WHICH POINT THE ENGINEERS SHALL DETERMINE CAUSE OF DISPLACEMENT AND DEVELOP AND IMPLEMENT REMEDIAL MEASURES.

SYMBOL LEGEND

SEE SHEET A0.2 FOR ADDITIONAL NOTES.


SEE GENERAL NOTES SHEET A0.0 FOR COMPLETE SYMBOL INDEX.



11711 SE 8TH STREET BELLEVUE, WA 98005

200 W. RIVER ST. SUITE 301 KETCHUM, ID 83340 TEL: (208) 726-0194

REGISTRATION

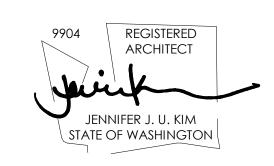

INTAKE DATE:	04/22/2022
REVISIONS:	DATE:

PROJECT / CLIENT:

LYNNWOOD HOUSE 1

TRIAD HOLDINGS

PROJECT ADDRESS: 3515 169TH AVE SW LYNNWOOD, WA 98037

DRAWING NAME:

1ST FLOOR PLAN

DRAWN BY: KKH CHECKED By: JK


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APPROVED FOR CONSTRUCTION:

PROJECT No.: A21 068 DATE: 6/13/2023



2ND FLOOR PLAN 1

KEY NOTES

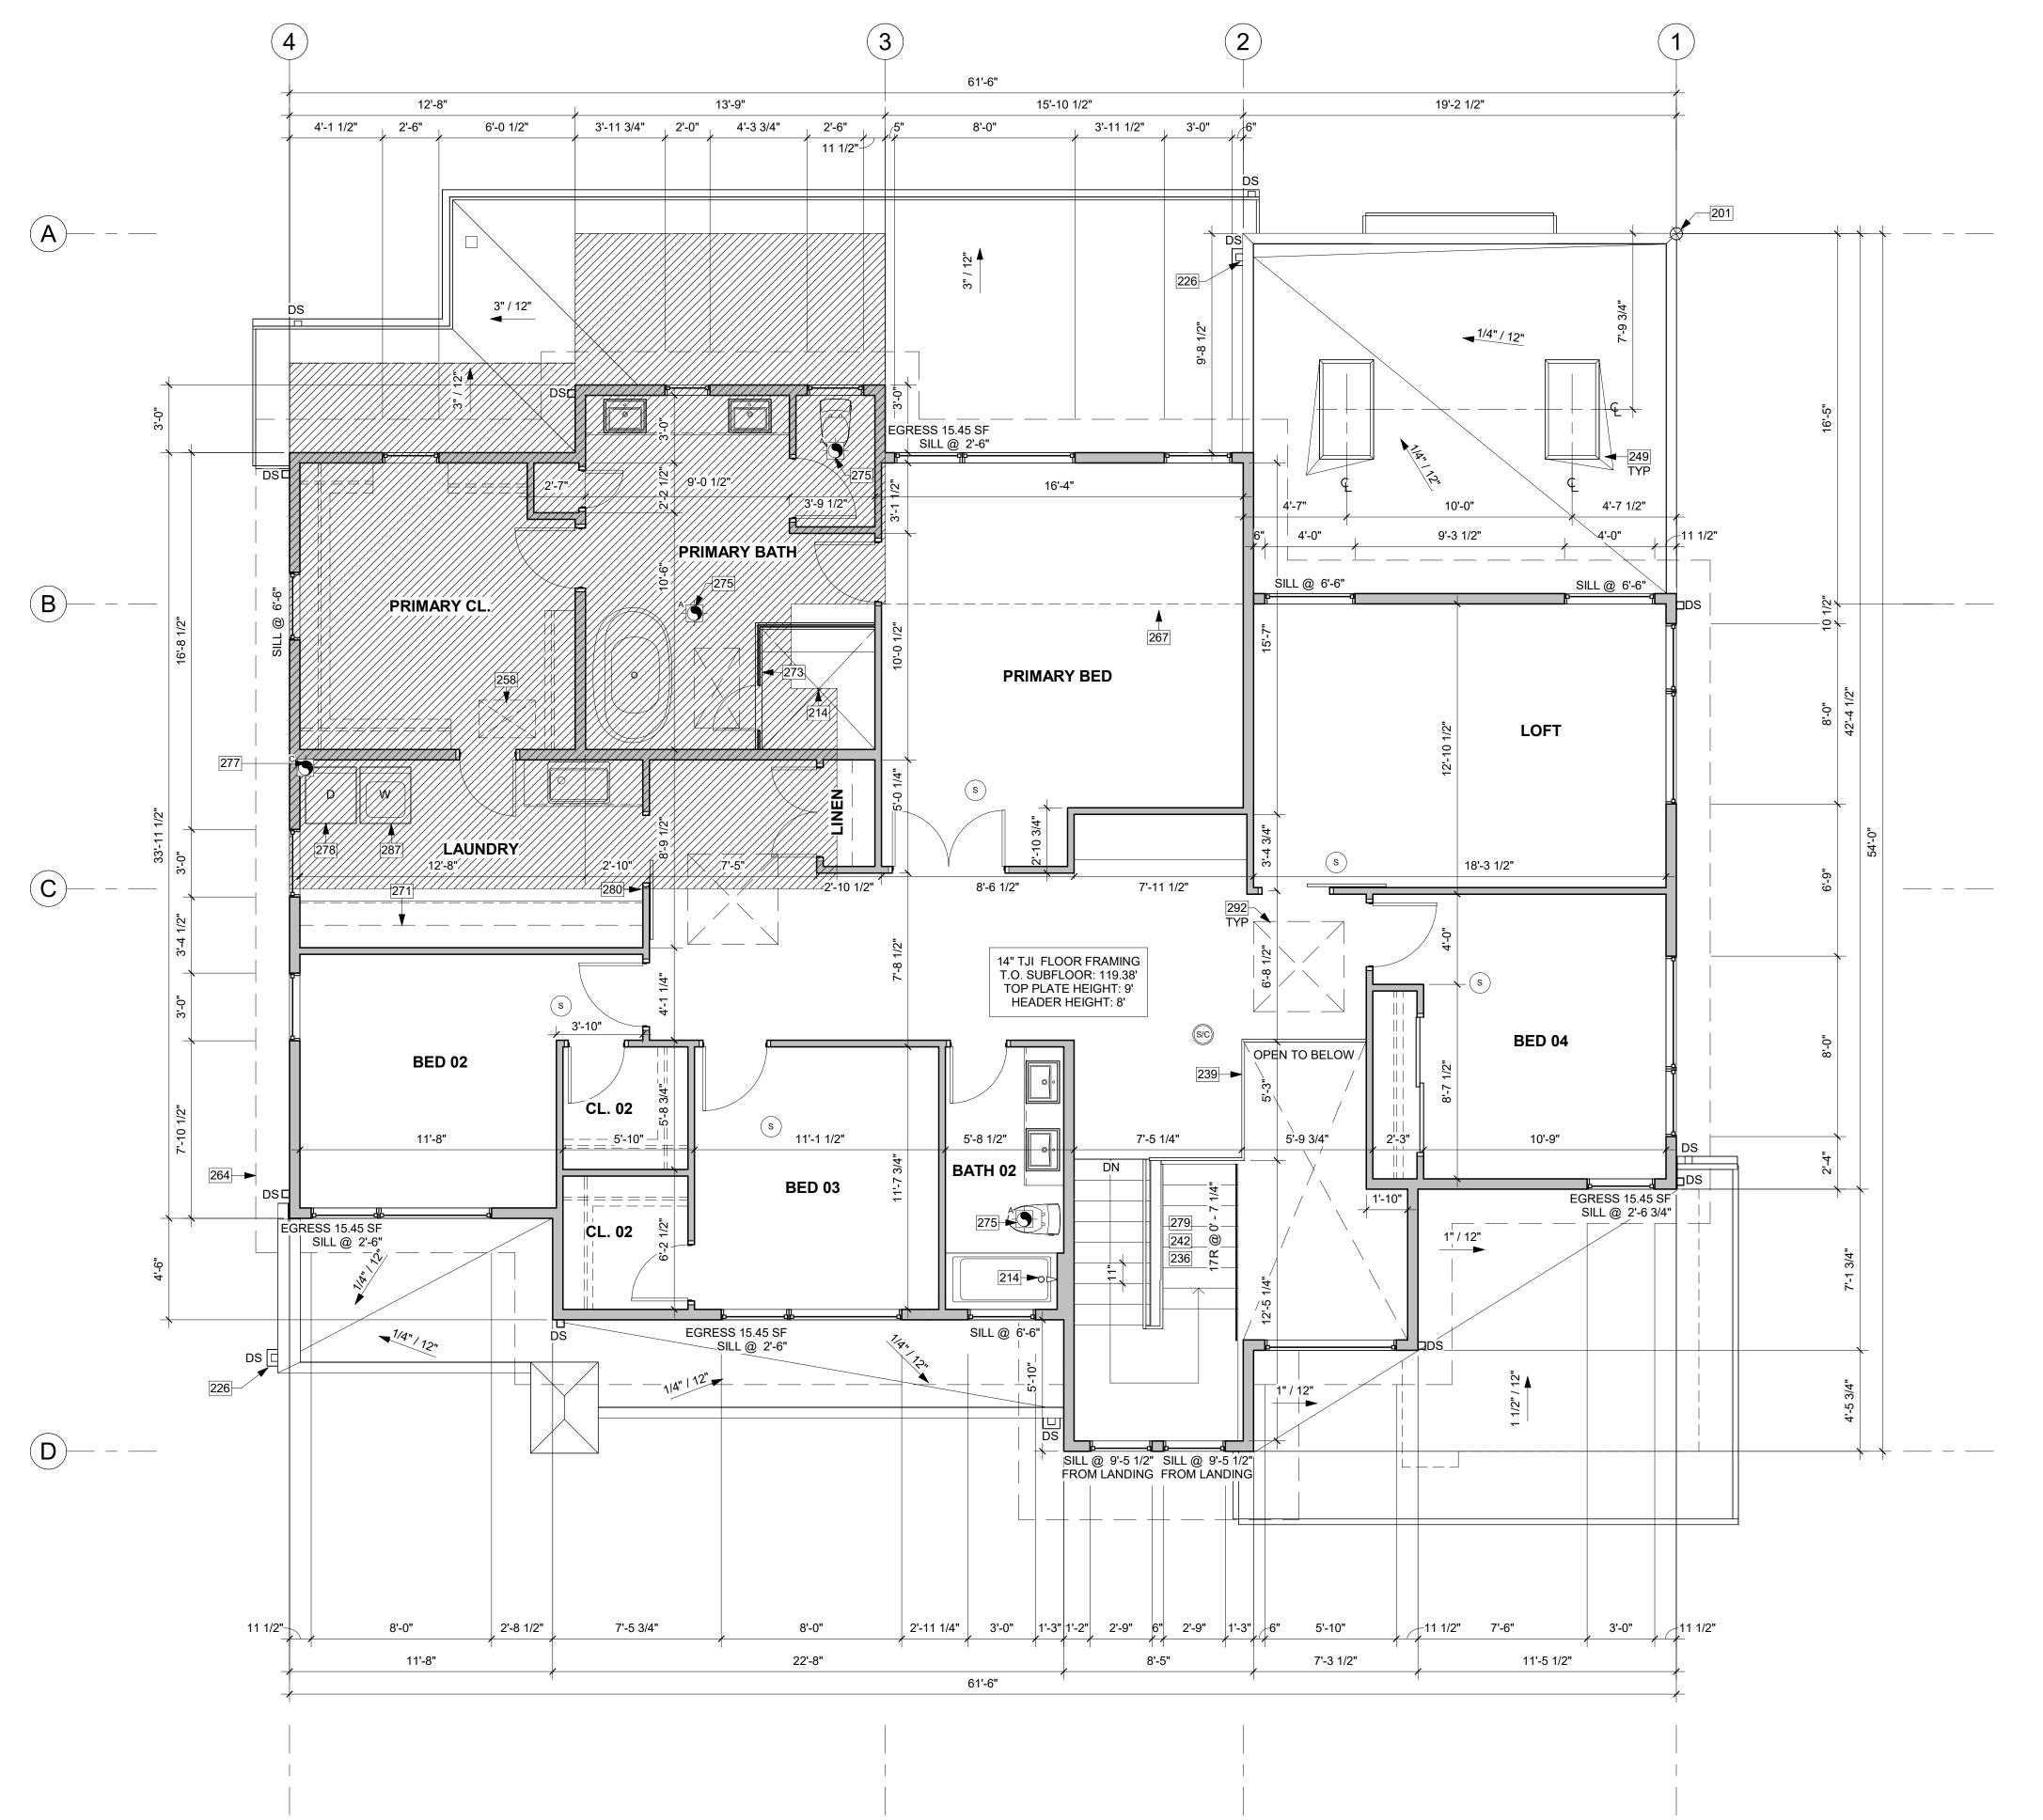- PROJECT BASE POINT.
- EQUAL FLOW DRAIN WATER HEAT RECOVERY UNIT TO BE INSTALLED IN SHOWER. MINIMUM EFFICIENCY OF 40%.
- THRU WALL DRAIN.
- WOOD STAIR. STAIR STRUCTURE AND CONNECTIONS TO BE A DEFERRED
- GUARDRAILS. FLOOR MOUNT. DEFERRED SUBMITTAL. MIN. HEIGHT 36-INCHES PER IRC R312.1.2. REQUIRED GUARDS SHALL NOT HAVE OPENINGS FROM THE WALKING SURFACE TO THE REQUIRED GUARD HEIGHT WHICH ALLOW PASSAGE OF A SPHERE 4" IN DIAMETER, PER IRC R312.1.3 EXCEPTIONS: 1) THE TRIANGULAR OPENINGS AT THE OPEN SIDE OF STAIR, FORMED BY THE RISER, TREAT AND BOTTOM RAIL OF A GUARD, SHALL NOT ALLOW PASSAGE OF A SPHERE OF 6" IN DIAMETER. 2) GUARDS ON THE OPEN SIDE OF STAIRS SHALL NOT HAVE OPENINGS WHICH ALLOW PASSAGE OF A SPHERE OF 4-3/8" IN DIAMETER. CONNECTIONS PER TYPICAL STRUCTURAL GUARDRAIL DETAILS.
 - HANDRAIL PER IRC 311.7.8, WALL MOUNTED.
- BUILT-UP RIGID INSULATION CRICKET, WITH PROTECTION BOARD OVER. SLOPE MINIMUM 1/4" PER 12".
- ATTIC ACCESS PER R807.1. ROUGH OPENING NO LESS THAN 22"x30". 30" MIN UNOBSTRUCTED HEADROOM IN ATTIC SPACE ABOVE ACCESS DOOR.
- LINE OF EXTERIOR WALL BELOW. FILL FLOOR CAVITY OVER
- NON-CONDITIONED SPACES WITH BATT INSULATION. MINIMUM R-38. LINE OF UPPER CABINETS.

CENTER OF TREADS AND LANDINGS.

- TEMPERED GLAZING IN SHOWER STALL. DOOR TO SWING OUTWARD. BATHROOM FAN TO BE VENTED OUTSIDE THROUGH THE ROOF.
- DRYER TO BE VENTED OUTSIDE THROUGH ROOF. DRYER TO BE VENTED OUTSIDE THROUGH THE WALL. VERIFY 3'-0" MINIMUM CLEARANCE FROM GLAZING.
- PROVIDE ILLUMINATION PER IRC R303.7: INTERIOR STAIRWAYS SHALL BE PROVIDED WITH AN ARTIFICIAL LIGHT SOURCE TO ILLUMINATE THE LANDINGS AND TREADS. THE LIGHT SOURCE SHALL BE CAPABLE OF ILLUMINATION LEVELS NOT LESS THAN 1 FOOT-CANDLE (11 LUX) AS MEASURED AT THE
- WHOLE HOUSE FAN CONTROL (WHFC) PER IRC 2018 1504.2 SHALL BE PROVIDED WITH CONTROLS THAT ENABLE MANUAL OVERRIDE. MUST OPERATE AT LEAST 50% OF TIME IN EACH 4 HOUR SEGMENT PER IRC TABLE
- WASHING AND DRYING MACHINES. PROVIDE FLOOR SAVER PAN WITH A TRAP SEAL PRIMER, PER UPC 1007.1 UNDER WASHER WITH TIGHTLINE DRAIN TO SANITARY SEWER. PROVIDE DRYER BOX IN WALL FOR DRYER VENT TO PREVENT COMPROMISING DUCTWORK. VENT THROUGH WALL.
- SKYLIGHT ABOVE.

RATED CONSTRUCTION LEGEND

1-HOUR RATED WALL CONSTRUCTION

1-HOUR RATED FLOOR / ROOF CONSTRUCTION

HOUSE VENTILATION -SFR

BALANCED WHOLE HOUSE VENTILATION REQUIREMENTS TO BE MET WITH A HEAT RECOVERY VENTILATION SYSTEM (HRV) PER M1505.4 AND WSEC ENERGY CREDIT OPTION 2.2. HRV TO HAVE MINIMUM SENSIBLE HEAT RECOVERY EFFICIENCY OF 0.65. MINIMUM MECHANICAL VENTILATION AIRFLOW RATE TO BE 90 CFM (INTERMITTENT) - (4-5 BEDROOMS 3,001<4,500 SF) TO OPERATE 50% OF TIME IN EACH 4-HOUR SEGMENT, PER TABLES M1505.4.3(1) AND M1505.4.3(3).

SYMBOL LOCATION MINIMUM FAN REQUIREMENTS BATH & MINIMUM LOCAL EXHAUST RATE TO BE 50 CFM POWDER KITCHEN MINIMUM LOCAL EXHAUST RATE TO BE 100 CFM PROVIDED BY RANGE HOOD OR DOWN DRAFT EXHAUST FAN, PER M1503.2 IF OVER 400 CFM, MAKEUP AIR IS REQUIRED IN THE SAME ROOM PER M1503.6. LAUNDRY MINIMUM LOCAL EXHAUST RATE TO BE 50 CFM

FLOOR PLAN NOTES

ROOM


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- ABOVE FINISHED FLOOR. ALL WOOD IN CONTACT WITH CONCRETE TO BE PRESSURE TREATED.
- EXTERIOR WALLS TO BE 2x6 STUDS @ 16" O.C., U.N.O.
- INSTALL SIMPSON CONC. TO WOOD HOLDOWNS PER STRUCTURAL DRAWINGS, ALSO SEE MANUFACTURER'S SPECS.

SMOKE & CARBON MONOXIDE DETECTORS:

- SHALL BE 110V INTERCONNECTED W/ BATTERY BACKUP. • SHALL SOUND AN ALARM AUDIBLE IN ALL SLEEPING ROOMS. • SHALL BE INSTALLED ON EACH FLOOR AND IN ALL BEDROOMS. • SHALL BE INSTALLED IN EACH LOCATION WHERE THERE IS A CEILING CHANGE OF GREATER THAN 24"
- FRESH AIR PROVIDED BY WHOLE-HOUSE EXHAUST FAN WITH FRESH AIR PORT (NET 4 SF IN MIN. OPENING) AT EACH HABITABLE ROOM. A TIMER OPERATES AN EXHAUST FAN WHICH PULLS OUTSIDE AIR THROUGH AIR INLETS LOCATED IN EACH HABITABLE ROOM.
- LIMITING DEVICE FOR TUBS TO PROVIDE MAX. 120°F HOT WATER TEMPERATURE.
- FOOTINGS SHALL BEAR ON SOLID UNDISTURBED EARTH (CONTROLLED, COMPACTED STRUCTURAL FILL OR BOTH). DEPTH OF FOOTINGS TO BE DETERMINED BY STRUCTURAL ENGINEER. FOUNDATION EXCAVATION, BACKFILL AND COMPACTION SHALL CONFORM TO SPECIFICATION REQUIREMENTS. THIS CONSTRUCTION WORK, INCLUDING DRAINAGE, SHORING AND SUCH OTHER RELATED WORK AS REQUIRED, SHALL BE CONDUCTED BY THE CONTRACTOR. STOP WORK IF RECOMMENDED EXCAVATION CUT OR BEARING SOIL CHANGES OCCUR IN EITHER HORIZONTAL OR VERTICAL DIRECTION AND NOTIFY IMMEDIATELY THE GEOTECHNICAL ENGINEER AND STRUCTURAL ENGINEER. AT WHICH POINT THE ENGINEERS SHALL DETERMINE CAUSE OF DISPLACEMENT AND
- DEVELOP AND IMPLEMENT REMEDIAL MEASURES. SEE SHEET A0.2 FOR ADDITIONAL NOTES.

SYMBOL LEGEND


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11711 SE 8TH STREET SUITE 100 BELLEVUE, WA 98005

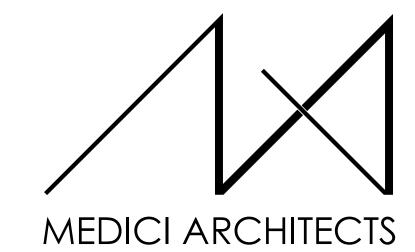200 W. RIVER ST. SUITE 301 KETCHUM, ID 83340 TEL: (425) 453-9298 TEL: (208) 726-0194

REGISTRATION



04/22/2022 INTAKE DATE:

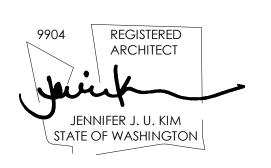REVIS	IONS:	[DATE:

PROJECT / CLIENT:

LYNNWOOD HOUSE 1

TRIAD HOLDINGS

PROJECT ADDRESS: 3515 169TH AVE SW

LYNNWOOD, WA 98037

DRAWING NAME:

2ND FLOOR PLAN

DRAWN BY: KKH CHECKED By: JK


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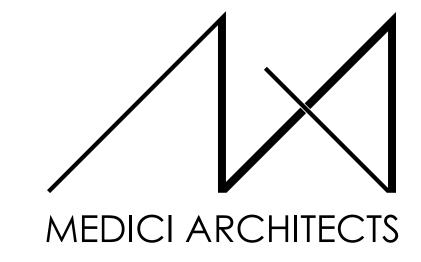
PROJECT No.: A21 068 DATE: 6/13/2023








301	PROJECT BASE POINT.
326	SKYLIGHT PER SCHEDULE, TYP. INSTALL WITH CURB AND FLASHING PER STRUCTURAL AND MANUFACTURER.
327	BUILT-UP RIGID INSULATION CRICKET, WITH PROTECTION BOARD OVER. SLOPE MINIMUM 1/4" PER 12".
329	VENTED PARAPET WITH 20 GA. SLOPED POWDER-COATED METAL CAP FLASHING.
331	DASHED LINE INDICATES CONTINUOUS RIDGE VENT PROVIDING 18 SQUARE INCHES OF VENTILATION PER LINEAR FOOT. SEE ROOF VENT TABLE
335	ROOF: UN-VENTED CAVITY. PROVIDE MINIMUM 7-INCHES ICYNENE PROSEAL (MD-C-200 v3) CLOSED-CELL WATER-BASED SPRAY FOAM INSULATION. R-7.1 PER INCH. MINIMUM TOTAL R-49. A COPY OF THE ICC-ES REPORT FOR THE INSULATION PRODUCT MUST BE PROVIDED ON SITE FOR THE FIELD INSPECTOR. THE APPLIED SPRAY FOAM MUST BE INSTALLED IN ACCORDANCE WITH THE MANUFACTURER'S INSTRUCTIONS BY A CERTIFIED INSTALLER.
336	PROVIDE SLOPE FOR FREE DRAINAGE PATH TO SCUPPER, MINIMUM 1/4":12" @ VALLEY.
341	TPO ROOFING INSTALLED PER MANUFACTURER. PER R905.2.2, DOUBLE LAYER OF UNDERLAYMENT REQUIRED IF ROOF PITCH IS SHALLOWER THAN 4:12.
343	POWDER-COATED 5" SQUARE GUTTER AND 4" SQUARE DOWNSPOUT. TIGHTLINE ALL DOWNSPOUTS TO STORMWATER SYSTEM, PER CIVIL.
348	DRYER TO BE VENT THROUGH ROOF.
355	ASPHALT SHINGLE ROOF. ROOFING SYSTEM PER IRC R905.2.
356	BATHROOM FAN VENT THROUGH ROOF.

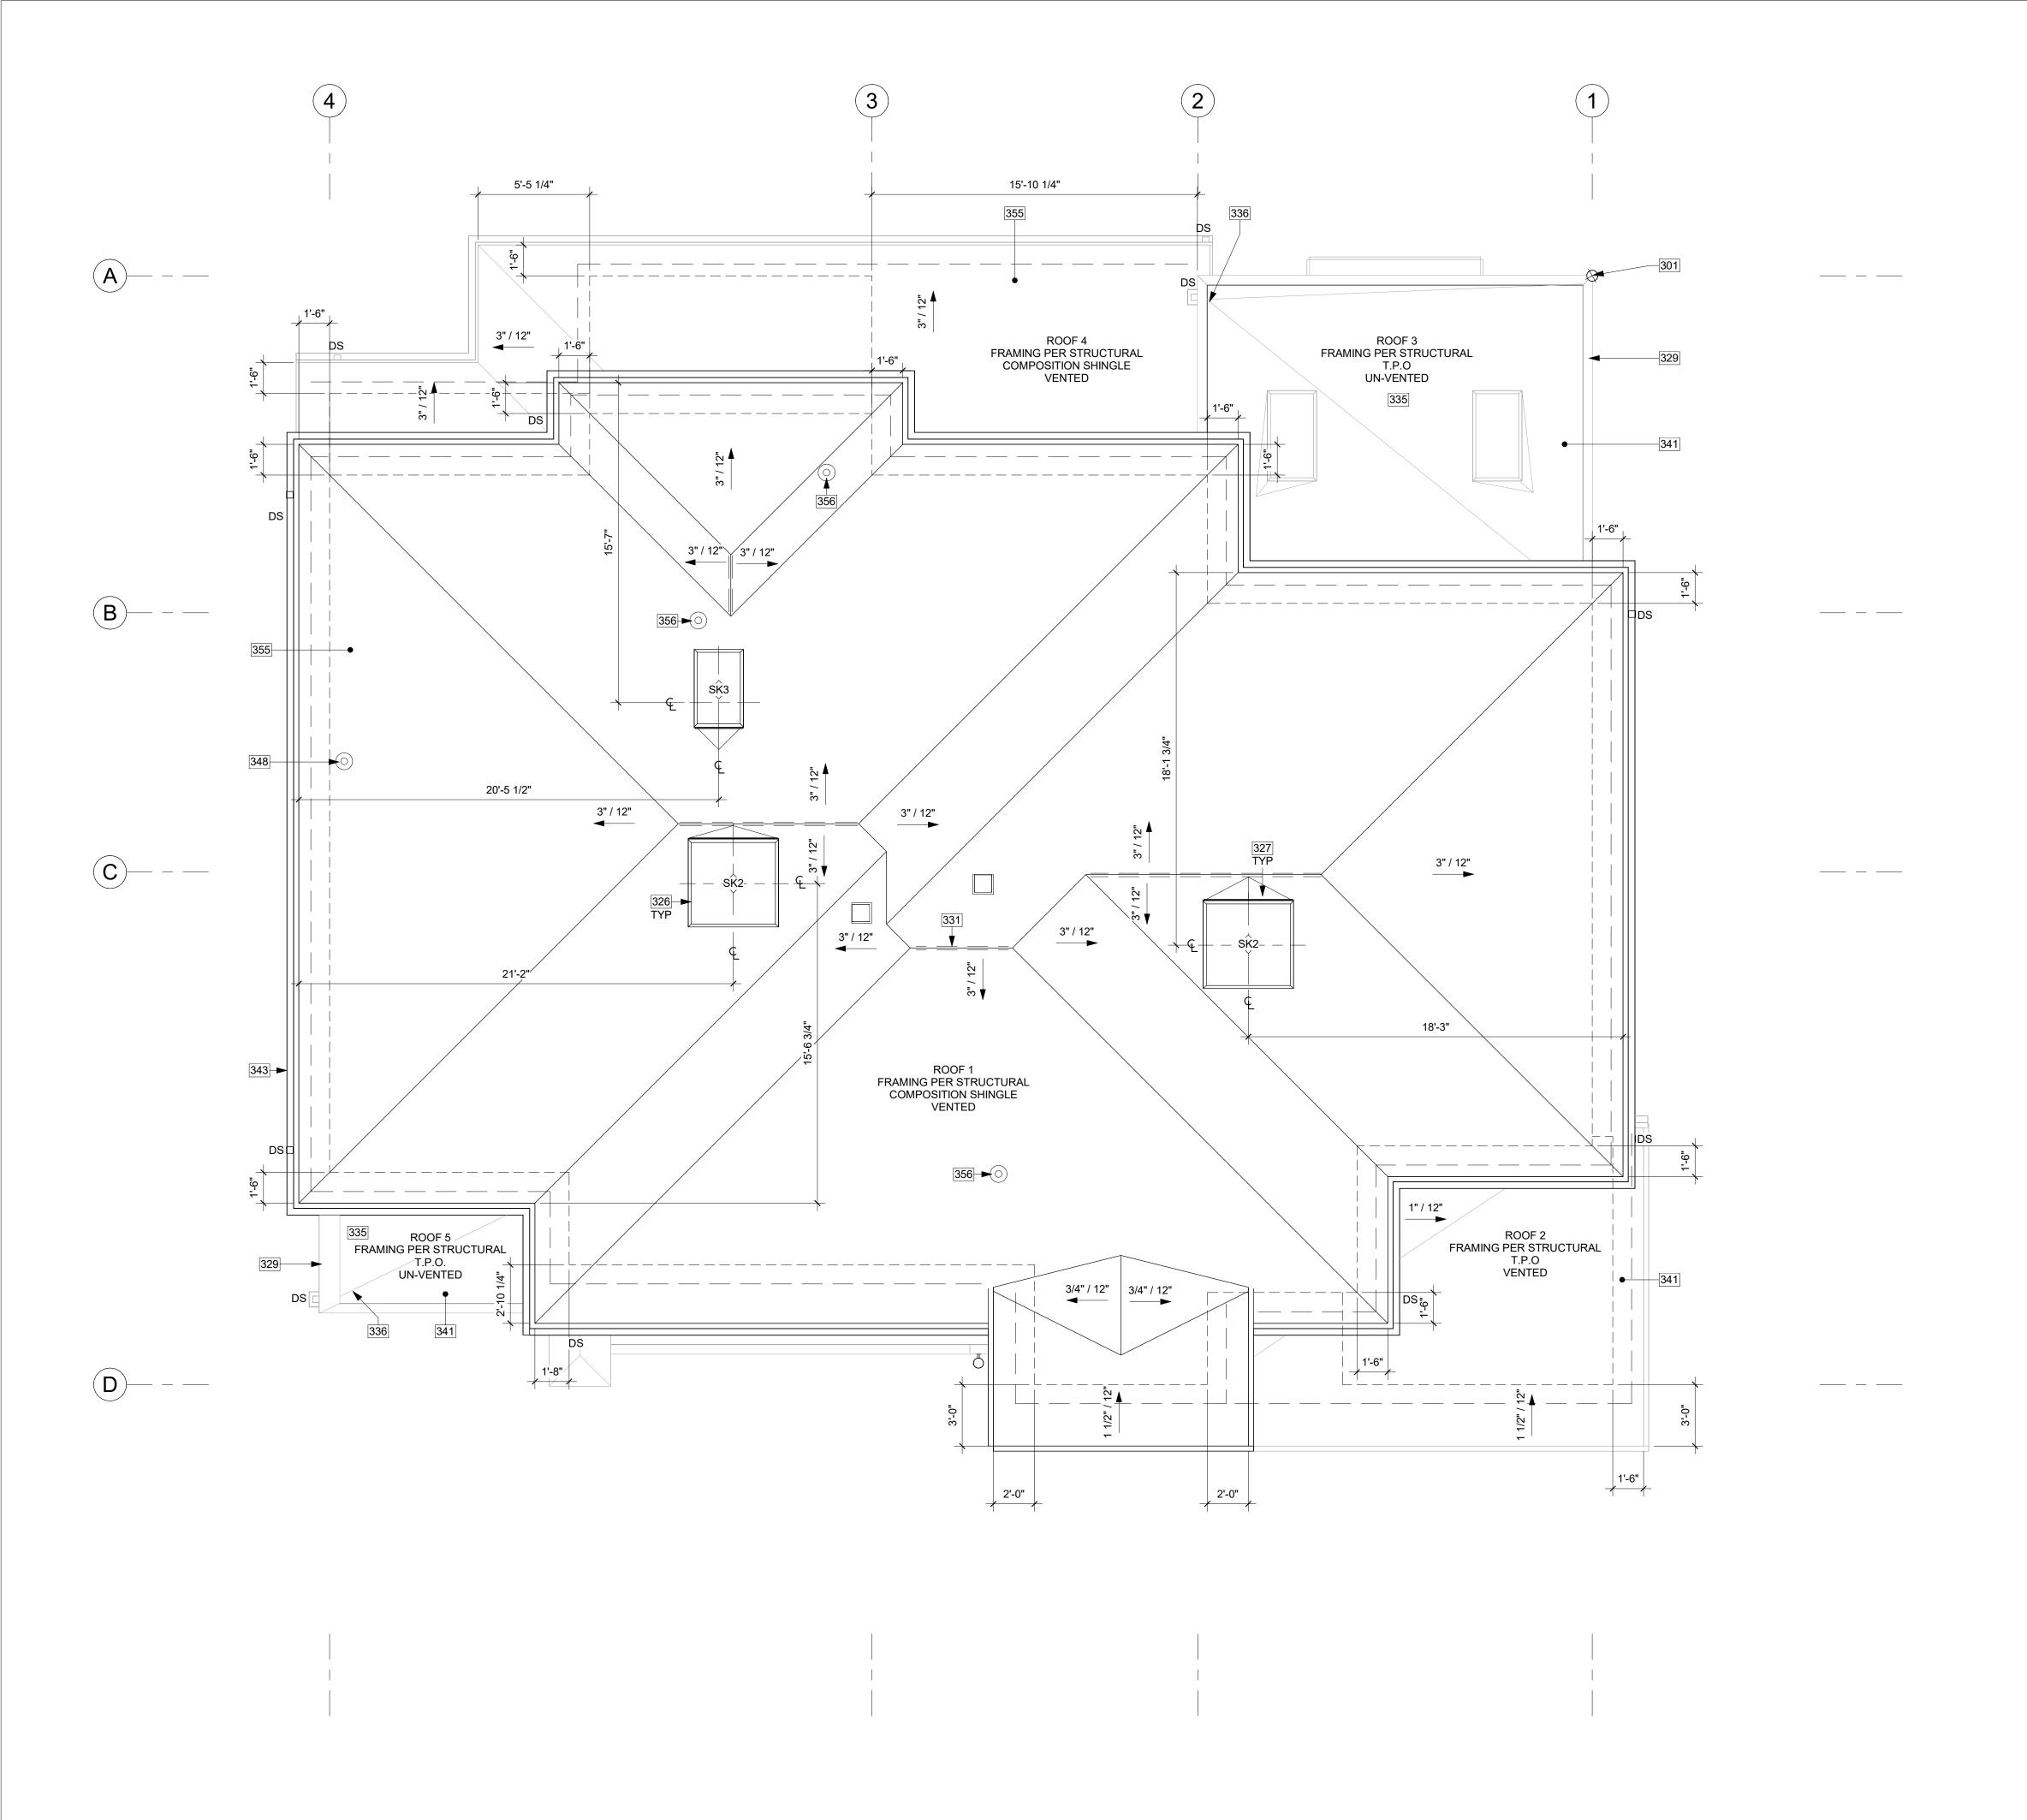

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INTAKE DATE:	04/22/2022
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PROJECT / CLIENT:

LYNNWOOD HOUSE 1

TRIAD HOLDINGS

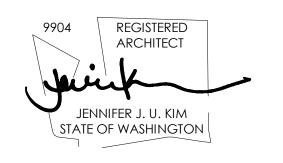PROJECT ADDRESS: 3515 169TH AVE SW LYNNWOOD, WA 98037

SYMBOL LEGEND

_ = =	RIDGE VENT
	EAVE VENT
	BUILDING BEL
	ROOF HAT VEI

ROOF VENTILATION

ROOF 1		
ROOF CONSTRUCTION:	PARALLEL CHORD TRUSSES	
ROOF AREA:	2,229.36 SF	
VENTILATION REQUIRED:	(2,229.36 SF x 144 SI) / 150*	= 2,140.19 SI REQUIRE
PROPOSED VENTILATION:		
(4) 2-1/2" DIA. HOLES PER 24":	9.8 SI / LF - 25%	= 7.35 SI / LF
PROVIDE:	217.54 LF EAVE VENTILATION	= 1,598.92 SI
2" WIDE RIDGE VENT:	18 SI / LF	= 18 SI / LF
PROVIDE:	27.08 LF RIDGE VENTILATION	= 487.44 SI
ROOF HAT VENT:	50 SI / VENT	= 50 SI / VENT
PROVIDE:	2 ROOF HAT VENTS	= 100 SI
TOTAL MIN. VENTILATION PRO	OVIDED = 2,186.36 SI IS GREATE	R THAN 2,140.19 REQ.
ROOF 2		
ROOF CONSTRUCTION:	PARALLEL CHORD TRUSSES	
ROOF AREA:	148.55 SF	
VENTILATION REQUIRED:	(148.55 SF x 144 SI) / 150*	= 142.61 SI REQUIRED
PROPOSED VENTILATION:		
(4) 2-1/2" DIA. HOLES PER 24":	9.8 SI / LF - 25%	= 7.35 SI / LF
PROVIDE:	32.5 LF EAVE VENTILATION	
TOTAL MIN. VENTILATION PRO	OVIDED = 238.88 SI IS GREATER	R THAN 142.61 REQ.
ROOF 4		
ROOF CONSTRUCTION:	PARALLEL CHORD TRUSSES	
ROOF AREA:	142.91 SF	
VENTILATION REQUIRED:	(142.91 SF x 144 SI) / 150*	= 137.19 SI REQUIRED
PROPOSED VENTILATION:		
(4) 2-1/2" DIA. HOLES PER 24":	9.8 SI / LF - 25%	= 7.35 SI / LF
PROVIDE:	48.5 LF EAVE VENTILATION	
	2//DED = 250 40 01 10 ODE ATER	

(4) 2-1/2" DIA. HOLES PER 24": 9.8 SI / LF - 25% = 7.35 SI / LF
PROVIDE: 48.5 LF EAVE VENTILATION = 356.48 SI

TOTAL MIN. VENTILATION PROVIDED = 356.48 SI IS GREATER THAN 137.19 REQ.

* PER IRC R806.2, MINIMUM NET FREE VENTILATION AREA SHALL BE 1/150 OF THE AREA. AS AN ALTERNATIVE, THE NET FREE CROSS VENTILATION AREA MAY BE REDUCED TO 1/300 WHEN BETWEEN 40-50% OF REQUIRED VENTILATION AREA IS LOCATED IN THE UPPER PORTION OF ROOF, PER IRC SECTION R806.2.2

DRAWING NAME:

ROOF PLAN

DRAWN BY: KKH
CHECKED By: JK

PHASE:

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APPROVED FOR CONSTRUCTION:

PROJECT No.: A21 068

DATE: 6/13/2023





MAX. ALLOWED HEIGHT 142.63

LINE OF EXISTING GRADE.
 LINE OF FOOTING BEYOND.
 LANDINGS OR FINISHED FLOORS AT REQUIRED EGRESS DOORS SHALL NOT BE MORE THAN 1-1/2" LOWER THAN THE TOP OF THE THRESHOLD.
 VINYL WINDOWS PER SCHEDULE. SAFETY GLAZING AND EGRESS WHERE NOTED.
 LIGHTING AT ALL EXTERIOR DOORS, TYP. PROVIDE BACKING FOR ATTACHMENT.
 TIGHT KNOT CEDAR T&G SOFFIT WITH 4" EXPOSURE, SEAL & STAIN ALL SIDES AND ALL CUTS BEFORE INSTALLING, TYP. PROVIDE 2-INCH CONTINUOUS STRIP SOFFIT VENT.
 FIBER CEMENT PANEL, RAINSCREEN, PAINTED. NOTE: ALL FIBER CEMENT

PANEL DIVISIONS TO ALIGN WITH WINDOWS AS SHOWN, TYP. NOTE:
PAINTABLE XOCR TAMLYN SPLINE TO MATCH PANEL COLOR, TYP.

466 FIBER CEMENT PLANK, HORIZONTAL LAP SIDING WITH 6" EXPOSURE, PAINTED
COLOR TRD. TYP. NOTE: PAINTABLE YOCR TAMLYN SPLINE TO MATCH PANEL

- COLOR TBD, TYP. NOTE: PAINTABLE XOCR TAMLYN SPLINE TO MATCH PANEL COLOR, TYP.

468 FIBER CEMENT PANEL INFILL, PAINTED; MATCH WINDOW COLOR

468 FIBER CEMENT PANEL INFILL, PAINTED; MATCH WINDOW COLOR
469 STONE VENEER, DRY STACK.

470 ASPHALT SHINGLE ROOF. ROOFING SYSTEM PER SRC R905.2.
 472 4" SQUARE GUTTER OVER 2X6 OVER 2X10 STEPED FASCIA, PRIMED,

FINGER-JOINTED CEDAR FASCIA BOARD.

2X10 OVER 2X16 STEPED PAINTED WOOD FASCIA, COLOR BLACK, WITH 20 GA. POWDER COATED METAL FLASHING WITH CONTINUOUS CLEAT.

474 2X10 PRIMED, FINGER-JOINTED CEDAR FASCIA BOARD.
 475 POWDER-COATED SCUPPER AND 4" SQUARE DOWNSPOUT. TIGHTLINE ALL DOWNSPOUTS TO STORMWATER SYSTEM, PER CIVIL.

476 4" SQUARE DOWNSPOUT. TIGHTLINE ALL DOWNSPOUTS TO STORMWATER SYSTEM, PER CIVIL.

477 20 GA., POWDER COATED METAL COPING. PROVIDE CONTINUOUS STRIP VENT PER DETAILS, TYP.
 480 STOVE & COOKTOP HOOD VENT TERMINATION. VERIFY 3'-0" MINIMUM

CLEARANCE FROM GLAZING.

481 GAS FIREPLACE DIRECT VENT. VERIFY 3'-0" MINIMUM CLEARANCE FROM

482 EXHAUST VENT. VERIFY 3'-0" MINIMUM CLEARANCE FROM GLAZING.
483 HOT WATER HEATER VENT TERMINATION. VERIFY 3'-0" MINIMUM CLEARANCE

FROM GLAZING.

490 SKYLIGHT PER SCHEDULE, TYP. INSTALL WITH CURB AND FLASHING PER

STRUCTURAL AND MANUFACTURER.

492 HRV FRESH AIR INTAKE. VERIFY 3' FROM EXHAUST AIR VENT.

493 HRV EXHAUST AIR VENT. VERIFY 3' FROM FRESH AIR INTAKE.

MEDICI ARCHITECTS

11711 SE 8TH STREET 200 W. RIVER ST. SUITE 100 SUITE 301
BELLEVUE, WA 98005 KETCHUM, ID 83340
TEL: (425) 453-9298 TEL: (208) 726-0194

REGISTRATION:

INTAKE DATE:



04/22/2022

REVISIONS: DATE:

PROJECT / CLIENT:

LYNNWOOD HOUSE 1

TRIAD HOLDINGS

PROJECT ADDRESS: 3515 169TH AVE SW LYNNWOOD, WA 98037

DRAWING NAME:

ELEVATIONS

DRAWN BY: KKH
CHECKED By: JK

DLIACE

ADU LAND USE

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APPROVED FOR CONSTRUCTION:

PROJECT No.: A21 068

DATE: 6/13/2023

PLOT SCALE: 1:1


ELEVATION NOTES

- VERIFY SHEAR WALL NAILING & HOLDOWNS PER STRUCTURAL PLAN & SCHEDULE PRIOR TO INSTALLING SIDING.
- 2. WOOD SIDING SEAL & STAIN ALL SIDES BEFORE INSTALLING AND @ ALL
- CUTS.

 3. WEATHER PROTECTION. EXTERIOR WALLS SHALL PROVIDE THE BUILDING WITH A WEATHER-RESISTANT EXTERIOR WALL ENVELOPE. THE EXTERIOR WALL ENVELOPE SHALL INCLUDE FLASHING AND BE CONSTRUCTED IN SUCH A MANNER AS TO PREVENT THE ACCUMULATION OF WATER WITHIN THE WALL ASSEMBLY BY PROVIDING A WATER-RESISTIVE BARRIER BEHIND THE EXTERIOR VENEER AND A MEANS FOR DRAINING WATER THAT ENTERS THE ASSEMBLY TO THE EXTERIOR. PROTECTION AGAINST CONDENSATION IN THE EXTERIOR WALL ASSEMBLY SHALL BE PROVIDED.
- PER IRC R703.8. FLASHING AT WALLS. FLASHING SHALL BE INSTALLED IN SUCH A MANNER SO AS TO PREVENT MOISTURE FROM ENTERING THE WALL OR TO REDIRECT THAT MOISTURE TO THE EXTERIOR. FLASHING SHALL BE INSTALLED AT THE PERIMETERS OF EXTERIOR DOOR AND WINDOW ASSEMBLIES, PENETRATIONS AND TERMINATIONS OF EXTERIOR WALL ASSEMBLIES, EXTERIOR WALL INTERSECTIONS WITH ROOFS, CHIMNEYS, PORCHES, DECKS, BALCONIES AND SIMILAR PROJECTIONS AND AT BUILT-IN GUTTERS AND SIMILAR LOCATIONS WHERE MOISTURE COULD ENTER THE WALL. FLASHING WITH PROJECTING FLANGES SHALL BE INSTALLED ON BOTH SIDES AND THE ENDS OF COPINGS, UNDER SILLS AND
- CONTINUOUSLY ABOVE PROJECTING *TRIM*.
 PROVIDE FLASHING AT ROOF PENETRATIONS PER IRC R903.2.1. FLASHING SHALL BE INSTALLED AT WALL AND ROOF INTERSECTIONS, AT GUTTERS, WHEREVER THERE IS A CHANGE IN ROOF SLOPE OR DIRECTION AND AROUND ROOF OPENINGS. WHERE FLASHING IS OF METAL, THE METAL SHALL BE CORROSION RESISTANT.
- PROVIDE CONTINUOUS GUTTERS & DOWNSPOUTS AT EAVES PER PLANS,
 TYP.
 PROVIDE WEATHER STRIPPING AT ALL EXTERIOR & GARAGE DOORS.
- CAULK ALL EXTERIOR JOINTS & PENETRATIONS.

 8. WINDOWS AND DOORS SHALL BE INSTALLED IN ACCORDANCE WITH
- APPROVED MANUFACTURER'S INSTRUCTIONS.

 9. SEE SHEET A0.2 FOR ADDITIONAL NOTES.

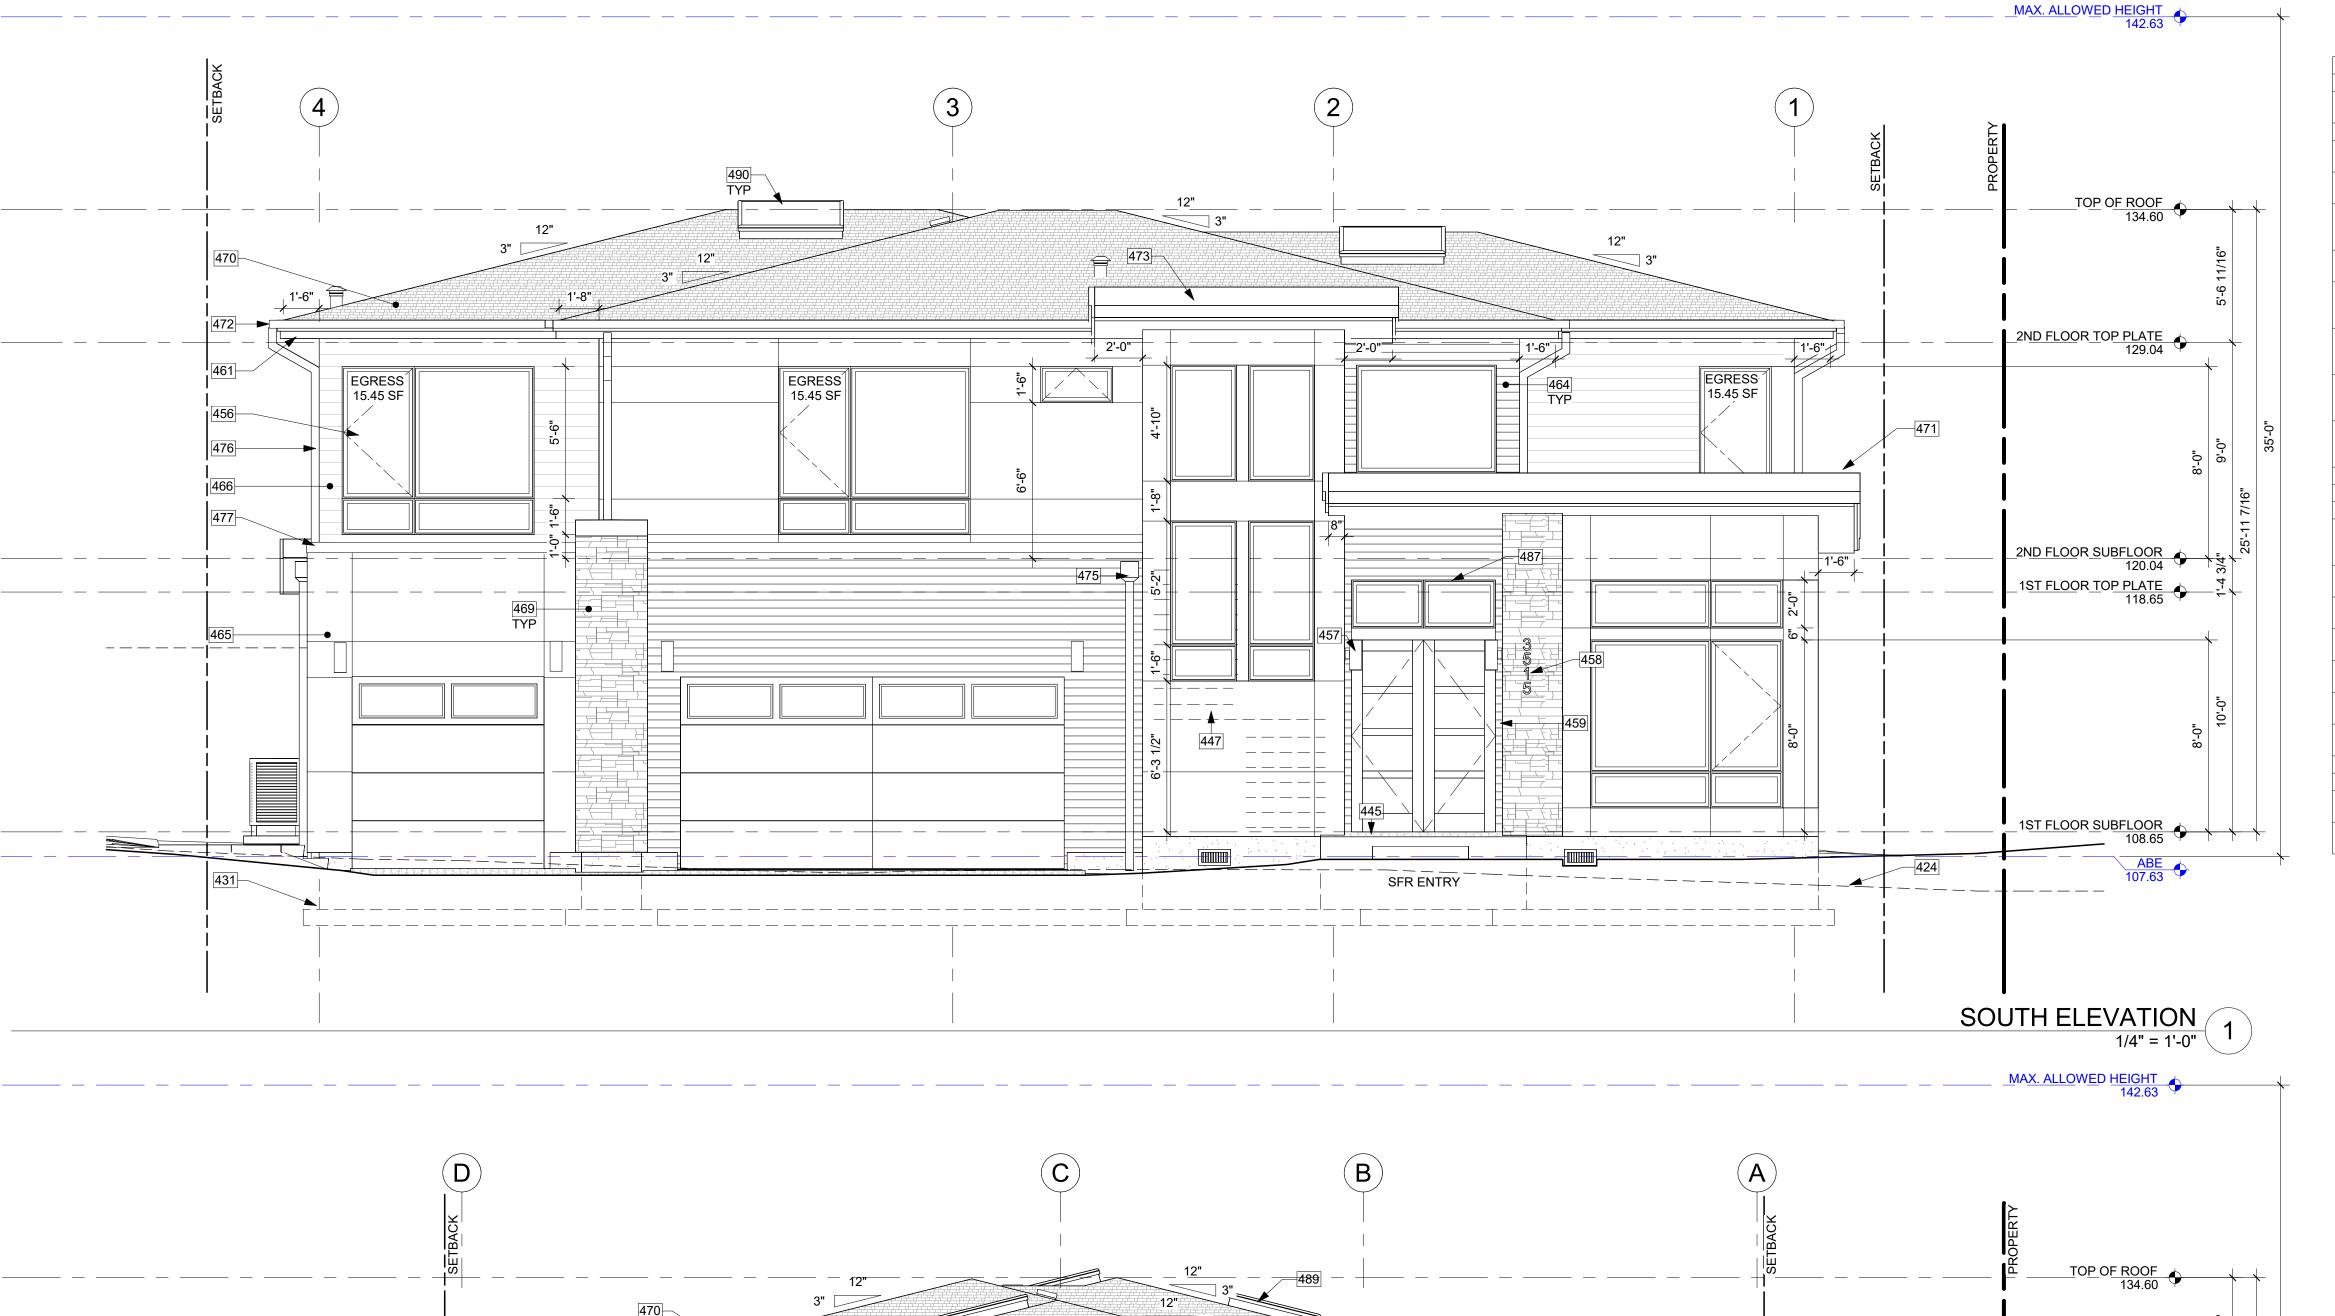

TO THE CONTROL OF THE

KEY NOTES

424 LINE OF EXISTING GRADE.

THAN 4:12.

431 LINE OF FOOTING BEYOND.

LANDINGS OR FINISHED FLOORS AT REQUIRED EGRESS DOORS SHALL NOT BE MORE THAN 1-1/2" LOWER THAN THE TOP OF THE THRESHOLD.

LINE OF STAIRS AT EXTERIOR WALL.

VINYL WINDOWS PER SCHEDULE. SAFETY GLAZING AND EGRESS WHERE

LIGHTING AT ALL EXTERIOR DOORS, TYP. PROVIDE BACKING FOR ATTACHMENT.

LOCATION OF HOUSE ADDRESS OR NUMBER TO BE PLAINLY VISIBLE AND LEGIBLE FROM THE STREET, SIZE 6" HEIGHT - FONT - HELVETICA - DARK

DOORBELL "O" BUTTON LED ILLUMINATED POLYCARBONATE BASE & ALUMINUM FRONT - MATCH WINDOW COLOR.
 TIGHT KNOT CEDAR T&G SOFFIT WITH 4" EXPOSURE, SEAL & STAIN ALL SIDES

AND ALL CUTS BEFORE INSTALLING, TYP. PROVIDE 2-INCH CONTINUOUS STRIP SOFFIT VENT.

TIGHT KNOT CEDAR T&G SIDING WITH 4" EXPOSURE, SEAL & STAIN ALL SIDES

AND ALL CUTS BEFORE INSTALLING. INSTALL OVER FURRING STRIPS TO
MATCH ADJACENT DEPTH OF SIDING MATERIALS.

FIBER CEMENT PANEL, RAINSCREEN, PAINTED. NOTE: ALL FIBER CEMENT

PAINTABLE XOCR TAMLYN SPLINE TO MATCH PANEL COLOR, TYP.

466 FIBER CEMENT PLANK, HORIZONTAL LAP SIDING WITH 6" EXPOSURE, PAINTED - COLOR TBD, TYP. NOTE: PAINTABLE XOCR TAMLYN SPLINE TO MATCH PANEL

PANEL DIVISIONS TO ALIGN WITH WINDOWS AS SHOWN, TYP. NOTE:

COLOR, TYP.

468 FIBER CEMENT PANEL INFILL, PAINTED; MATCH WINDOW COLOR
469 STONE VENEER, DRY STACK.

 470 ASPHALT SHINGLE ROOF. ROOFING SYSTEM PER SRC R905.2.
 471 TPO ROOFING INSTALLED PER MANUFACTURER. PER TABLE R905.1.1(2), DOUBLE LAYER OF UNDERLAYMENT REQUIRED IF ROOF PITCH IS SHALLOWER

4" SQUARE GUTTER OVER 2X6 OVER 2X10 STEPED FASCIA, PRIMED,

FINGER-JOINTED CEDAR FASCIA BOARD.

473 2X10 OVER 2X16 STEPED PAINTED WOOD FASCIA, COLOR BLACK, WITH 20 GA.

POWDER COATED METAL FLASHING WITH CONTINUOUS CLEAT.

475 POWDER-COATED SCUPPER AND 4" SQUARE DOWNSPOUT. TIGHTLINE ALL

DOWNSPOUTS TO STORMWATER SYSTEM, PER CIVIL.

476 4" SQUARE DOWNSPOUT. TIGHTLINE ALL DOWNSPOUTS TO STORMWATER SYSTEM, PER CIVIL.

477 20 GA., POWDER COATED METAL COPING. PROVIDE CONTINUOUS STRIP VENT PER DETAILS, TYP.

480 STOVE & COOKTOP HOOD VENT TERMINATION. VERIFY 3'-0" MINIMUM

CLEARANCE FROM GLAZING.

482 EXHAUST VENT. VERIFY 3'-0" MINIMUM CLEARANCE FROM GLAZING.

487 ALIGN WINDOW AND DOOR JAMBS.

489 2X6 WOOD-FRAMED WRAPPED BY STONE VENEER PARAPET WITH STONE CAP FLASHING.
 490 SKYLIGHT PER SCHEDULE, TYP. INSTALL WITH CURB AND FLASHING PER

STRUCTURAL AND MANUFACTURER.

MEDICI ARCHITECTS

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TEL: (425) 453-9298 TEL: (208) 726-0194

REGISTRATION:

INTAKE DATE:



04/22/2022

REVISIONS:		DATE:	

PROJECT / CLIENT:

LYNNWOOD HOUSE 1

TRIAD HOLDINGS

PROJECT ADDRESS: 3515 169TH AVE SW LYNNWOOD, WA 98037

DRAWING NAME:

ELEVATIONS

DRAWN BY: KKH
CHECKED By: JK

DLIACE

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APPROVED FOR CONSTRUCTION:

PROJECT No.: A21 068

DATE: 6/13/2023

PLOT SCALE: 1:1

ELEVATION NOTES

EAST ELEVATION
1/4" = 1'-0"
2

- 1. VERIFY SHEAR WALL NAILING & HOLDOWNS PER STRUCTURAL PLAN & SCHEDULE PRIOR TO INSTALLING SIDING.
- . WOOD SIDING SEAL & STAIN ALL SIDES BEFORE INSTALLING AND @ ALL
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 3. WEATHER PROTECTION, EXTERIOR WALLS SHALL PROVIDE THE BUILDING WITH A WEATHER-RESISTANT EXTERIOR WALL ENVELOPE. THE EXTERIOR WALL ENVELOPE SHALL INCLUDE FLASHING AND BE CONSTRUCTED IN SUCH A MANNER AS TO PREVENT THE ACCUMULATION OF WATER WITHIN THE WALL ASSEMBLY BY PROVIDING A WATER-RESISTIVE BARRIER BEHIND THE EXTERIOR VENEER AND A MEANS FOR DRAINING WATER THAT ENTERS THE ASSEMBLY TO THE EXTERIOR. PROTECTION AGAINST CONDENSATION IN THE EXTERIOR WALL ASSEMBLY SHALL BE PROVIDED.
 - PER IRC R703.8. FLASHING AT WALLS. FLASHING SHALL BE INSTALLED IN SUCH A MANNER SO AS TO PREVENT MOISTURE FROM ENTERING THE WALL OR TO REDIRECT THAT MOISTURE TO THE EXTERIOR. FLASHING SHALL BE INSTALLED AT THE PERIMETERS OF EXTERIOR DOOR AND WINDOW ASSEMBLIES, PENETRATIONS AND TERMINATIONS OF EXTERIOR WALL ASSEMBLIES, EXTERIOR WALL INTERSECTIONS WITH ROOFS, CHIMNEYS, PORCHES, DECKS, BALCONIES AND SIMILAR PROJECTIONS AND AT BUILT-IN GUTTERS AND SIMILAR LOCATIONS WHERE MOISTURE COULD ENTER THE WALL. FLASHING WITH PROJECTING FLANGES SHALL BE INSTALLED ON BOTH SIDES AND THE ENDS OF COPINGS, UNDER SILLS AND
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 PROVIDE FLASHING AT ROOF PENETRATIONS PER IRC R903.2.1. FLASHING SHALL BE INSTALLED AT WALL AND ROOF INTERSECTIONS, AT GUTTERS, WHEREVER THERE IS A CHANGE IN ROOF SLOPE OR DIRECTION AND AROUND ROOF OPENINGS. WHERE FLASHING IS OF METAL, THE METAL SHALL BE CORROSION RESISTANT.
- PROVIDE CONTINUOUS GUTTERS & DOWNSPOUTS AT EAVES PER PLANS, TYP.
 PROVIDE WEATHER STRIPPING AT ALL EXTERIOR & GARAGE DOORS.
- CAULK ALL EXTERIOR JOINTS & PENETRATIONS.


 8. WINDOWS AND DOORS SHALL BE INSTALLED IN ACCORDANCE WITH
- APPROVED MANUFACTURER'S INSTRUCTIONS.

 SEE SHEET A0.2 FOR ADDITIONAL NOTES.



PERSPECTIVE 1




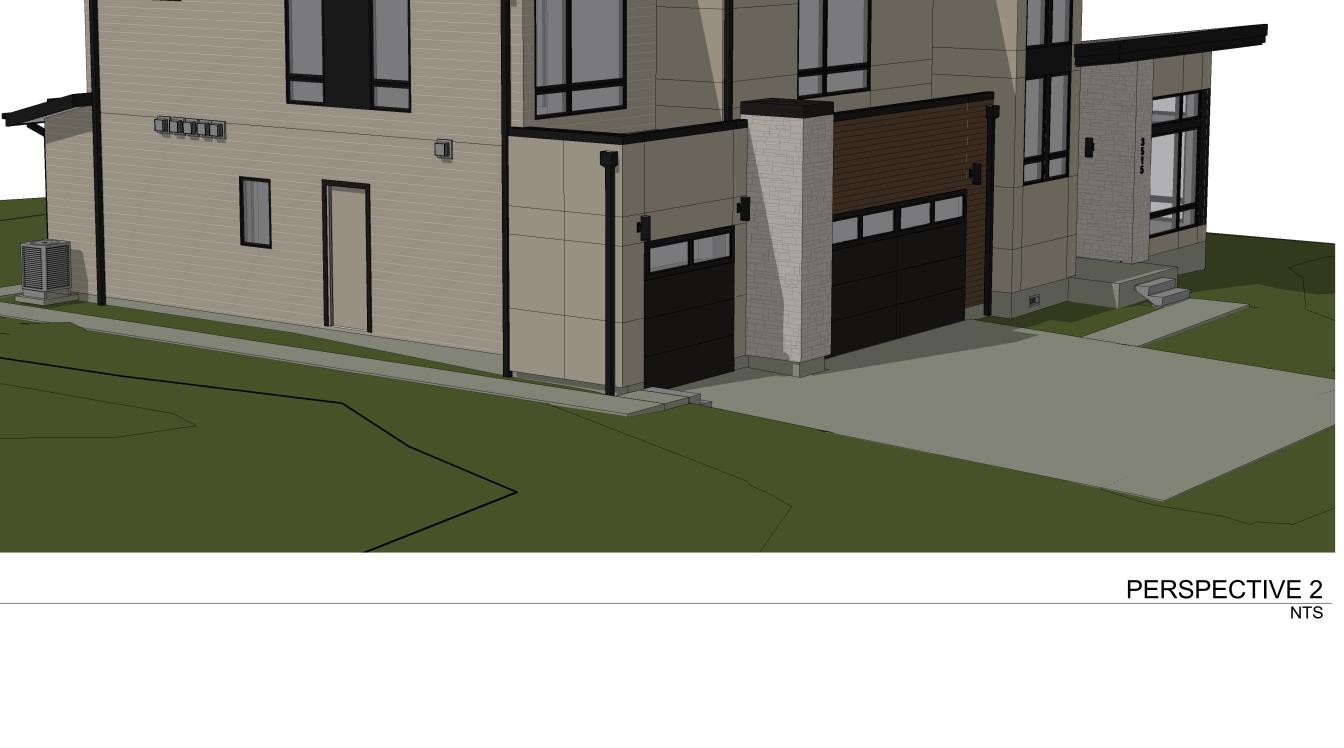

PERSPECTIVE 3




NOTE: 3D RENDERINGS ARE FOR ILLUSTRATIVE PURPOSES ONLY. NOT TO BE USED FOR CONSTRUCTION.

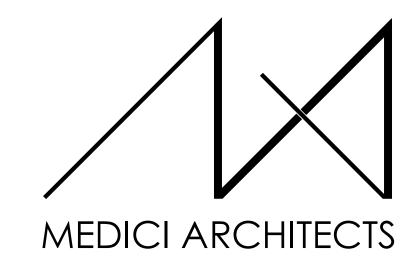

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200 W. RIVER ST. SUITE 301 KETCHUM, ID 83340 TEL: (208) 726-0194

REGISTRATION:

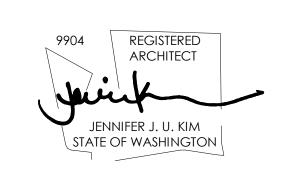

INTA	KE DATE:	(04/22/2022
REVI	SIONS:	ſ	DATE:

PROJECT / CLIENT:

LYNNWOOD HOUSE 1

TRIAD HOLDINGS

PROJECT ADDRESS: 3515 169TH AVE SW LYNNWOOD, WA 98037

DRAWING NAME:

PERSPECTIVES

DRAWN BY: KKH CHECKED By: JK


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NORTH ELEVATION - MATERIALS/COLORS 1/4" = 1'-0" 1

1AX. ALLOWED HEIGHT 142.63






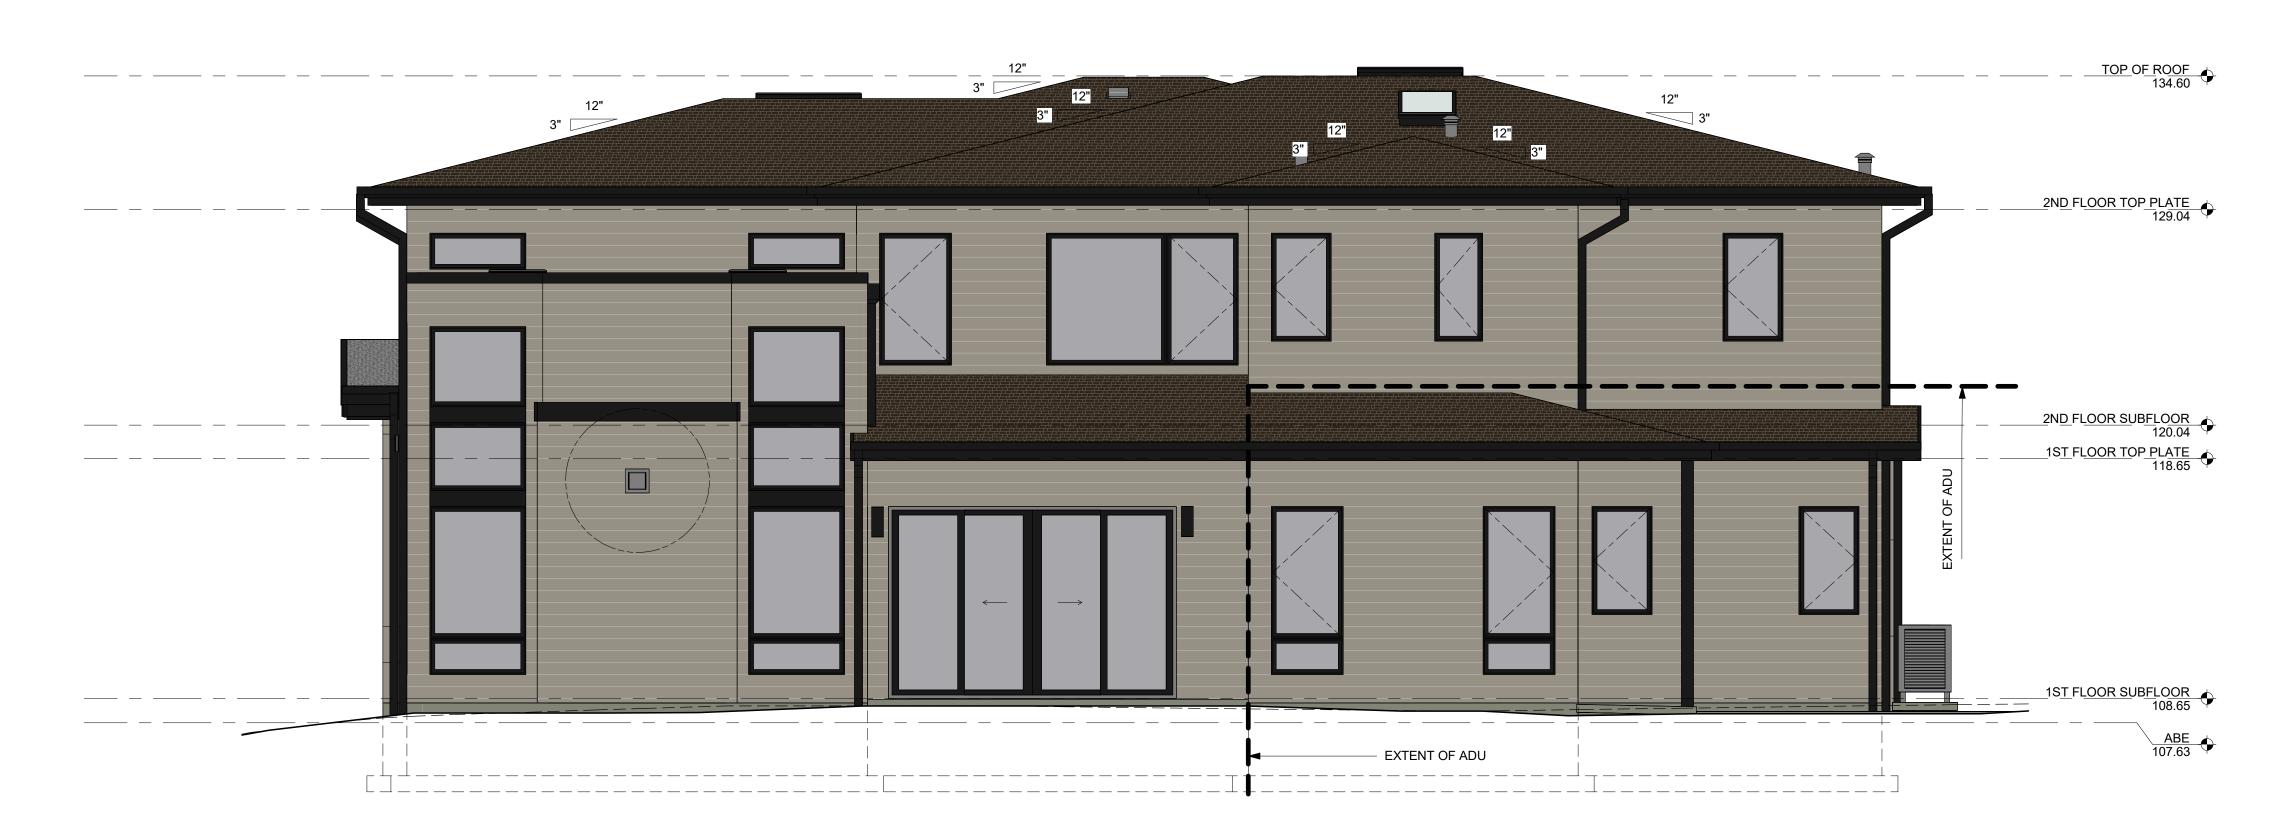

• GAF BARKWOOD OR SIMILAR



FIBER CEMENT LAP SIDINGSMOOTH TEXTURE, 7" REVEAL

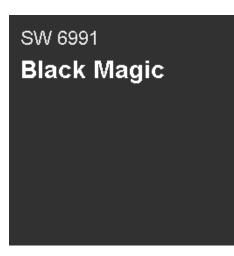

FIBER CEMENT PANEL SIDINGSMOOTH TEXTURE



VINYL WINDOW


DARK BRONZE EXTERIOR FINISH



STONE VENEER (SFR ONLY)EL DORADO CLIFFSTONE BOARDWALK OR SIMILAR




 STAINED CEDAR (SFR ONLY)
 SHERWIN WILLIAMS 3532 HILL COUNTRY OR SIMILAR

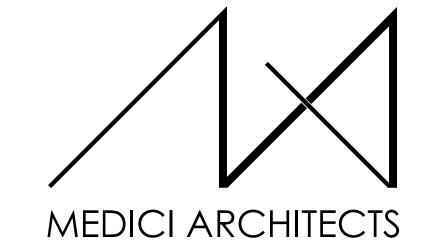

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SUITE 100 SUITE 301
BELLEVUE, WA 98005 KETCHUM, ID 83340
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REGISTRATION:

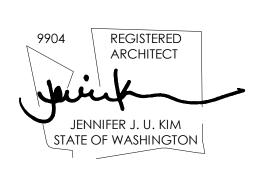

REVISIONS: DATE:

2 CLIENT CHANGES 3/7/2023

PROJECT / CLIENT:

LYNNWOOD HOUSE 1

TRIAD HOLDINGS

PROJECT ADDRESS: 3515 169TH AVE SW LYNNWOOD, WA 98037

ELEVATIONS MATERIALS/COLORS

DRAWN BY: KKH
CHECKED By: JK

PHASE:

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DATE: 6/13/2023

A4.3



SOUTH ELEVATION - MATERIALS/COLORS
1/4" = 1'-0"
1

MAX. ALLOWED HEIGHT 142.63

ADU NOT VISIBLE IN THESE ELEVATIONS, BUT SHOWN FOR MATERIAL REFERENCE OF MAIN STRUCTURE







• GAF BARKWOOD OR SIMILAR



FIBER CEMENT LAP SIDINGSMOOTH TEXTURE, 7" REVEAL



• SMOOTH TEXTURE



VINYL WINDOW


DARK BRONZE EXTERIOR FINISH



STONE VENEER (SFR ONLY)EL DORADO CLIFFSTONE BOARDWALK OR SIMILAR




STAINED CEDAR (SFR ONLY)
 SHERWIN WILLIAMS 3532 HILL COUNTRY OR SIMILAR

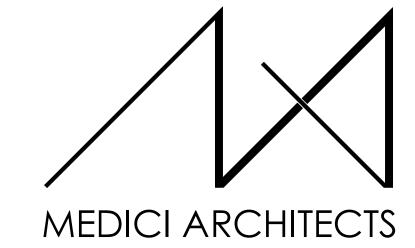

11711 SE 8TH STREET 200 W. RIVER ST. SUITE 301 KETCHUM, ID 83340 SUITE 100 BELLEVUE, WA 98005 TEL: (425) 453-9298 TEL: (208) 726-0194

REGISTRATION:

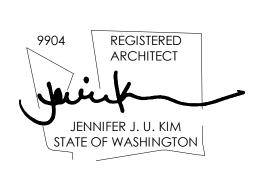

04/22/2022 INTAKE DATE: **REVISIONS**: DATE: CORRECTION LETTER 7/7/2022

PROJECT / CLIENT: LYNNWOOD HOUSE 1

TRIAD HOLDINGS

PROJECT ADDRESS: 3515 169TH AVE SW LYNNWOOD, WA 98037

DRAWING NAME: **ELEVATIONS -**MATERIALS/COLORS DRAWN BY: KKH

ADU LAND USE

CHECKED By: JK

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